


PROJECT DATA


Algiere Design &

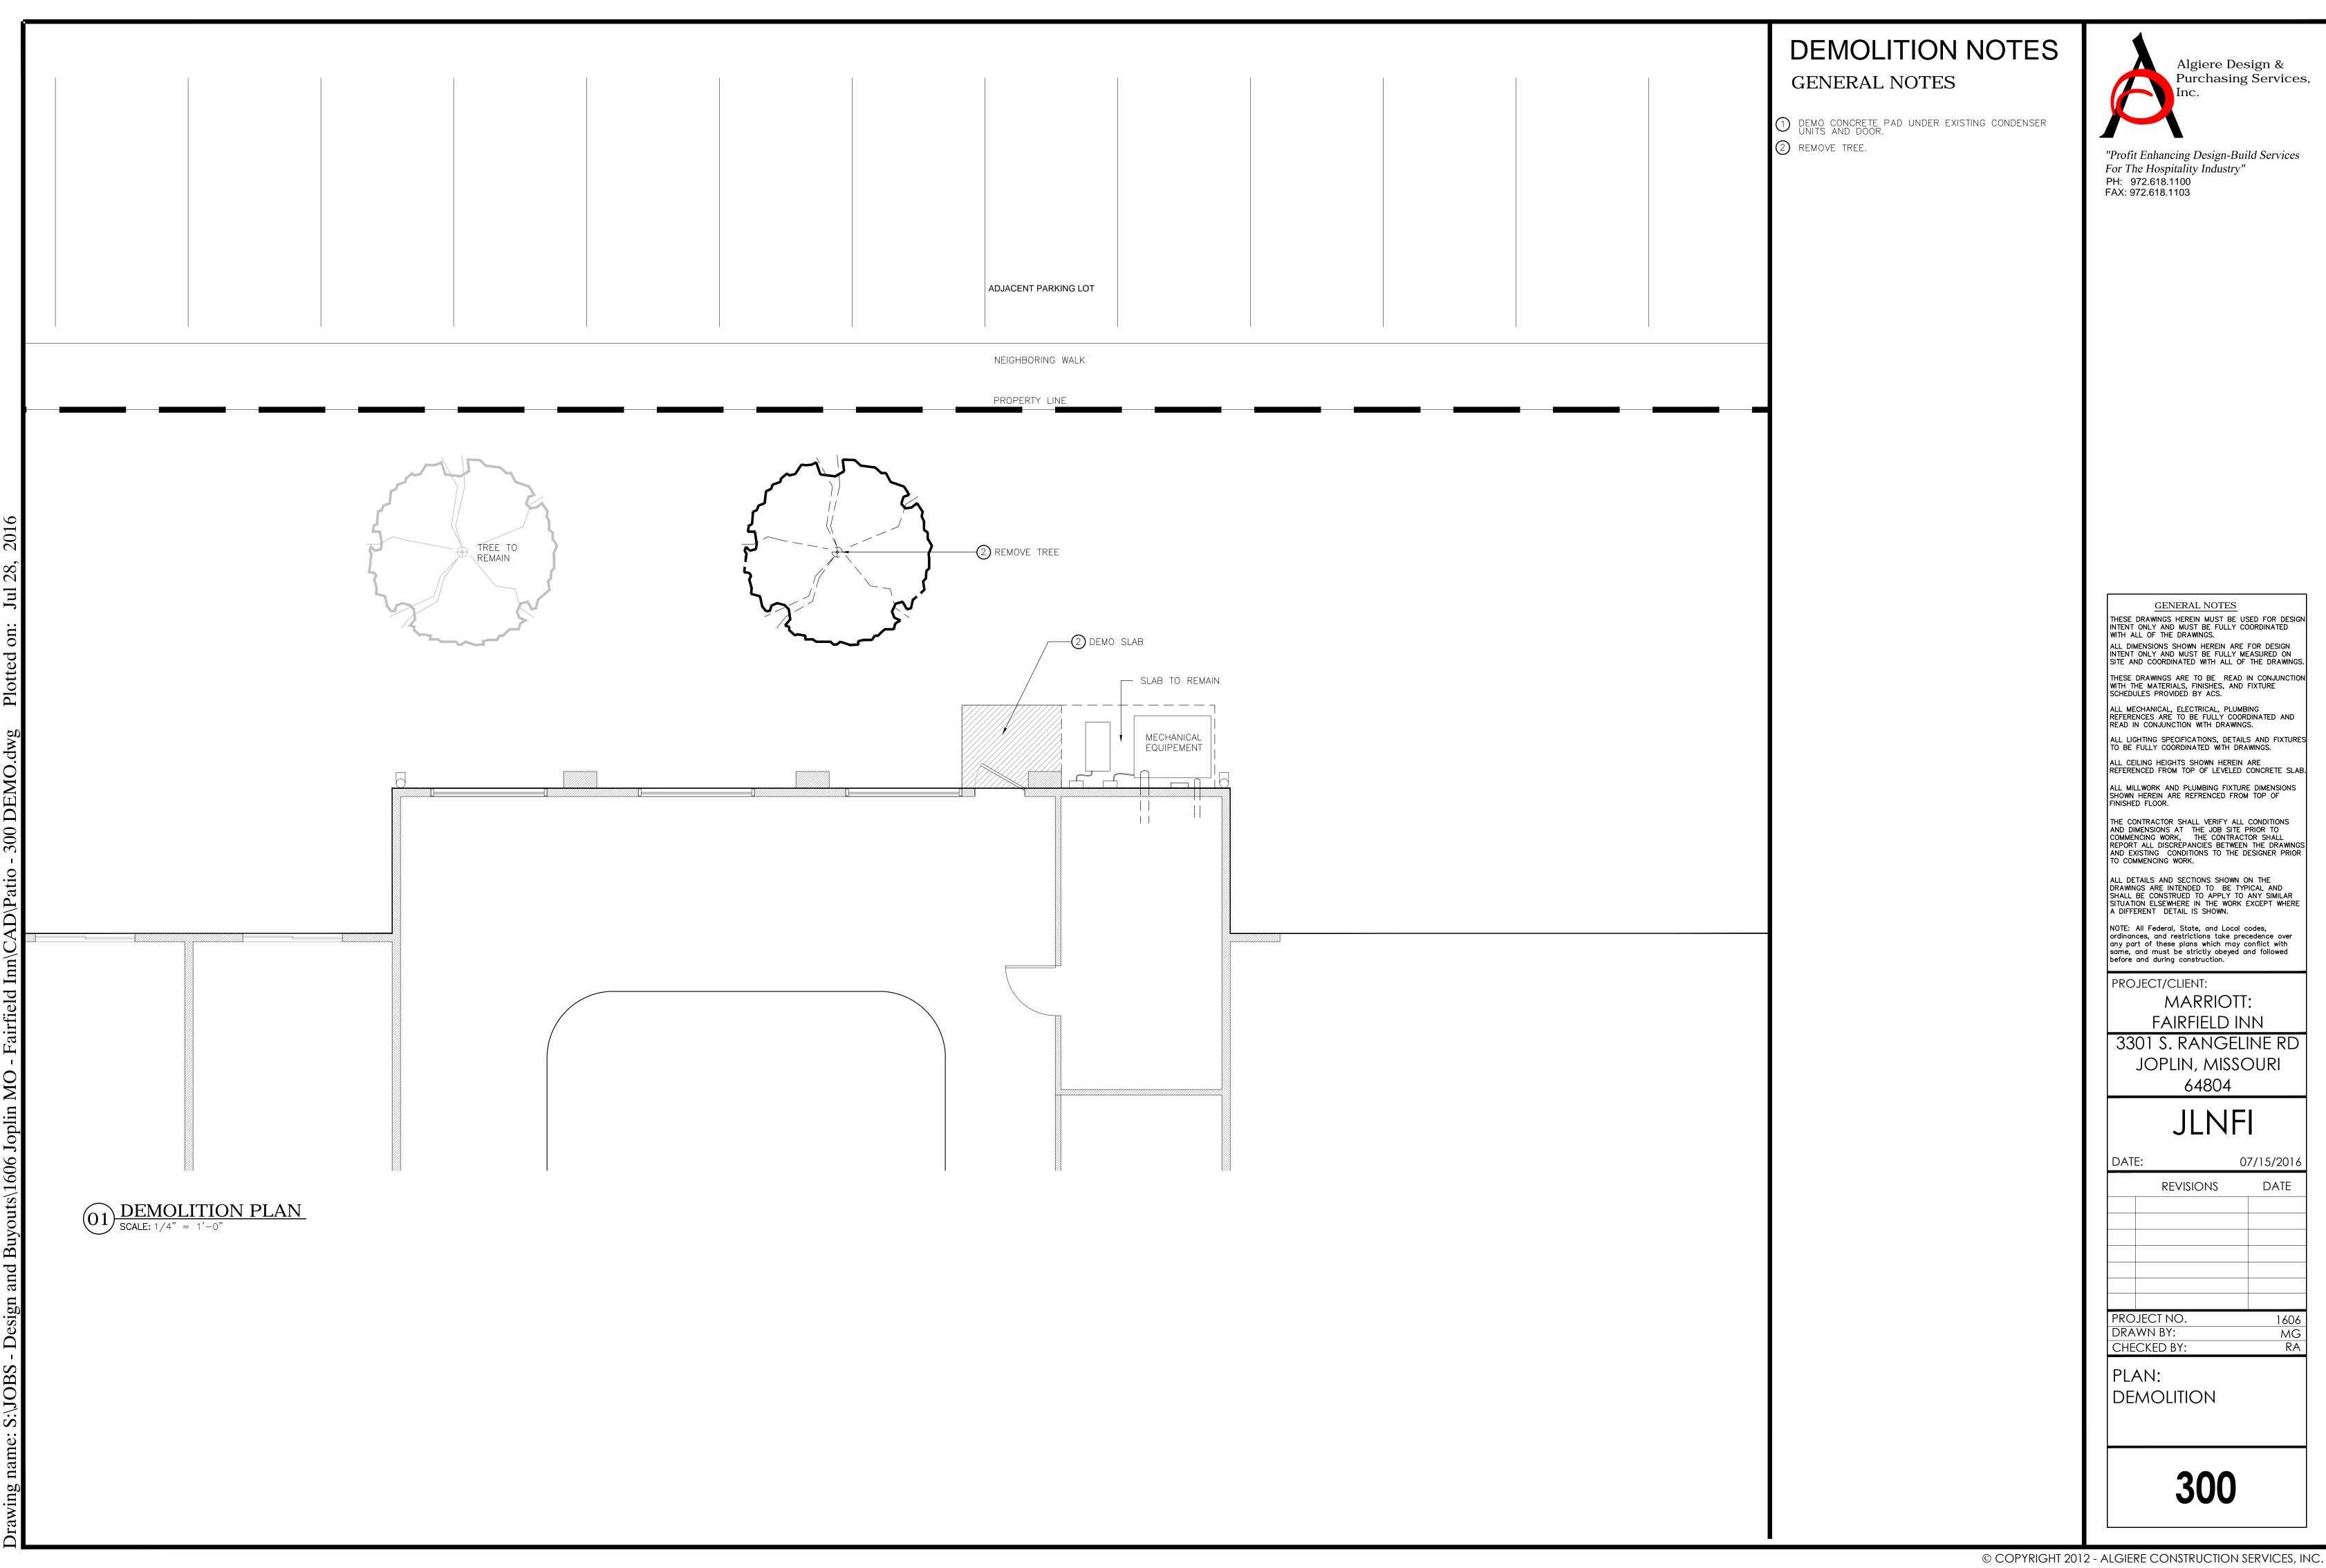


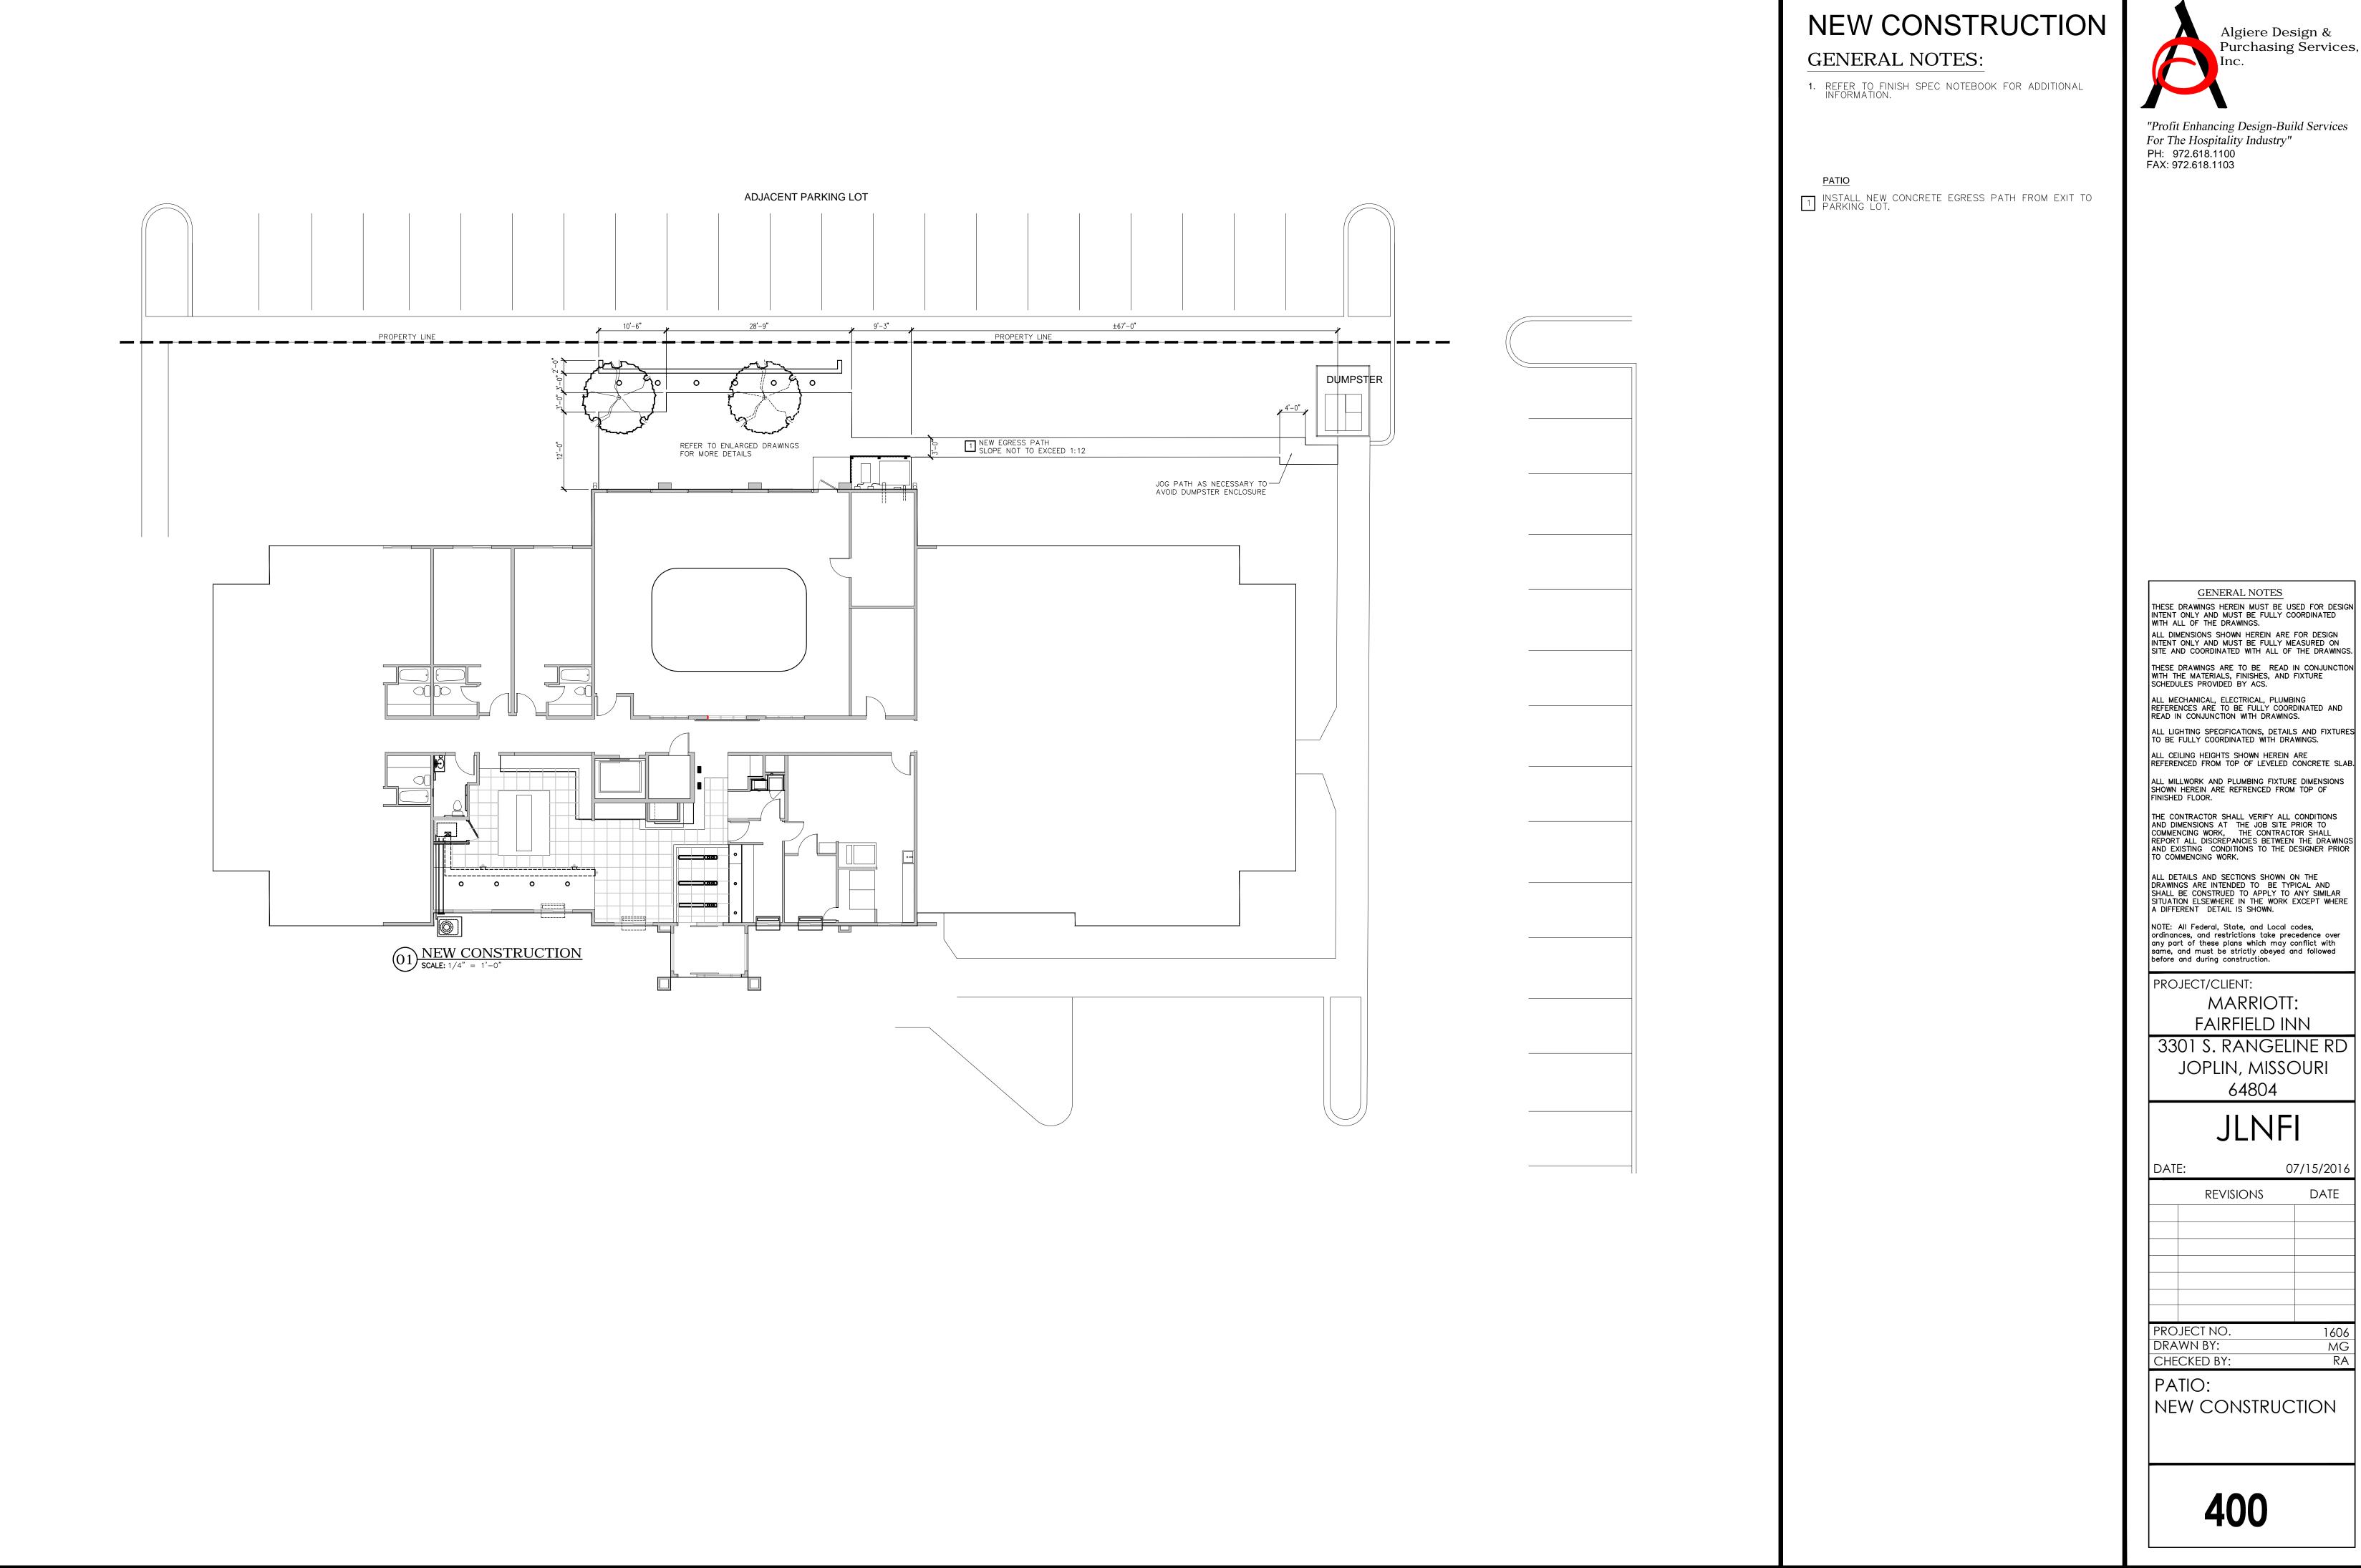

© COPYRIGHT 2012 - ALGIERE CONSTRUCTION SERVICES, INC.

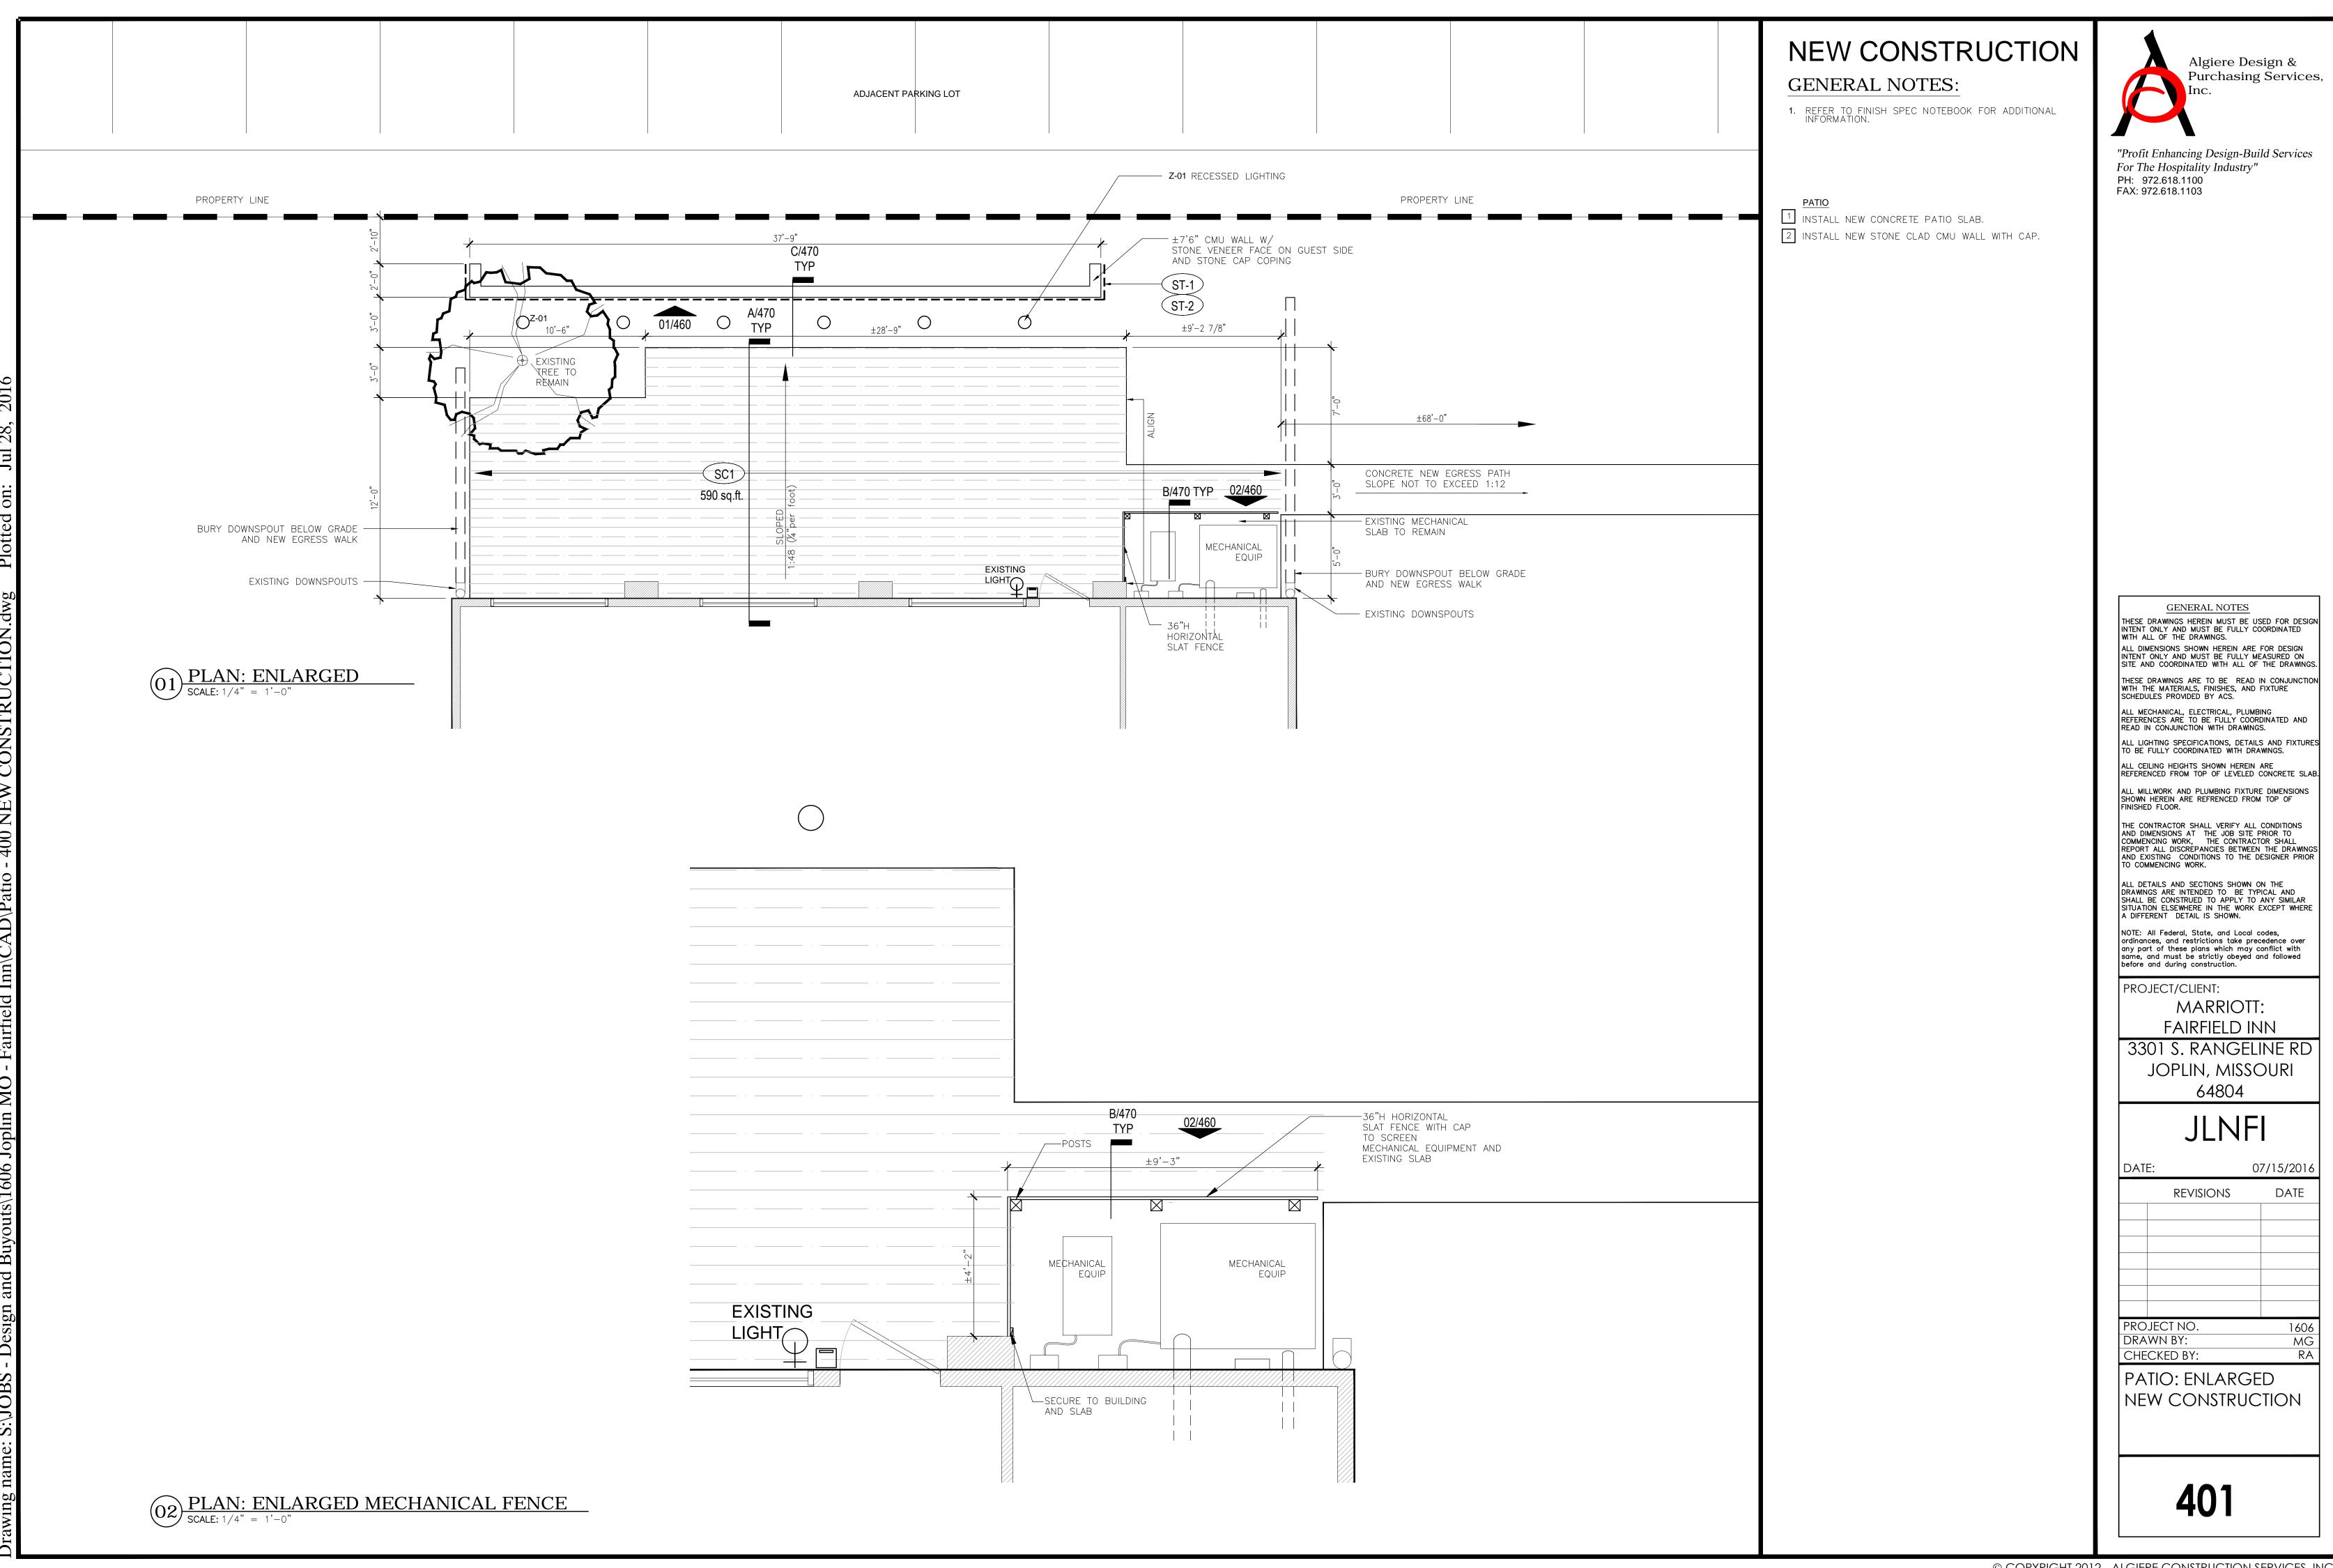

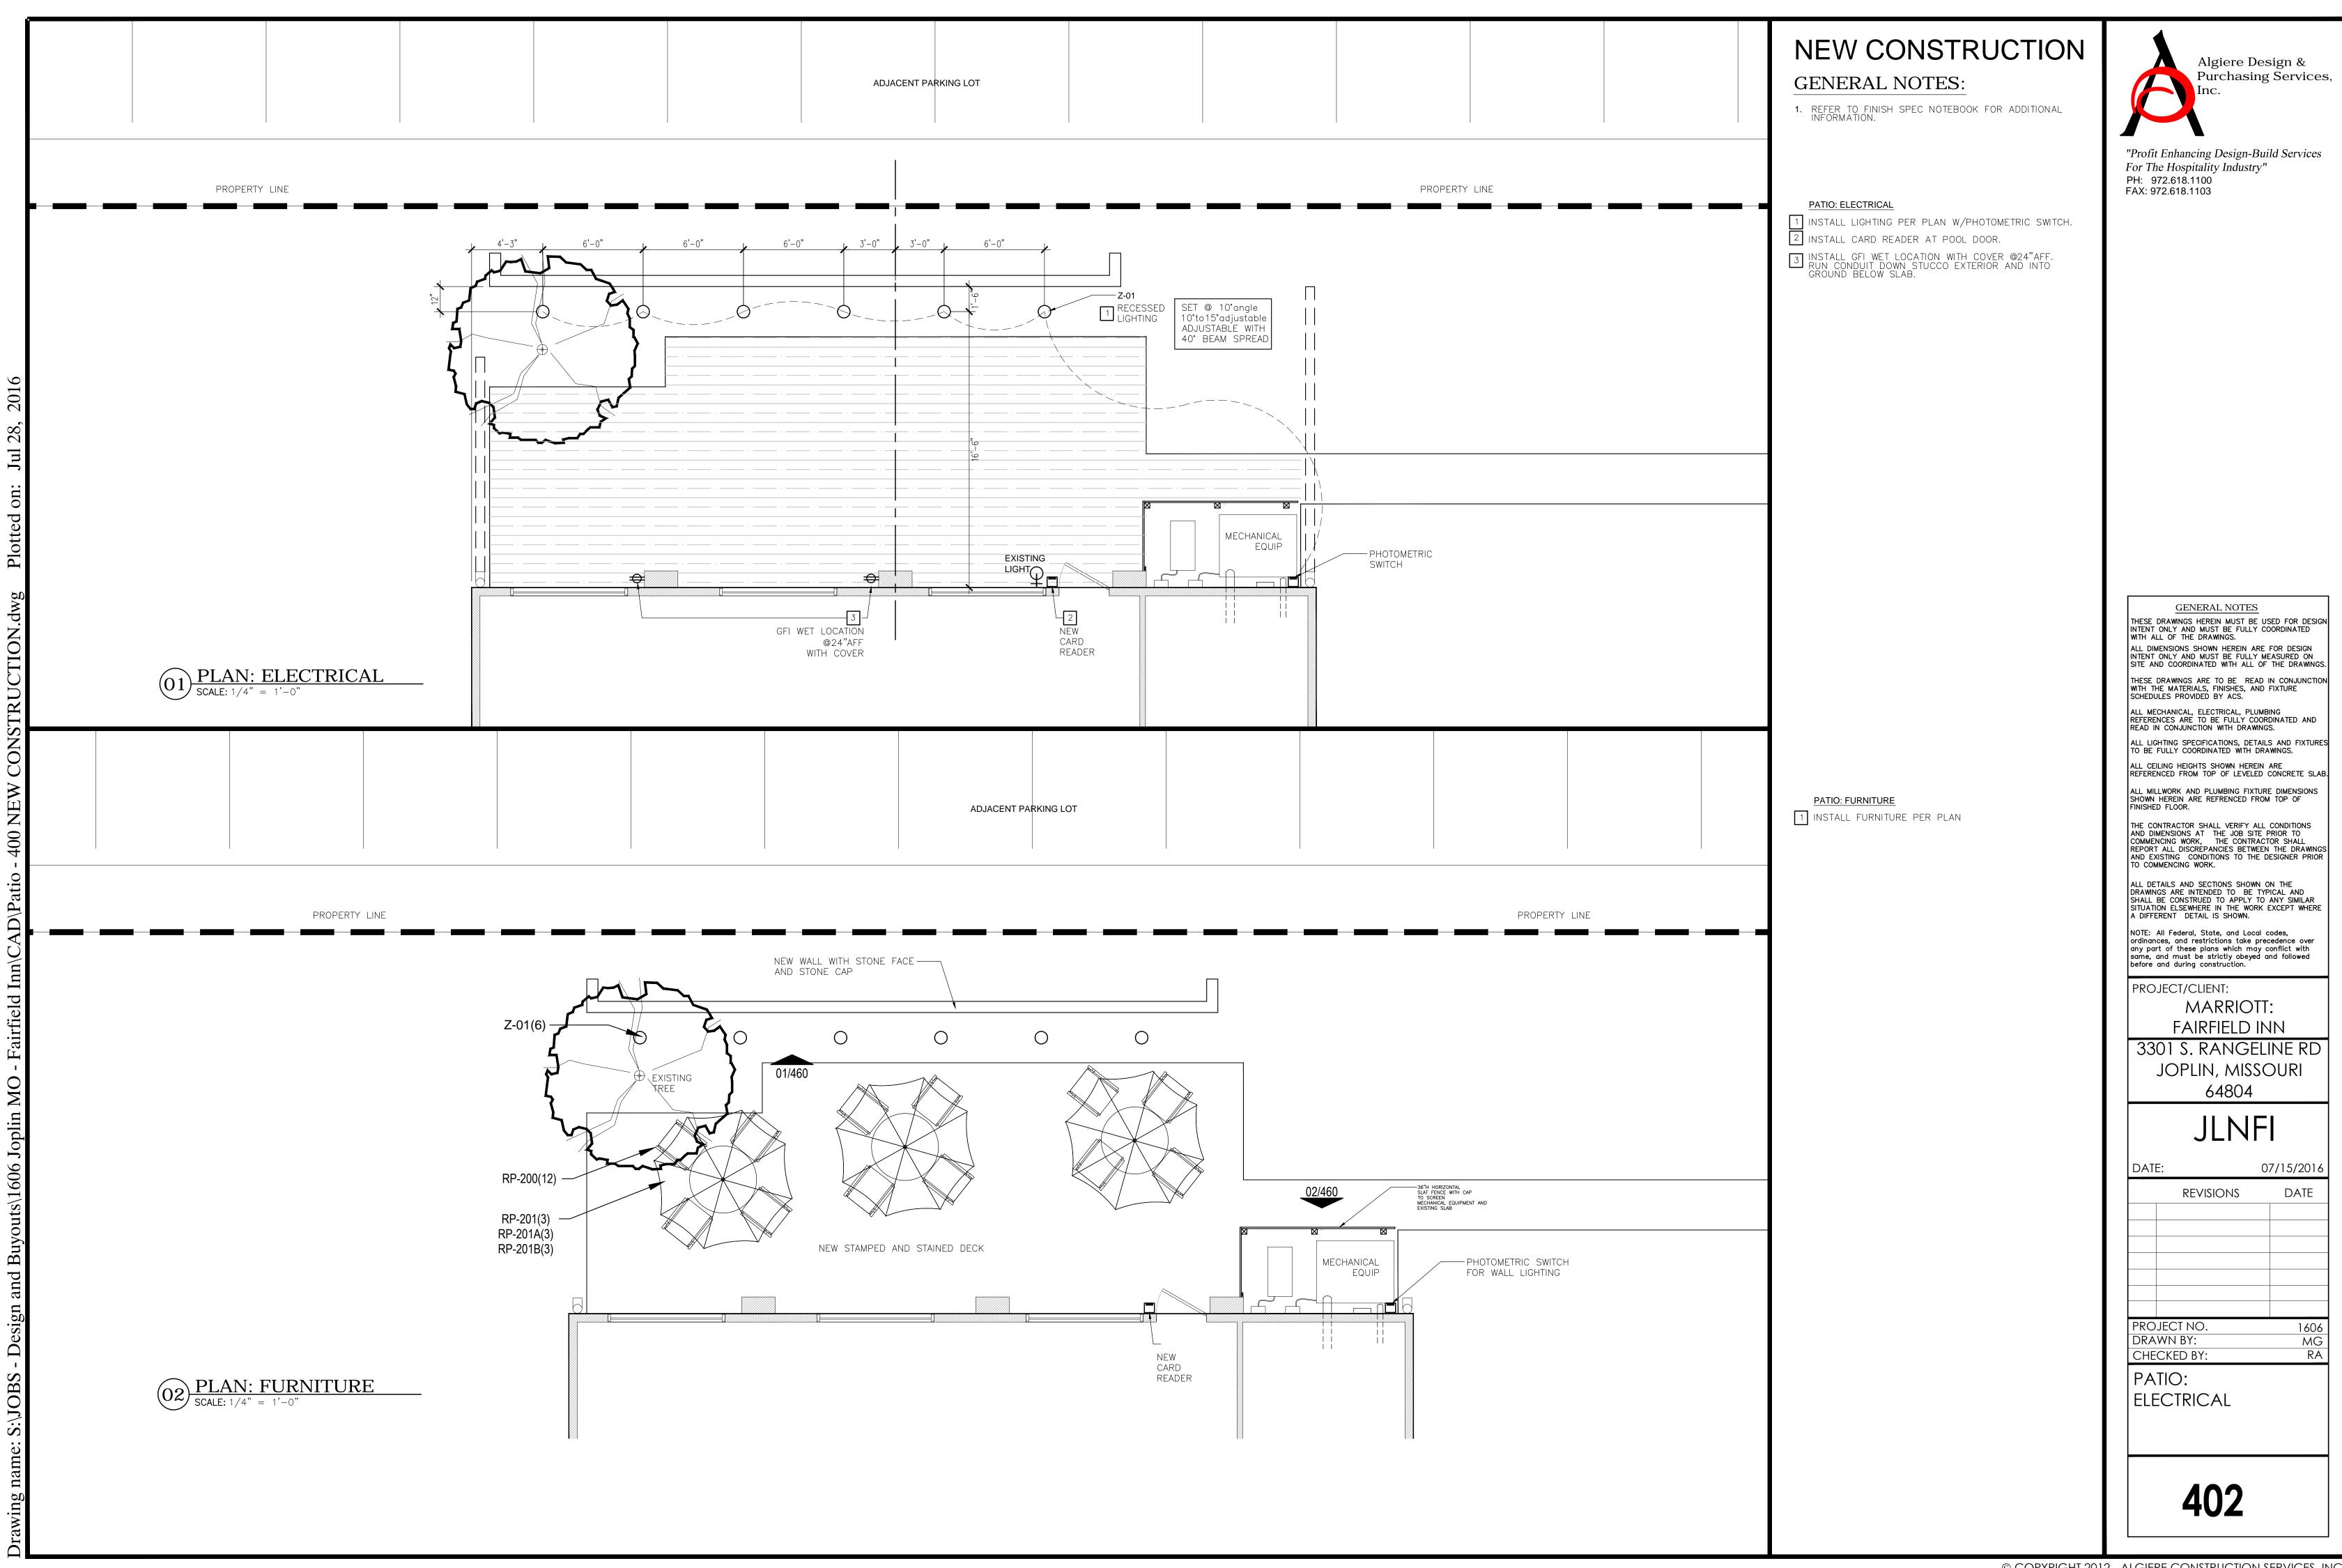

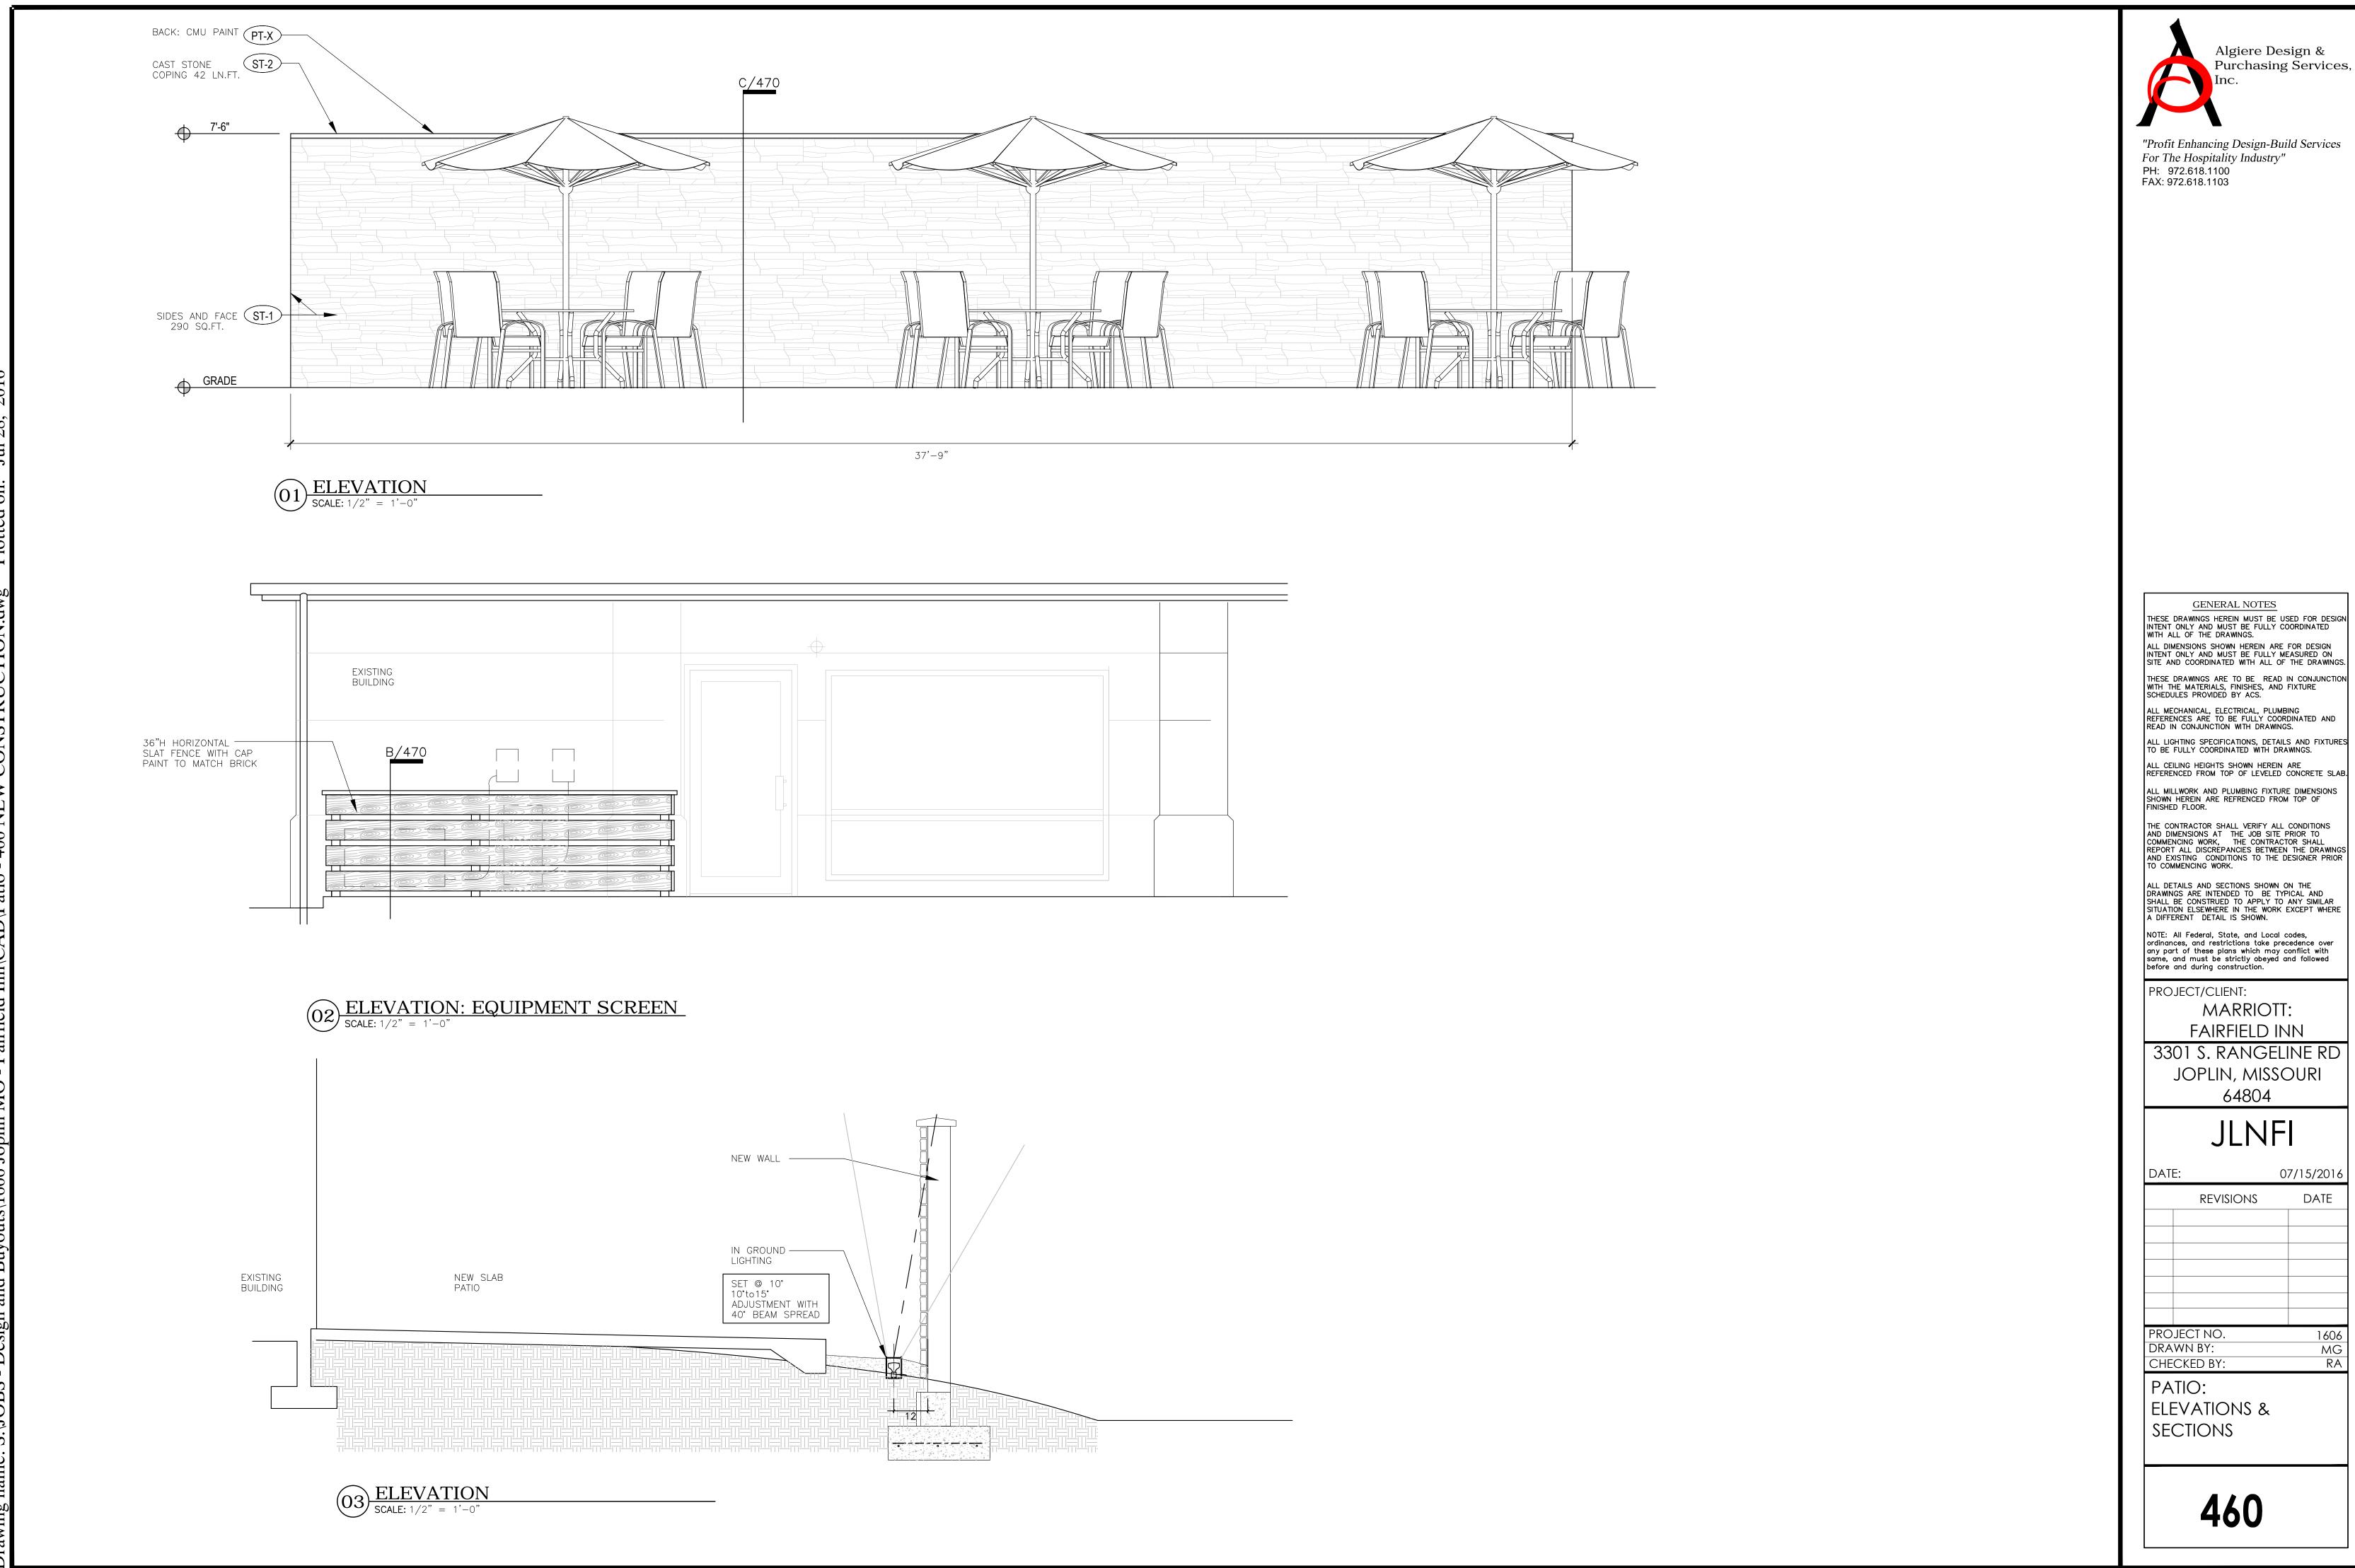

DATE

Algiere Design & Purchasing Services, "Profit Enhancing Design-Build Services For The Hospitality Industry" PH: 972.618.1100 FAX: 972.618.1103 STONE CAP -CMU BOND BM. -W/#5 CONTINOUS GENERAL NOTES THESE DRAWINGS HEREIN MUST BE USED FOR DESIGN INTENT ONLY AND MUST BE FULLY COORDINATED WITH ALL OF THE DRAWINGS. ALL DIMENSIONS SHOWN HEREIN ARE FOR DESIGN INTENT ONLY AND MUST BE FULLY MEASURED ON SITE AND COORDINATED WITH ALL OF THE DRAWINGS. THESE DRAWINGS ARE TO BE READ IN CONJUNCTION WITH THE MATERIALS, FINISHES, AND FIXTURE SCHEDULES PROVIDED BY ACS. ALL MECHANICAL, ELECTRICAL, PLUMBING REFERENCES ARE TO BE FULLY COORDINATED AND READ IN CONJUNCTION WITH DRAWINGS. ALL LIGHTING SPECIFICATIONS, DETAILS AND FIXTURES TO BE FULLY COORDINATED WITH DRAWINGS. ALL CEILING HEIGHTS SHOWN HEREIN ARE REFERENCED FROM TOP OF LEVELED CONCRETE SLAB. ALL MILLWORK AND PLUMBING FIXTURE DIMENSIONS SHOWN HEREIN ARE REFRENCED FROM TOP OF FINISHED FLOOR. THE CONTRACTOR SHALL VERIFY ALL CONDITIONS AND DIMENSIONS AT THE JOB SITE PRIOR TO COMMENCING WORK, THE CONTRACTOR SHALL REPORT ALL DISCREPANCIES BETWEEN THE DRAWINGS AND EXISTING CONDITIONS TO THE DESIGNER PRIOR TO COMMENCING WORK. STONE VENEER DRY STACK
W/ TIES TO CMU ALL DETAILS AND SECTIONS SHOWN ON THE DRAWINGS ARE INTENDED TO BE TYPICAL AND SHALL BE CONSTRUED TO APPLY TO ANY SIMILAR SITUATION ELSEWHERE IN THE WORK EXCEPT WHERE 8"CMU W/GROUTED CELLS A DIFFERENT DETAIL IS SHOWN. @2'-0" O.C. NOTE: All Federal, State, and Local codes, ordinances, and restrictions take precedence over any part of these plans which may conflict with same, and must be strictly obeyed and followed before and during construction. #5 CONT. HOOK FROM -FOOTING @2'-0" O.C. IN FULLY GROUTED CELL PROJECT/CLIENT: MARRIOTT: FAIRFIELD INN 3301 S. RANGELINE RD JOPLIN, MISSOURI WOOD CAP 64804 FILL FROM FOOTING WORK JLNFI EXISTING GRADE STAMPED CONCRETE 'WOOD PLANK' #4 @24"OC — 07/15/2016 DRILLED AND REFER FINISH SPEC EPOXIED INTO DATE REVISIONS WIRE MESH EXISTING STRUCTURE REBAR @24"OC 12"CMU -— 4x4 SECURED FULLY GROUTED 1/48 SLOPE 2 #5 AT TOP WITH EXPANSION BOLTS AND BOTTOM CONCRETE FTG. -W/#5 BARS ---- SLATS INFILL FROM EA .WAY @ 16"OC WALL CONSTRUCTION EXISTING -1606 MG PROJECT NO. STRUCTURE DRAWN BY: CHECKED BY: PATIO: SECTIONS SECURED WITH EXPANSION BOLTS B PATIO SLAB SCALE: 1 1/2" = 1'-0"