PANEL	BOARD SCHED	ULE													P4
VOLTAGE: PHASE / WIRE: AMPS:	120/208 3 / 4 225	POLES: KAIC AMPS (R MAIN BREAKE		O:		42 22 MLO			MOUNTI LOCATION	DN:			RFACE H G100 MDP	ENCLOSURE: MANUFACTURER: MODEL:	NEMA : SQUARE D NG
CIRC. NO.	EQUIPMENT SERVE		C/B	C/B POLES	C/B ACC.	LOAD (VA)	PHA A	SE LOADS B	S (VA)	LOAD (VA)	C/B ACC.	C/B POLES	C/B AMPS	EQUIPMENT SERVED	CIRC, NO.
1	MECHANICAL G100/ OUTSIDE REC	CEPTACLES	20	1	-	540	1716			1176	HACR	1	20	SUMP PUMP SP1	2
3	HEAT PUMP HP1		50	3	HACR	4500		5300		800	-	1	20	MECH LIGHTS	4
5	· ·					4500			5900	1400	HACR	1	20	ENERGY RECOVERY UNIT ERU1	6
7	и					4500	5900			1400	HACR	1	20	ENERGY RECOVERY UNIT ERU2	8
9	HEAT PUMP HP2A		30	2	HACR	1770		2270		500	-	1	20	TELECOMM EQUIPMENT RECEPTACLE	10
11	и					1770			5635	3865	HACR	3	60	CONDENSER WATER PUMP CP1	12
13	HEAT PUMP HP2B		20	2	HACR	1300	5165			3865				u .	14
15	"					1300		5165	٠.	3865	-			н	16
17	HEAT PUMP HP3		20	2	HACR	1300			5165	3865	HACR	3	60	CONDENSER WATER PUMP CP2	18
19	"			.		1300	5165			3865				н	20
21	SPARE		20	1	_			3865		3865				" ,	22
23	SPARE		20	1							_	1	20	SPARE	24
25	SPARE		20	1	_							1	_	SPACE	26
27	SPARE		20	1	_			·	1 4			1	_	SPACE	28
29	SPARE		20	1	_						_	1		SPACE	30
31	SPARE	-	20	1	_							1	_	SPACE	32
33	SPARE		20	1	_						_	1	_	SPACE	34
35	SPARE		20	1	-							1		SPACE	36
	SPARE		20	1								1	_	SPACE	38
37	SPARE		20	1								1	_	SPACE	40
39				1	-			<u>. </u>				1		SPACE	42
41 ENGLOSUES A	SPARE CCESSORIES: CH.FL		20	,	-					DANEI	ROARD	ACCES	SSORIES:	GB,CBB	12
ENCLOSURE A CIRCUIT BR AC EO GFCI HACR HLF HLN SR ST NOTES:	EAKER ACCESSORIES: - AUXILLIARY CONTACTS - ELECTRICAL OPERATOR - GROUND-FAULT INTERRUPTING - HACR RATING - HANDLE LOCK-OFF - HANDLE LOCK-ON - SWITCH RATING - SHUNT TRIP	CW DWD EGT EGB EGSL EGSR	- CONCE - COLUM - HINDGE - EXTENI - EXTENI - EXTENI - EXTENI	EALED HI IN WIDTH ED DOOF DED GUT DED GUT DED GUT	I PANEL R WITHIN HI TER TOP TER BOTTO TER LEFT I	NGED DOO! OM HAND SIDE F HAND SIDE			PANELBOA CL FTL GB GBI NBK PS SB SER	RD ACCESS - COMPRE - FEED-TH - EQUIPM - GROUNI - NEUTRA - PREPAR - SPLIT BU	SORIES ESSION LUG HRU LUGS ENT GROUI D BAR INSU L BONDING RED CIRCUIT	GS ND BAR K LATOR KI G KIT T BREAKE	IT T ER SPACE	SFB - SUB-FEED CIRCUIT BREAKER SFL - SUB-FEED LUGS CBB - SILVER PLATED COPPER BUS BARS ABB - TIN PLATED ALUMINUM BUS BARS TRN - 200% RATED NEUTRAL BUS BAR TVSS - TRANSIENT VOLTAGE SURGE SUPPRESSION	

PANEL	_BOARD SCHEI	DULE														P5
OLTAGE: PHASE / WIRL AMPS:	120/208 E: 3 / 4 225	POLES: KAIC AMPS (F MAIN BREAKE		-O:		42 22 MLO			MOUNTI LOCATIO FED FRO	ON:	LIFE	SUR SUPPF	RFACE RT 110 MDP		ENCLOSURE: MANUFACTURER: MODEL:	NEMA SQUARE L NO
CIRC. NO.	EQUIPMENT SERV	ED	C/B AMPS	C/B POLES	C/B ACC.	LOAD (VA)	PHA A	SE LOADS	S (VA)	LOAD (VA)	C/B ACC.	C/B POLES	C/B AMPS		EQUIPMENT SERVED	CIRC. NO.
1	SPARE		20	1	•		1725			1725	HACR	2	30	HP7		2
3	SPARE		20	1				1725		1725				II		4
5	SPARE		20	1							-	1	20	SPARE		6
7	SPARE		20	1	_				1		_	1	20	SPARE		8
9	SPARE		20	1								<u>·</u> 1	20	SPARE		10
	SPARE		20	1	-						_	1	20	SPARE		12
11	SPARE		20	1						-14	-	1	20	SPARE		14
13				1	-						_	1	20	SPARE		16
15	SPARE		20	1	_							1	i	SPARE		18
17	SPARE		20	7	-						-		20			
19	SPACE		-	1	-		.=				-	1	-	SPACE		20
21	SPACE		-	1	-						-	1	-	SPACE		22
23	SPACE		-	1	-						-	1	-	SPACE		24
25	SPACE		-	1	-						-	1	-	SPACE		26
27	SPACE		-	1	#						-	1	-	SPACE		28
29	SPACE			1	-			_			-	1	_	SPACE		30
31	SPACE		~	1	-						-	1	-	SPACE		32
33	SPACE		-	1	-						-	1	-	SPACE		34
35	SPACE		-	1	-						_	1	4	SPACE		36
37	SPACE		-	1	-							1	-	SPACE		38
39	SPACE			1	_						_	1	_	SPACE		40
41	SPACE			1	_						_	1	_	SPACE		42
	ACCESSORIES: CH,FL			1	L					PANFI	BOARD	ACCES	SORIES:	GB,CBE		
	BREAKER ACCESSORIES: - AUXILLIARY CONTACTS - ELECTRICAL OPERATOR - GROUND-FAULT INTERRUPTING - HACR RATING - HANDLE LOCK-OFF - HANDLE LOCK-ON - SWITCH RATING - SHUNT TRIP	CW DWD EGT EGB EGSL EGSR	- CONCE - COLUM - HINDGE - EXTENI - EXTENI - EXTENI - EXTENI	EALED HIN MN WIDTH ED DOOR DED GUT DED GUT DED GUT	PANEL WITHIN HI TER TOP TER BOTT TER LEFT I	INGED DOOI OM HAND SIDE I' HAND SIDE			PANELBOA CL FTL GB GBI NBK PS SB SER	RD ACCESS - COMPRI - FEED-TH - EQUIPM - GROUNI - NEUTRA - PREPAR - SPLIT BU	SORIES ESSION LUG IRU LUGS ENT GROUN D BAR INSUL L BONDING ED CIRCUIT	S ID BAR KI ATOR KI KIT BREAKE	IT T ER SPACE	SFB SFL CBB ABB TRN TVSS	- SUB-FEED CIRCUIT BREAKER - SUB-FEED LUGS - SILVER PLATED COPPER BUS BARS - TIN PLATED ALUMINUM BUS BARS - 200% RATED NEUTRAL BUS BAR - TRANSIENT VOLTAGE SURGE SUPPRESSION	

4. PROVIDE CONTROL COIL POWERED BY ASSOCIATED LIGHTING CIRCUIT.

	SU	RGE P	ROTECTION	ON DEVIC	E SCHE	DULE		
MARK	MANUFACTURER	MODEL	SURGE RATING	VOLTAGE	MODES OF PROTECTION	MCOV	NEMA ENCLOSURE	NOTES AND OPTIONS
SPD1	CURRENT TECHNOLOGY	#CGP150	150kA PER MODE	120/208V 3PH, 4W	L-N,L-G,N-G,L-L	300V	NEMA 4	2,5
1. INTEGR. 2. STATUS 3. STANDA	DRIES/NOTES: AL DISCONNECT S L.E.D.s ARD MONITORING CED MONITORING: PRIMARY MONITORI	NG PLUS EVENT CO	DUNTER DISPLAY, AUDIBLE A	LARM W/LED		ABBREVIATI L-N - LINE TO L-G LINE TO G N-G - NEUTRA L-L - LINE TO I	NEUTRAL BROUND LL TO GROUND	


444514	LOAD					C	ONTACTOR		INTERLOCA	(
MARK	EQUIPMENT SERVED	WATTS	VOLTAGE	TYPE	AMP	POLE	ENCLOSURE	ACCESSORIES	CONTROLLED BY	CONTROLS
LC1	EXTERIOR LIGHTING	-	120	NOEH	30	8	NEMA 1	1,2,3,4	BUILDING MANAGEMENT SYSTEM	_
LC2	SITE LIGHTING	-	208	NOEH	30	8	NEMA 1	1,2,3,4	BUILDING MANAGEMENT SYSTEM	•

/OLTAGE:	120/208	POLES:	-			30			MOUNTI	NG:		SUR	FACE		ENCLOSURE:	NEM
PHASE / WIRE	3/4	KAIC AMPS	(RMS):			22			LOCATIO	DN:	DO	CK/STC	R 109		MANUFACTURER:	SQUARE
AMPS:	100	MAIN BREAK	KER / M.	LO:		MLO			FED FRO	DM:			MDP		MODEL:	1
CIRC.	FOURNIENT OFFICE		C/B	C/B	0/0.400		PHA	SE LOADS	(VA)		0/2 400	C/B	C/B		EQUIPMENT SERVED	CI
NO.	EQUIPMENT SERVED		AMPS	POLES	C/B ACC.	LOAD (VA)	Α	В	С	LOAD (VA)	C/B ACC.	POLES	AMPS		EQUIPMENT SERVED	N
1	DOCK/STORAGE 109	- 121-25-05-24-05-24-05-24-05-24-05-24-05-24-05-24-05-24-05-24-05-24-05-24-05-24-05-24-05-24-05-24-05-24-05-24	20	1	-	360	900			540	-	1	20	DOCK/S	ORAGE 109	
3	DOCK/STORAGE 109		20	1		180		360		180	-	1	20	DOCK/ST	FORAGE 109	
5	GIFT 103		20	1	-	180			360	180	~	1	20	VESTIBU	LE 100	
7	PAVILLION		20	1	-	540	1080			540	-	1	20	RECEPT	ION 102	
9	JANITOR 106/HWP1		20	1	_	220		920		700	GFCI	1	20	DRINKIN	G FOUNTAIN	1
11	BATHROOM 107/108	· · · · · · · · · · · · · · · · · · ·	20	1	_	1080			1780	700	GFCI	1	20	DRINKIN	G FOUNTAIN	1
13	DOCK/STORAGE 109 LIGHTING		20	1	-						-	1	20	SPARE		1
15	EXHIBIT SCREENS		20	1	_	540		540			-	1	20	SPARE		1
17	SPARE		20	1	-		1				_	1		SPACE		1
19	SPARE		20	1	-						-	1	-	SPACE		2
21	SPARE	i	20	1	_						-	1		SPACE		2
23	SPARE	•	20	1	-						-	1	-	SPACE		2
25	SPACE		-	1	-			1,000			_	1	-	SPACE		2
27	SPACE		-	1	-						_	1	_	SPACE		2
29	SPACE		-	1	-							1	-	SPACE		3
ENCLOSURE				-l		<u> </u>				PANEL	BOARD	ACCES	SORIES:	GB,CBE		
	ACCESSORIES: CH,FL BREAKER ACCESSORIES: - AUXILLIARY CONTACTS - ELECTRICAL OPERATOR - GROUND-FAULT INTERRUPTING - HACR RATING - HANDLE LOCK-OFF - HANDLE LOCK-ON - SWITCH RATING - SHUNT TRIP	ENCLOSURE AC CH CW DWD EGT EGB EGSL EGSR FL	- CONC - COLUI - HINDO - EXTEI - EXTEI - EXTEI	EALED HI MN WIDTH SED DOOF NDED GUT NDED GUT NDED GUT	H PANEL R WITHIN HI ITER TOP ITER BOTTO ITER LEFT I	INGED DOO OM HAND SIDE T HAND SIDI			PANELBOA CL FTL GB GBI NBK PS SB SER	RD ACCESS - COMPRE - FEED-TH - EQUIPME - GROUND - NEUTRAL - PREPARL - SPLIT BU	ORIES ISSION LUG IRU LUGS ENT GROUI D BAR INSU L BONDING ED CIRCUIT	GS ND BAR KI LATOR KI I KIT I BREAKE	r R SPACE	SFB SFL CBB ABB TRN TVSS	- SUB-FEED CIRCUIT BREAKER - SUB-FEED LUGS - SILVER PLATED COPPER BUS BARS - TIN PLATED ALUMINUM BUS BARS - 200% RATED NEUTRAL BUS BAR - TRANSIENT VOLTAGE SURGE SUPPRESSION	

ひょぐに ハルハロビ・		POLES:				84			MOUNTI				RFACE	ENCLOSURE:	NEMA
HASE / WIRE:	3/4	KAIC AMPS (RI	•	0.		22			LOCATIO			MEC	CH 113	MANUFACTURER:	SQUARE N
MPS:	400	MAIN BREAKE				MLO	PHA	SE LOADS	FED FRO)M:		0/0	MDP	MODEL:	ÇIRO
RC. IO.	EQUIPMENT SERVED	1.	C/B AMPS	C/B POLES	C/B ACC.	LOAD (VA)	A	B	C	LOAD (VA)	C/B ACC.	C/B POLES	C/B AMPS	EQUIPMENT SERVED	NO
1	CONFERENCE 120		20	1	-	1620	1800			180	-	1	20	PORCH	2
3	STORAGE RECEPTACLES		20	1	-	540		1080		540	-	1	20	BREAK 130	4
5	REFRIGERATOR		20	1	-	1000			1500	500		1	20	GARBAGE DISPOSAL	6
7	SPARE		20	1	-		1080			1080	D	1	20	OFFICE 127/128	8
9	OFFICE 126		20	1	_	540		1800		1260		1	20	OPEN OFFICE 121	10
11	OPEN OFFICE 121		20	1	-	540			720	180	-	1	20	STORAGE 125	12
	COPY 124		20	1	-	540	540				-	1	20	SPARE	14
15	DOCK/STORAGE 109 LIGHTING		20	1	_	480		480			-	1	20	SPARE	16
7	PAVILION LIGHTING	····	20	1	-	198			598	400	-	1	20	PAVILION LIGHTING	18
19	PAVIION/PORCH LIGHTING		20	1	-	120	390			270		1	20	RECEPTION LIGHTING	20
·	LOBBY TRACK LIGHTING		20	1	_	1200		2000		800		1	20	LOBBY TRACK LIGHTING	22
	EXHIBIT TRACK LIGHTING		20	1		800			2080	1280	-	1	20	LIFE SUPPORT LIGHTING	24
	EXHIBIT 104 LIGHTING		20	1	-	550	1350			800	-	1	20	EXHIBIT TRACK LIGHTING	26
	EXHIBIT OUTDOOR LIGHTING		20	1	_	50		1262	* .	1212		1	20	EXHIBIT/CLASS/LIVE ANIMAL LIGHTING	28
	LIVE ANIMAL 115 LIGHTING		20	1	-	480			1680	1200	-	1	20	GATHERING TRACK LIGHTING	30
	GATHERING 112 LIGHTING		20	1	-	1200	1280		-;	80	-	1	20	GATHERING 112 LIGHTING	32
-	BATHROOM 107/108 LIGHTING		20	1	-	640		1440		800	-	1	20	MECHANICAL/LIFE/RESTROOM LIGHTING	34
	CONFERENCE/STORAGE/OFFICE LIGHT	ING	20	1	-	1500			1770	270	-	1	20	GATHERING 112 LIGHTING	36
	OPEN OFFICE LIGHTING		20_	1	-	1403	2503			1100	-	1	20	PORCH LIGHTING	38
	SPARE		20	1	-			3460		3460	HACR	3	45	HEAT PUMP HP5	40
 	WATER HEATER WH1		30	2	HLF	2250	5740		5710	3460				n .	42
						2250	5710	0.000		3460			4-	The second secon	44
	FACP		20	1	HLN	200		3660	00.40	3460	HACR	3	45	HEAT PUMP HP6	46
	HEAT PUMP HP8		45	2	HACR	2750	0040		6210	3460				,	48
19		-			11400	2750	6210	40.45		3460				,	50
	HEAT PUMP HP9		30	2	HACR	1965		4315	0005	2350	HACR	1	30	ENERGY RECOVERY UNIT ERUS	52
53	LICAT DUNID LIDAO		45			1965	4-2-70		3365	1400	HACR	1	20	ENERGY RECOVERY UNIT ERU4	54
	HEAT PUMP HP10		15	2	HACR	500	1775	4775		1275 1275	HACR	2	20	HEAT PUMP HP11	56 58
)/	SPARE		20	4		500		1775	500		11400	0	45		60
	SPARE		20	1	-		500		500	500 500	HACR	2	15	HEAT PUMP HP12	62
	SPARE		20	1			500	1275		1275	HACR	2	20	HEAT PUMP HP13	64
	SPARE		20	1	-			1270	1275	1275	HACK		20	"	66
	SPACE			1	-		1000	1 1 1 1 1 1 1 1 1 1 1 1 1 1 1 1 1 1 1 1	1270	1000		2	20	PARKING LOT LIGHTING(EAST)	68
	SPACE			1			7000	1000		1000	-		20	"	70
	SPACE			1				1000	365	365		2	20	BOLLARD LIGHTING	72
	SPACE			1			365		300	365			20	"	74
	SPACE	,		1			300	600		600	_	2	20	PARKING LOT LIGHTING(SOUTH)	76
	SPACE			1	_				600	600			20	"	78
	SPACE			1	-				000	- 000		1	20	SPARE	80
	SPACE		-	1	=	ļ						1	20	SPARE	82
	SPACE			1	_						_	1	20	SPARE	84
	ACCESSORIES: CH,FL	 		-	I					PANEL	.BOARD	ACCES	SSORIES:	GB,CBB	
	REAKER ACCESSORIES:	ENCLOSURE ACCES			NGE					RD ACCESS		30		DED OUR FEED OIDQUIT SDEAVED	
	- AUXILLIARY CONTACTS - ELECTRICAL OPERATOR	CW -	COLUN	EALED HI IN WIDTH	I PANEL				CL FTL	- COMPRE - FEED-TH	ESSION LUC IRU LUGS	38		SFB - SUB-FEED CIRCUIT BREAKER SFL - SUB-FEED LUGS	
<i>GFCI</i>	- GROUND-FAULT INTERRUPTING - HACR RATING				R WITHIN HI	INGED DOO	R		GB GBI	- EQUIPM	ENT GROUI			CBB - SILVER PLATED COPPER BUS BARS	
HLF	- HANDLE LOCK-OFF	EGB -	EXTEN	DED GUT	TER BOTT				GBI NBK		D BAR INSU L BONDING		1	ABB - TIN PLATED ALUMINUM BUS BARS TRN - 200% RATED NEUTRAL BUS BAR	
HLN SR	- HANDLE LOCK-ON - SWITCH RATING					HAND SIDE T HAND SIDE			PS SB	- PREPAR - SPLIT BU	ED CIRCUI	T BREAKE	R SPACE	TVSS - TRANSIENT VOLTAGE SURGE SUPPRESSIO	N

- CONFIRM REQUIREMENTS FOR EQUIPMENT FURNISHED BY OTHERS

DAKE | WELLS architecture

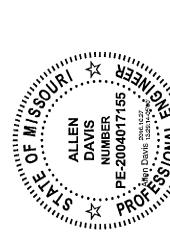

Date: Revised: 10-27-16 Scale: Drawn: AS NOTED AKD Checked: ---Job: 14023

VOLTAGE.	120/208	MOUNTING	SPACE	<u>:</u>	'		AS REQ'D			MOUNTI	NG:	F	XTERIC	R/SUR	REACE		ENCLOSURE:	NEM	<u> </u>
PHASE / V		KAIC AMPS					42			LOCATIO		_	D() D ()		ERIOR		MANUFACTURER:	SQUA	
AMPS:	600	MAIN BREA	AKER/N	1LO:		(600A MCB			FED FRO	DM:		SE	RVICE			MODEL:	1-	-LI
CIRC. NO.	LOAD		C/B TYPE	C/B AMPS	C/B POLES	C/B ACC	LOAD (VA)	PHA	SE LOADS	· ,	LOAD (VA)	C/B ACC.	C/B POLES	C/B AMPS	C/B TYPE		LOAD		CII
				73811 0	/ OLLO			Α	В	С			FULES	AMPS	ITE				
1	PANEL P1			100	2		1980	26483		1	24503					5445	50		
'	PAINEL PI		_	100	3		1820	1 4	25967		24147		3	300	-	PANEL	P2		ž
				-	-		2140	00004		28513	26373								
3	PANEL P3		<u>-</u>	100	3		5145 3980	23091	20580		17946 16600		3	225	_	PANEL	DA		
	77			""			3945		20500	20645	16700		3	220	-	FAIVLL	- 1		7
			-				1725	1730		20043	5				<u> </u>	******			
5	PANEL P5		_	225	3		1725	1700	1730		5		3	100	_	SURGE	PROTECTION DEVICE SPD1		f
							0		7700	5	5		1						
		,						0									·		
7	SPARE		-	200	3				0		-		3		_	SPACE	ONLY		8
										0									
ENCLOS	URE ACCESSORIES: CH,FL	.,									PANEL	BOARD .	ACCESS	ORIES	S:	CBB, G	iB	l.	
CIRC 100% AC EO GFC GFP HAC HLN PFR ST	- AUXILLIARY CONTACTS - ELECTRICAL OPERATOR - GROUND-FAULT INTERRUPTING - MAIN BKR GROUND FAULT PROT - HACR RATING - HANDLE LOCK-OFF - HANDLE LOCK-ON	ENCLOSURE A CH CW DWD EGT EGB EGSL EGSR FL	- CONC - COLU - HINDO - EXTE - EXTE - EXTE	EALED H MN WIDT. GED DOO NDED GU NDED GU NDED GU	H PANEL R WITHIN TTER TO TTER BO TTER LE TTER RIG	N HINGED P	SIDE			PANELBOA CL FTL GB GBI NBK PS SB SER	RD ACCESS - COMPRE - FEED-TH EQUIPME - GROUND - NEUTRAL - PREPARE - SPLIT BU - SERVICE	SSION LUG RU LUGS ENT GROUN BAR INSUL BONDING ED CIRCUIT	ND BAR KIT LATOR KIT KIT F BREAKER			SFB SFL CBB ABB TRN TVSS	- SUB-FEED CIRCUIT BREAKER - SUB-FEED LUGS - SILVER PLATED COPPER BUS BA - TIN PLATED ALUMINUM BUS BAR - 200% RATED NEUTRAL BUS BAR - TRANSIENT VOLTAGE SURGE SU	S	

MARK	MANUFACTURER	MODEL#	FINISH	MOUNTING		LAMPS		FIXTURE	VOLTAGE	APPROVED	NOTES
7777711	WANTOTACTOTER	WIODELT	FIIVISH	WOONTING	TYPE	CODE	QTY.	WATTS	VOLTAGE	MANUFACTURERS	NOTE
B1	HESS	LN950-HP/LED-NW-UNV-D-03SRA-SG-N	DARK GREY	BOLLARD	LED	WITH FIXTURE	-	33	208	SUBMIT	3,11
DP1	DELRAY	6725-S-W30-BDIM-W2-C-XP	SILVER/WHITE	PENDANT	LED	WITH FIXTURE	_	87	120	SUBMIT	2,4
EW1	TERON	TRITON-LED-L32.0-120-CGL-BZ-PCL120-EBW	BRONZE	SURF/WALL	LED	WITH FIXTURE	-	35	120	SUBMIT	3,9,1
EW2	TERON	TRITON-LED-L32.0-120-CGL-BZ-PCL120-EBW	BRONZE	SURF/WALL	LED	WITH FIXTURE		35	120	SUBMIT	3,9
FL1	REMCRAFT	2074 DOUBLE BULLET	SILVER	SURFACE	LED	LED REPLACEMENT	-	35	120	SUBMIT	3
FL2	ACCLAIM	ALB.231.BPHU-ALQB1000LV	SILVER	GRADE	LED	WITH FIXTURE	-	75	120	SUBMIT	3
IG1	LUMIERE	3002A-RD-18LED3000-MFL-CLR-UNV-CS	SILVER	IN-GRADE	LED	WITH FIXTURE	-	18	120	SUBMIT	3
LC1	ACCLAIM	FLEXPI35/FLX444/DPW-311-JBAT	STD	RECESSED	LED	WITH FIXTURE	-	5.5/FT	120	SUBMIT	2
LC2	ACCLAIM	(1) DCA-142-D-A-D-U	STD	COVE	LED	WITH FIXTURE	-	80	120	SUBMIT	2
LC3	ACCLAIM	(2) DCA-142-D-A-D-U	STD	COVE	LED	WITH FIXTURE	-	160	120	SUBMIT	2
LP1	FOCAL POINT	FSM4BS-875LF-35K-1C-120-LD1-C96*-TS-40'	SILVER	SUSPENDED	LED	WITH FIXTURE	_	480	120	SUBMIT	2,4
LP2	FOCAL POINT	FSM4BS-875LF-35K-1C-120-LD1-C96*-TS-32'	SILVER	SUSPENDED	LED	WITH FIXTURE	-	384	120	SUBMIT	2,4
LP3	FOCAL POINT	FSM4BS-875LF-35K-1C-120-LD1-C96*-TS-76'	WHITE	SUSPENDED	LED	WITH FIXTURE	-	912	120	SUBMIT	2,4,1
LR1	ACCLAIM	FLEXPE35/FLX444/APS-240-24	STD	RECESSED	LED	WITH FIXTURE	-	5.5/FT	120	SUBMIT	7
LS1	HE WILLIAMS	75-4-LED*PH65-A12125-120	WHITE	SURF/CLG	LED	WITH FIXTURE	-	49	120	METALUX	_
LS2	HE WILLIAMS	75-8-LED*PH130-A12125-120	WHITE	SURF/CLG	LED	WITH FIXTURE		97	120	METALUX	
LW1	FOCAL POINT	FSM4BW-875LF-35K-1C-120-LD1-C96*-TS-22'	SILVER	SURF/WALL	LED	WITH FIXTURE	-	264	120	SUBMIT	2
PL1	MCGRAW EDISON	VTS-E06-LED-E1-T3-7030	GRAY	POLE	LED	WITH FIXTURE	-	150	208	SUBMIT	3,10
PL2	MCGRAW EDISON	VTS-E06-LED-E1-T4-7030	GRAY	POLE	LED	WITH FIXTURE	-	150	208	SUBMIT	3,10
PL3	MCGRAW EDISON	VTS-E06-LED-E1-T4-7030-VA1034-XX	GRAY	POLE	LED	WITH FIXTURE	-	300	208	SUBMIT	3,10
SL1	INVUE	SQS-C-18-LEDWH-120-FR-BZ	SILVER	RECESSED	LED	WITH FIXTURE	-	18	120	SUBMIT	3,13
SL2	LUMIERE	1211-OA-CF9-120-CS	SILVER	RECESSED	LED	WITH FIXTURE	-	18	120	SUBMIT	3,13
TK1	LSI	LP2-20-30K HEADS WITH GEM TRACK (LENGTH AND HEADS PER PLANS)	SILVER	SUSPENDED	LED	WITH FIXTURE	-	27	120	SUBMIT	2,8
TK2	LSI	LP2-20-30K HEADS WITH GEM TRACK (LENGTH AND HEADS PER PLANS)	SILVER	SUSPENDED	LED	WITH FIXTURE	_	27	120	SUBMIT	2,8
TR1	HE WILLIAMS	50G-S24-LED*PH90/835-SA12125-120	WHITE	RECESSED	LED	WITH FIXTURE	-	94	120	METALUX	-
TR2	HE WILLIAMS	HETL-G-14-L52/835-F-CHA118-S-DIM-120	WHITE	RECESSED	LED	WITH FIXTURE	-	94	120	METALUX	-
TR3	FOCAL POINT	FSM4L-FL-875LF-35K-1C-120-LD1-C96*-TS-12'	SILVER	RECESSED	LED	WITH FIXTURE	_	129	120	SUBMIT	
TR4	FOCAL POINT	FSM4L-FL-875LF-35K-1C-120-LD1-C96*-TS-8'	SILVER	RECESSED	LED	WITH FIXTURE	-	86	120	SUBMIT	
TR5	ELP	AK-SP-3'-TLD-120	SILVER	RECESSED	LED	WITH FIXTURE		24	120	SUBMIT	2
TR6	ELP	AK-SP-6'-TLD-120	SILVER	RECESSED	LED	WITH FIXTURE		65	120	SUBMIT	2
UC1	HE WILLIAMS	1SF-4-L24/835-AF12125-DRV-UNV	WHITE	SURFACE	LED	WITH FIXTURE	_	29	120	METALUX	
WS1	FOCAL POINT	FTRL-AC-LL1-35K-1C-120-LD1-G-WH-XX'	WHITE	RECESSED	LED	WITH FIXTURE	-	6/FT	120	SUBMIT	
WS2	FOCAL POINT	FTRL-AC-LL1-35K-1C-120-LD1-G-WH-XX'	WHITE	RECESSED	LED	WITH FIXTURE	-	6/FT	120	SUBMIT	2,15
EMX1	HE WILLIAMS	EXIT/EM/LED-SF-G-WHT	WHITE/GRN	SURFACE	LED	WITH FIXTURE	-	5	120	SURELITES	9
X1	HE WILLIAMS		ANOD ALUM/GRN	SURFACE	LED	WITH FIXTURE	-	5	120	SURELITES	9

1. FIELD VERIFY EXACT LOCATION AND INSTALLATION HEIGHT WITH OWNER/ARCHITECT PRIOR TO ROUGH-IN. PROVIDE WITH 0-10-VOLT DC DIMMING DRIVER

OFCI - OWNER FURNISHED, CONTRACTOR INSTALLED

TBD - TO BE DETERMINED

3. PROVIDE WITH LOW-AMBIENT/COLD WEATHER DRIVER. 4. PROVIDE WITH CUSTOM SUSPENSION ACCESSORIES AS REQUIRED FOR INSTALLATION AT ELEVATION AS DIRECTION BY ARCHITECT. COORDINATE REQUIREMENTS FOR SUPPORT AND POWER THROUGH ROOFING PANELS. 5. INSTALL IN-GRADE FIXTURE PER MANUFACTURER'S RECOMMENDATIONS.

6. PROVIDE WITH 0-10-VOLT DC DIMMING DRIVER. FIELD COORDINATE FOR INSTALLATION AT ACCESSIBLE, BUT VISUALLY CONCEALED LOCATION. 7. PROVIDE WITH LOW-AMBIENT/COLD WEATHER DRIVER. FIELD COORDINATE FOR INSTALLATION AT ACCESSIBLE, BU VISUALLY CONCEALED LOCATION.

8. PROVIDE 8' TRACK SECTIONS IN TOTAL LENGTH PER PLANS. PROVIDE WITH ALL ACCESSORIES REQUIRED FOR COMPLETE PENDANT INSTALLATION.


9. PROVIDE WITH INTEGRAL BATTERY FOR MINIMUM 90-MINUTES OF EMERGENCY OPERATION. 10. PROVIDE WITH 4" SQUARE, 25' POLE, ANHOR BOLT COVER, AND ADDITIONAL ACCESSORIES AS REQUIRED FOR COMPLETE INSTALLATION.

11. INSTALL BOLLARD PER MANUFACTURER'S RECOMMENDATIONS.

12. PROVIDE WITH INSIDE HORIZONTAL CORNERS PER PLAN. 13. INSTALL CONTINUOUS CONCRETE PAD WITH SEPARATE CONDUIT FEED FOR EACH FIXTURE SECTION TO AVOID USE OF INTERCONNECTION CABLES.

14. PROVIDE WITH BODINE MODEL GTD GENERATOR TRANSFER DEVICE FOR NORMALLY OFF, EMERGENCY ONLY OPERATION. 15. PROVIDE WITH INSIDE CORNER ACCESSORY PER PLAN.

10-27-16 AS NOTED Scale: AKD Drawn: Checked: 14023

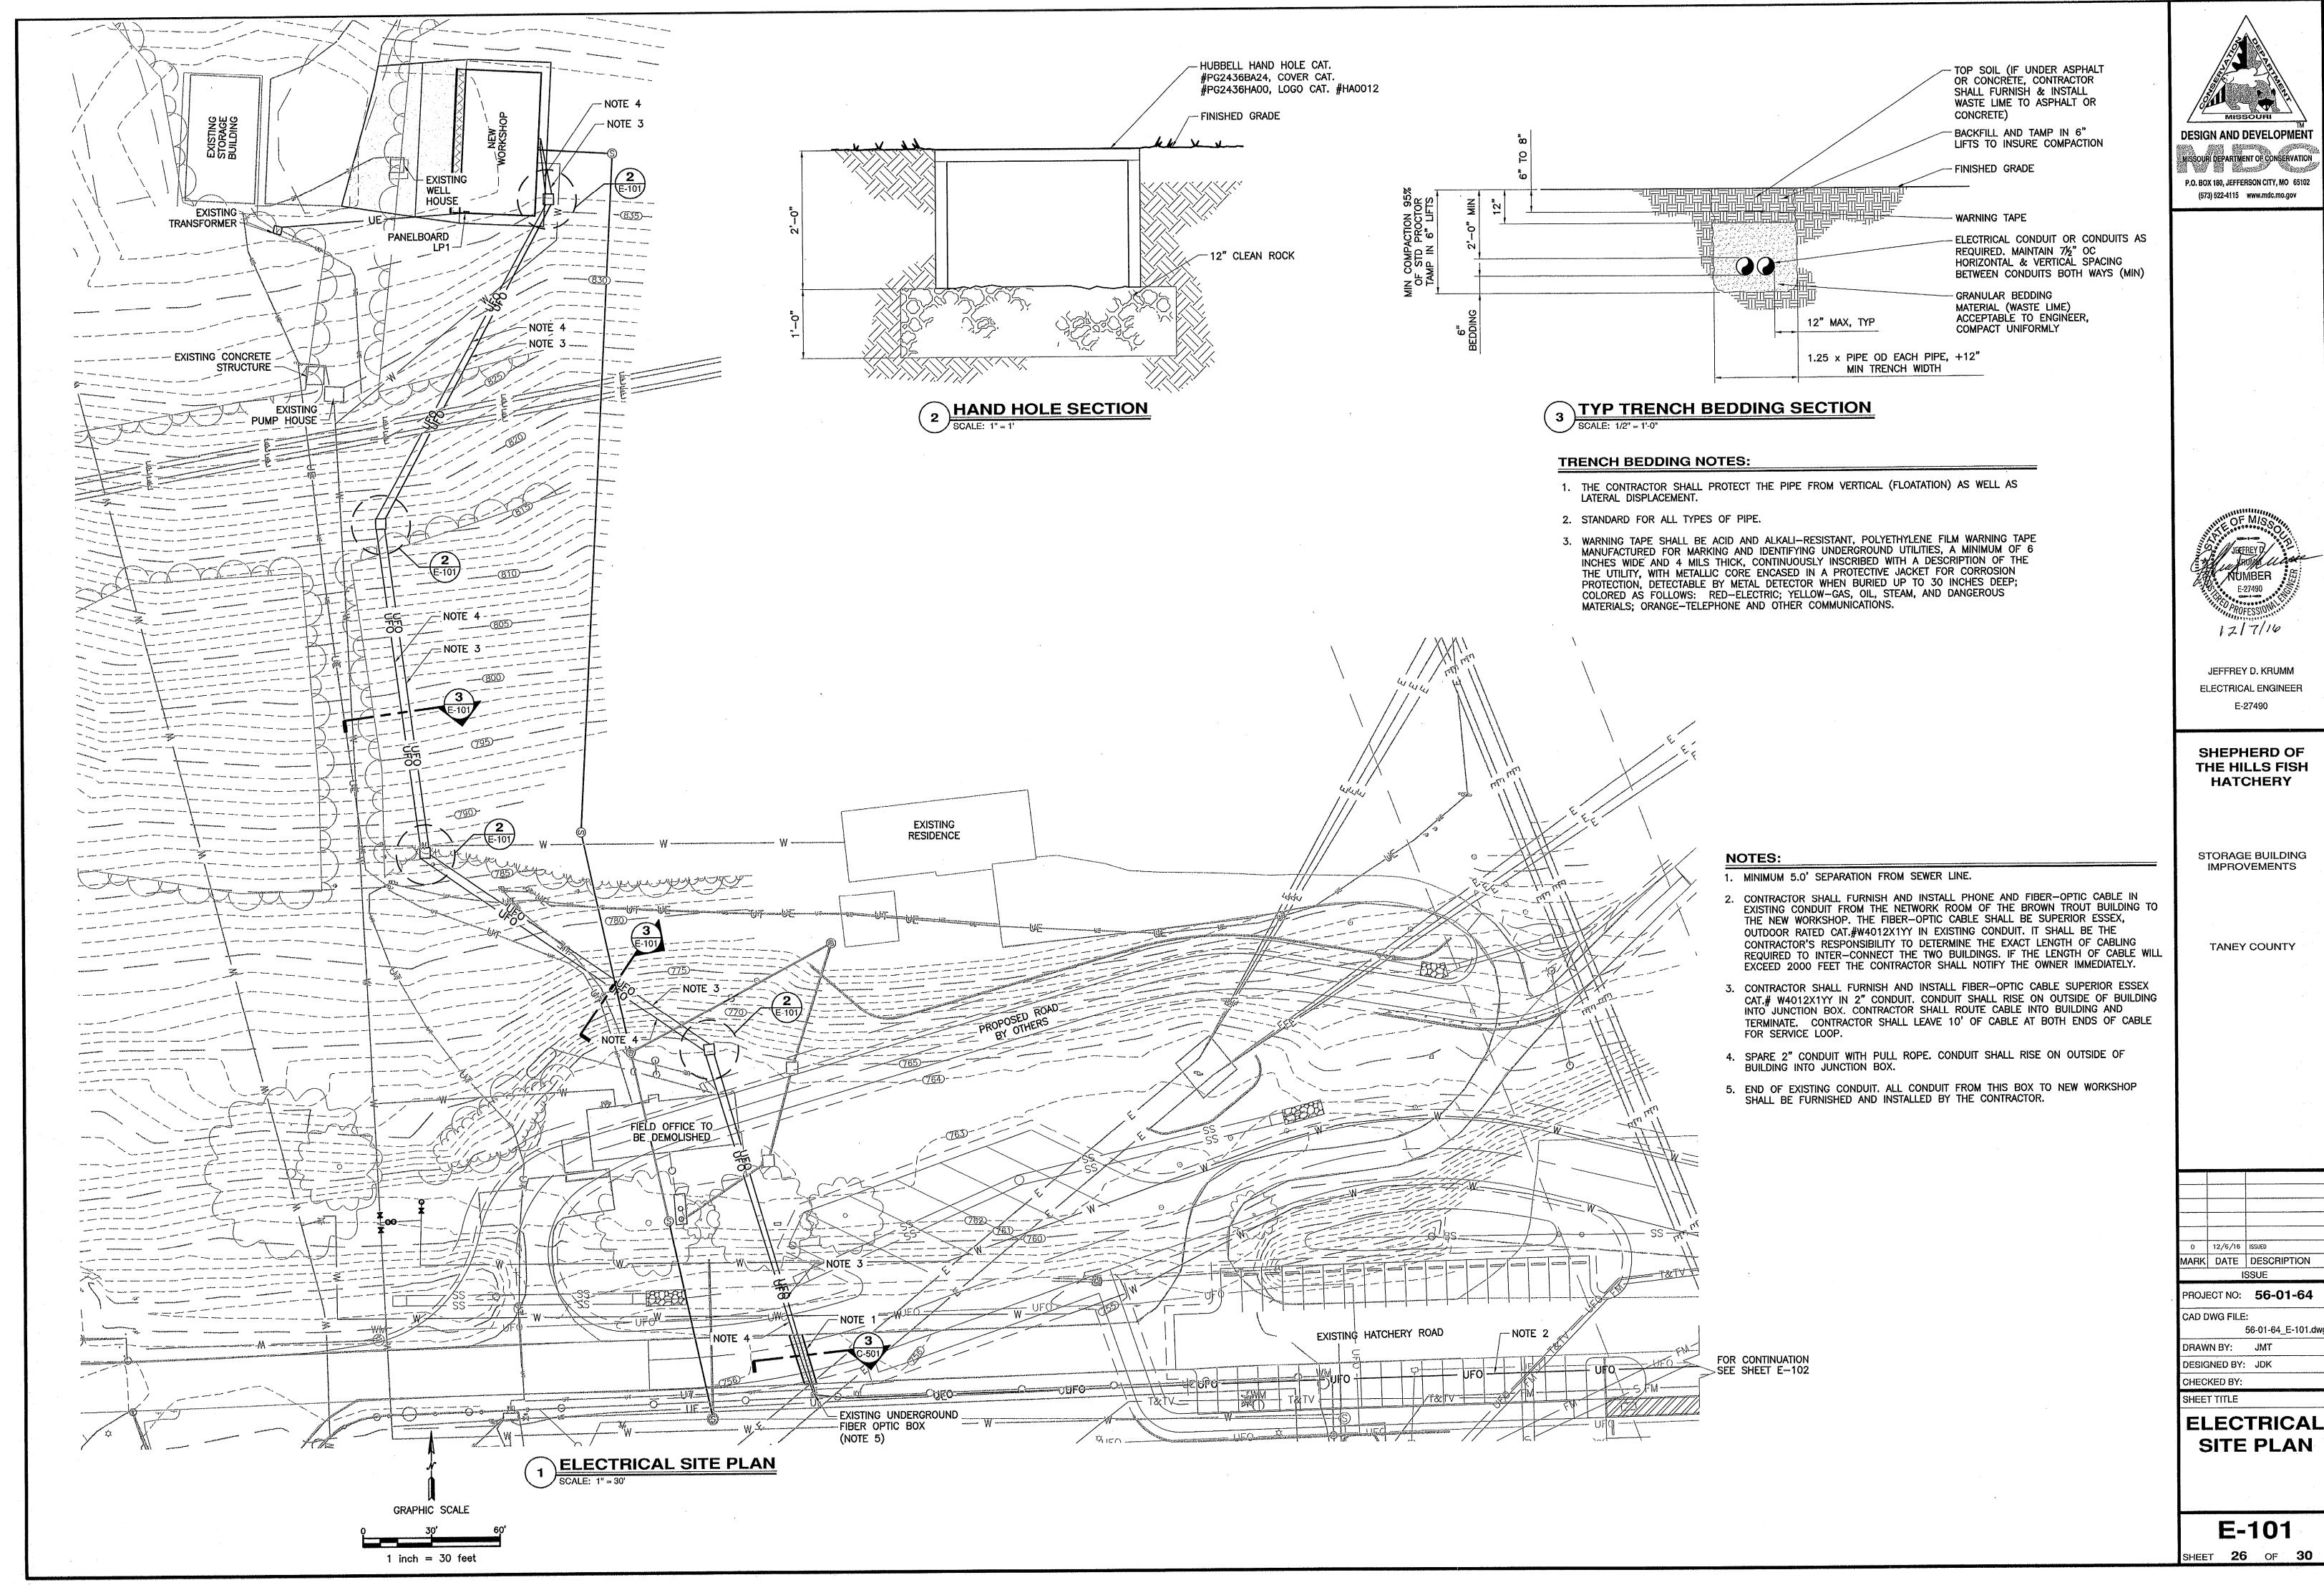

SHEET **27** OF **30**

GENERAL NOTES:

- 1. ALL CONDUIT IS 34" OR LARGER, UNLESS OTHERWISE NOTED.
- 2. ALL OUTLETS SHALL BE INSTALLED 48" ABOVE FINISHED FLOOR TO TOP OF RECEPTACLE UNLESS OTHERWISE NOTED.
- 3. ALL SWITCHES SHALL BE INSTALLED 48" ABOVE FINISHED FLOOR TO TOP OF SWITCH UNLESS OTHERWISE NOTED.
- 4. EACH CIRCUIT SHALL HAVE A DEDICATED NEUTRAL. SHARED NEUTRALS WILL NOT BE ALLOWED.
- 5. CONTRACTOR SHALL LABEL ALL CIRCUITS AT TERMINATION POINTS AND IN ALL JUNCTION BOXES AND LABEL ALL RECEPTACLE AND SWITCH COVERS WITH CIRCUIT DESIGNATION. CONTRACTOR SHALL ALSO LABEL ALL DISCONNECTS AS TO WHAT IT OPERATES. LABELS SHALL BE METAL OR PLASTIC ATTACHED BY STAINLESS STEEL SCREWS.
- 6. CONTRACTOR SHALL NOT INSTALL MORE THAN SIX (6) CURRENT CARRYING CONDUCTORS IN A RACEWAY. NEUTRALS SHALL BE COUNTED AS A CURRENT CARRYING CONDUCTOR.
- 7. THE AREA FROM THE FLOOR UP TO 18" AFF IS A CLASS I DIV II HAZARDOUS LOCATION, DO NOT INSTALL EQUIPMENT OR CONDUIT IN THIS AREA. CONTRACTOR SHALL COMPLY WITH THE LATEST EDITION OF THE NATIONAL ELECTRIC CODE FOR ALL CABLE CONDUIT AND ELECTRICAL EQUIPMENT INSTALLED IN WORKSHOP.
- 8. ALL PANELBOARDS, SWITCHBOARDS, LINE VOLTAGE CONTROL EQUIPMENT SHALL BE FIELD MARKED TO WARN QUALIFIED PERSONS OF POTENTIAL ELECTRIC ARC FLASH HAZARDS. MARKING SHALL BE LOCATED SO AS TO BE CLEARLY VISIBLE TO QUALIFIED PERSONS BEFORE EXAMINATION. ADJUSTING, SERVICING OR MAINTENANCE OF EQUIPMENT. MARKING SHALL BE SELF ADHESIVE COMMERCIAL LABEL CONFORMING TO N.E.C. 110.16.
- ALL CONDUITS SHALL BE RUN HORIZONTALLY ABOVE IN ATTIC. ALL CONDUIT RUNS IN WORK AREAS AND STORAGE AREAS SHALL BE VERTICAL.

9. ALL RECEPTACLES IN WORK BAYS SHALL BE SURFACE MOUNTED.

- 10. CONTRACTOR SHALL USE UNISTRUT P1000 SERIES OR EQUAL TO MOUNT ENCLOSURES AND PANELBOARDS TO WALLS.
- 11. CONTRACTOR SHALL LABEL DISCONNECT ON OUTSIDE OF BUILDING AS SERVICE DISCONNECT. LABEL SHALL BE UV RESISTANT AND SHALL BE PLACED ON THE INSIDE AND OUTSIDE OF DISCONNECT.

WORKSHOP POWERWIRING PLAN

NOTES:

- 1. EXOTHERMIC WELD #2/0 TINNED BARE COPPER GROUND CABLE TO REBAR IN FOOTING, FOUR PLACES.
- 2. BOND #2/0 GND CABLE TO WATER PIPE.
- 3. CONTRACTOR SHALL FURNISH AND INSTALL #6 GND CABLE IN ¾" PVC CONDUIT, ALL CONDUIT STRAPS SHALL BE NON-METALLIC. CONTRACTOR SHALL NOT INSTALL CONDUIT UNDER CONCRETE SLAB. CONTRACTOR SHALL BOND GND CABLE TO GND BUS IN PANEL AND TO TELECOM GND BUS.
- 4. CONTRACTOR SHALL FURNISH AND INSTALL A TELECOMMUNICATIONS GROUNDING BUS BAR COMPLYING WITH ANSI/TIA/EIA-607. CONNECT #6 AWG GROUNDING CONDUCTOR TO BOX USING 2-HOLE COMPRESSION LUG FURNISHED AND INSTALL ON END OF CABLE.
- 5. CONTRACTOR SHALL FURNISH AND INSTALL A SHEET OF 3/4" FIRE RATED PLYWOOD 4'x4' ANCHORED TO THE WALL WITH SCREWS. THE BOTTOM EDGE OF THE PLYWOOD SHALL BE 30" ABOVE FINISHED FLOOR, PAINT PLYWOOD TO MATCH COLOR OF WALLS.
- 5. CONTRACTOR SHALL FURNISH AND INSTALL A 24"x24"x36" WALL MOUNTED SWING CABINET CHATSWORTH CAT #11900-236 WITH PLEXIGLASS DOOR. MOUNT PATCH PANELS IN UPPER 1/3 OF RACK, CONTRACTOR SHALL FURNISH AND INSTALL LEVITON FIBER PATCH PANEL CAT.#5R1UM-F03 WITH LEVITON FIBER OPTIC LC CONNECTORS AND LC ADAPTOR PLATE LEVITON CAT.#5F100-2LL.
- 7. LOCATE RECEPTACLE BELOW RACK COORDINATE WITH OWNER FOR LOCATION.
- 8. CONTRACTOR SHALL FURNISH AND INSTALL TWO RJ-45 JACKS WITH 2-CAT6e CABLES. CONTRACTOR SHALL TERMINATE CABLES TO JACKS.
- 9. CONTRACTOR SHALL FURNISH AND INSTALL FIBER-OPTIC CABLE SUPERIOR ESSEX CAT. #W4012X1YY, OUTDOOR RATED IN 2" CONDUIT. CONDUIT SHALL RISE ON OUTSIDE OF BUILDING INTO PULL BOX. CONTRACTOR SHALL ROUTE CABLE INTO BUILDING AND TERMINATE. DO NOT INSTALL THROUGH FLOOR SLAB. CONTRACTOR SHALL LEAVE 10' OF CABLE AT BOTH ENDS OF CABLE FOR SERVICE LOOP.
- 10. SPARE 2" CONDUIT WITH PULL ROPE. CONDUIT SHALL RISE ON OUTSIDE OF BUILDING INTO JUNCTION BOX, CONTRACTOR SHALL SHALL FURNISH AND INSTALL TWO 2" CONDUITS FROM PULL BOX TO BUILDING ENTRANCE TERMINAL, DO NOT INSTALL THROUGH FLOOR SLAB.
- 11. MOUNT RECEPTACLE NEXT TO CABINET TO ALLOW EQUIPMENT IN CABINET EASY ACCESS TO POWER. COORDINATE WITH OWNER FOR EXACT LOCATION.
- 12. CONTRACTOR SHALL EXTEND 2-2" CONDUIT TO WALL MOUNTED CABINET AND TERMINATE.

 CONTRACTOR SHALL EXTEND FIBER THROUGH CONDUIT TO PATCH PANEL AND TERMINATE.

 INSTALLATION OF CONDUITS TO RACK SHALL BE COORDINATED WITH OWNER SO NOT TO BLOCK INSTALLATION OF EQUIPMENT BY OWNER.
- 13. NOT USED.
- 14. NOT USED.
- 15. ALL EXTERIOR CONDUITS SHALL RISE ON THE OUTSIDE OF THE BUILDING AND LB THROUGH WALL, 24" MINIMUM ABOVE FINISHED FLOOR.

16. CONTRACTOR SHALL TRENCH AND BACKFILL FOR SERVICE TO BUILDING. CONTRACTOR SHALL MEET WHITE RIVER VALLEY ELECTRIC COOPERATIVE TRENCHING & BACKFILL REQUIREMENTS FOR ELECTRICAL SERVICE. WHITE RIVER VALLEY ELECTRIC COOPERATIVE SHALL FURNISH & INSTALL CABLE FROM TRANSFORMER TO DISCONNECT. CONTRACTOR SHALL PROVIDE TRENCHING & BACKFILL. CONTRACTOR SHALL FURNISH AND INSTALL A 3" RIGID GALVANIZED STEEL SWEEPS AND RISERS AND CONNECT TO DISCONNECT WITH MEYER TYPE GROUNDING HUBS. HUBS SHALL INCLUDE GROUNDING LUG SIZED TO ACCEPT 2/0 AWG COPPER CABLE OR LARGER. CONTRACTOR SHALL COORDINATE W/WHITE RIVER VALLEY ELECTRIC COOPERATIVE FOR INSTALLATION OF SERVICE. CONTACT AT WHITE RIVER VALLEY ELECTRIC COOPERATIVE IS HARRY VANDERPLOEG PHONE #(417) 335-9335.

AMERICAN STATE OF THE PROPERTY OF THE PROPERTY

- 17. TRANSFORMER FURNISHED AND INSTALLED BY WHITE RIVER VALLEY ELECTRIC COOPERATIVE.
- 18. CONTRACTOR SHALL FURNISH AND INSTALL A 30A DISCONNECT FOR OWNER FURNISHED AIR COMPRESSOR. CONTRACTOR SHALL INSTALL AND WIRE OWNER FURNISHED COMPRESSOR.
- 19. GARAGE DOOR CONTROLLER USE DOOR MANUFACTURERS RECOMMENDED CONTROLLERS PROTECTION EQUIPMENT. PUSHBUTTON CONTROLS SHALL BE MOUNTED 4' AFF TO TOP OF CONTROLS. ALL ELECTRICAL AND ELECTRONIC EQUIPMENT SHALL NOT BE WITHIN 18" OF THE FLOOR. CONTRACTOR SHALL FURNISH AND INSTALL ALL WIRING NECESSARY FOR CONTROLLER.
- 20. SURFACE MOUNT RECEPTACLES 48" ABOVE FINISHED FLOOR. EACH QUADRAPLEX RECEPTACLE. SHALL HAVE AN INDIVIDUAL GFCI RECEPTACLE.
- 21. CONTRACTOR SHALL FURNISH AND INSTALL THERMOSTATS AND WIRING IN CONDUIT, SEE MECHANICAL DRAWINGS AND SPECIFICATIONS.
- 22. FURNISH AND INSTALL A HUBBEL PIN AND SLEEVE MECHANICAL INTERLOCK DISCONNECT SWITCH WITH ATTACHED 2 POLE, 3 WIRE RECEPTACLE, HUBBELL CAT. #HBL360MI6W & A HUBBEL PLUG CAT. #HBL360P6W. CONTRACTOR SHALL MOUNT PLUG ON WELDER FURNISHED BY OWNER. MOUNT UNIT 48" ABOVE FINISHED FLOOR TO TOP.


23. NOT USED.

- 24. CONTRACTOR SHALL FURNISH AND INSTALL A 400A METER BASE AND DISCONNECT, NEMA 3R, W/GROUND BUS AND NEUTRAL BUS AS REQUIRED TO ACCOMMODATE ALL CABLES.

 CONTRACTOR SHALL FURNISH AND INSTALL A SQUARE D CAT. #QUM400CL, RINGLESS METER BASE COMPLYING WITH WHITE RIVER VALLEY ELECTRIC COOPERATIVE REQUIREMENTS. LUGS SHALL BE FURNISHED AND INSTALLED TO ACCOMMODATE CABLE. TAMPER EVIDENT SEALING KIT CAT.#29375 SHALL BE FURNISHED AND INSTALLED. CONTACT AT WHITE RIVER VALLEY ELECTRIC COOPERATIVE IS HARRY VADERPLOEG (417) 335—9335. CONTRACTOR SHALL BOND THE NEUTRAL AND GROUND, ALL CONDUIT CONNECTIONS SHALL BE MADE WITH MEYER TYPE GROUNDING HUBS. HUBS SHALL INCLUDE GROUNDING LUGS SIZED TO ACCEPT 2/O AWG COPPER CABLE. CONTRACTOR SHALL LABEL DISCONNECT AS SERVICE DISCONNECT.
- 25. CONTRACTOR SHALL FURNISH AND INSTALL 2-#600 KCMIL, #600 KCMIL NEUTRAL, 2/0 GND, 4" CONDUIT. ALL CONDUIT CONNECTIONS SHALL BE MADE WITH MEYER TYPE HUBS. DO NOT INSTALL THROUGH FLOOR.
- 26. NOT USED.
- 27. CONTRACTOR SHALL FURNISH AND INSTALL 2—CAT. 6e CABLES FROM EACH PHONE OUTLET TO THE PATCH PANEL LOCATED IN RACK AND TERMINATE AT THE OUTLET AND AT THE PATCH PANEL. CONTRACTOR SHALL INSTALL THE CABLE IN ¾," CONDUIT. EACH PHONE OUTLET SHALL HAVE 2—CAT6e RATED RJ—45 JACKS AND SHALL BE MOUNTED 48" ABOVE THE FINISHED FLOOR TO TOP OF OUTLET.

28. CONTRACTOR SHALL FURNISH AND INSTALL A NEMA 3R, 16"X16", PULL BOX, ON OUTSIDE OF BUILDING. CONTRACTOR SHALL FURNISH AND INSTALL TWO 2" CONDUITS FROM BOX TO RACK

IN STORAGE RM 103.

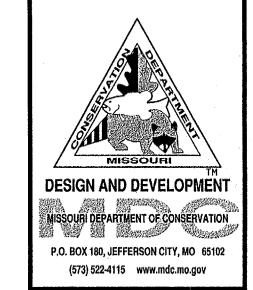



JEFFREY D. KRUMM
ELECTRICAL ENGINEER
E-27490

SHEPHERD OF THE HILLS FISH HATCHERY

STORAGE BUILDING IMPROVEMENTS

TANEY COUNTY

0 12/7/16 ISSUED

MARK DATE DESCRIPTION

ISSUE

PROJECT NO: **56-01-64**CAD DWG FILE: 56-01-64 E-104.dw

DRAWN BY: JMT
DESIGNED BY: JDK
CHECKED BY:

WORKSHOP POWER


PLAN


WIRING

E-103



2 WORKSHOP LIGHTING PLAN
SCALE: 1/4" = 1'-0"

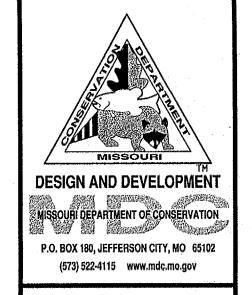

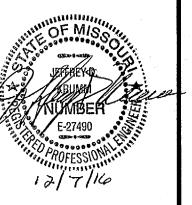

JEFFREY D. KRUMM
ELECTRICAL ENGINEER
F-27490

SHEPHERD OF THE HILLS FISH HATCHERY

STORAGE BUILDING IMPROVEMENTS

TANEY COUNTY

NOTES:

- 1. CONTRACTOR SHALL MOUNT LIGHT FIXTURE TO UNISTRUT P1000 SERIES AND MOUNT UNISTRUT TO CEILING.
- 2. CONTRACTOR SHALL MOUNT LIGHT FIXTURES 12'-6" MINIMUM ABOVE THE FINISHED FLOOR TO BOTTOM OF FIXTURE.
- 3. MOUNT LIGHT FIXTURE 10'-0" ABOVE GRADE.
- 4. CONTRACTOR SHALL FURNISH AND INSTALL CAT 50 CABLE, WHITE IN COLOR. CONTRACTOR SHALL FURNISH AND INSTALL UNBOOTED RJ-45 MALE ENDS ON CABLE AND TEST CABLE, CABLE SHALL BE INSTALLED IN CONDUIT.
- 5. CONTRACTOR SHALL FURNISH AND INSTALL A WALL MOUNTED SWITCH, SENSORSWITCH CAT. #PODMDX. MOUNT 48" ABOVE FINISHED FLOOR TO TOP OF SWITCH.
- 6. CONTRACTOR SHALL FURNISH AND INSTALL A WALL MOUNTED OCCUPANCY SENSOR, SENSORSWITCH CAT.#NWSXLV. MOUNT 48" ABOVE FINISHED FLOOR TO TOP OF SWITCH.
- 7. CONTRACTOR SHALL FURNISH AND INSTALL A SENSOR SWITCH POWER SUPPLY CAT. #nPP16 TO PROVIDE POWER TO EXHAUST FAN, CONTRACTOR SHALL FURNISH AND INSTALL A CAT 5e CABLE FROM OCCUPANCY SENSOR TO POWER PACK.

GENERAL NOTES:

- 1. EACH CIRCUIT SHALL HAVE A DEDICATED NEUTRAL SHARED NEUTRALS WILL NOT BE ALLOWED.
- CONTRACTOR SHALL NOT INSTALL MORE THAN SIX (6) CURRENT CARRYING CONDUCTORS IN A RACEWAY. NEUTRALS SHALL BE COUNTED AS A CURRENT CARRYING CONDUCTOR.
- 3. ALL CONDUIT IS ¾" OR LARGER, UNLESS OTHERWISE NOTED.
- 4. ALL OUTLETS SHALL BE INSTALLED 48" ABOVE FINISHED FLOOR TO TOP OF RECEPTACLE UNLESS OTHERWISE NOTED.
- 5. ALL SWITCHES SHALL BE INSTALLED 48" ABOVE FINISHED FLOOR TO TOP OF SWITCH UNLESS
- 6. CONTRACTOR SHALL LABEL ALL CIRCUITS AT TERMINATION POINTS AND IN ALL JUNCTION BOXES.
- 7. CONTRACTOR SHALL LABEL ALL CIRCUITS AT TERMINATION POINTS AND IN ALL JUNCTION BOXES AND LABEL ALL RECEPTACLES AND SWITCHES WITH CIRCUIT DESIGNATION.
- 8. THE AREA FROM THE FLOOR UP TO 18" AFF IS A CLASS I DIV II HAZARDOUS LOCATION, DO NOT INSTALL EQUIPMENT OR CONDUIT IN THIS AREA. CONTRACTOR SHALL COMPLY WITH THE LATEST EDITION OF THE NATIONAL ELECTRIC CODE FOR ALL CABLE CONDUIT AND ELECTRICAL EQUIPMENT INSTALLED IN MAINTENANCE BUILDING.

0 12/6/16 ISSUED

MARK DATE DESCRIPTION

ISSUE

PROJECT NO: **56-01-64**

CAD DWG FILE:
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DRAWN BY: JMT


DESIGNED BY: JDK
CHECKED BY:

WORKSHOP

LIGHTING PLAN


E-104SHEET **29** OF **30**

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		LIGHT FIXT	URE	SCHE	DULE	
MARK	DESCRIPTION	LAMPS		T	MEG AND GATALOG NO	DEMARKO
WAIN	DESCRIPTION	TYPE	NO	VOLTS	MFG. AND CATALOG NO.	REMARKS .
L1	LED STRIPLIGHT	LED	_	120V	LITHONIA ZL1NLEDL96FSTMVOLT35K80CRIWHNPP16D	
L2	LED SURFACE	LED		120V	LITHONIA WL420LEZ1LP835N100	
L3	WALL PACK	LED	2	120V	LITHONIA OFLR6LC120MOBZ	W/PHOTOCELL

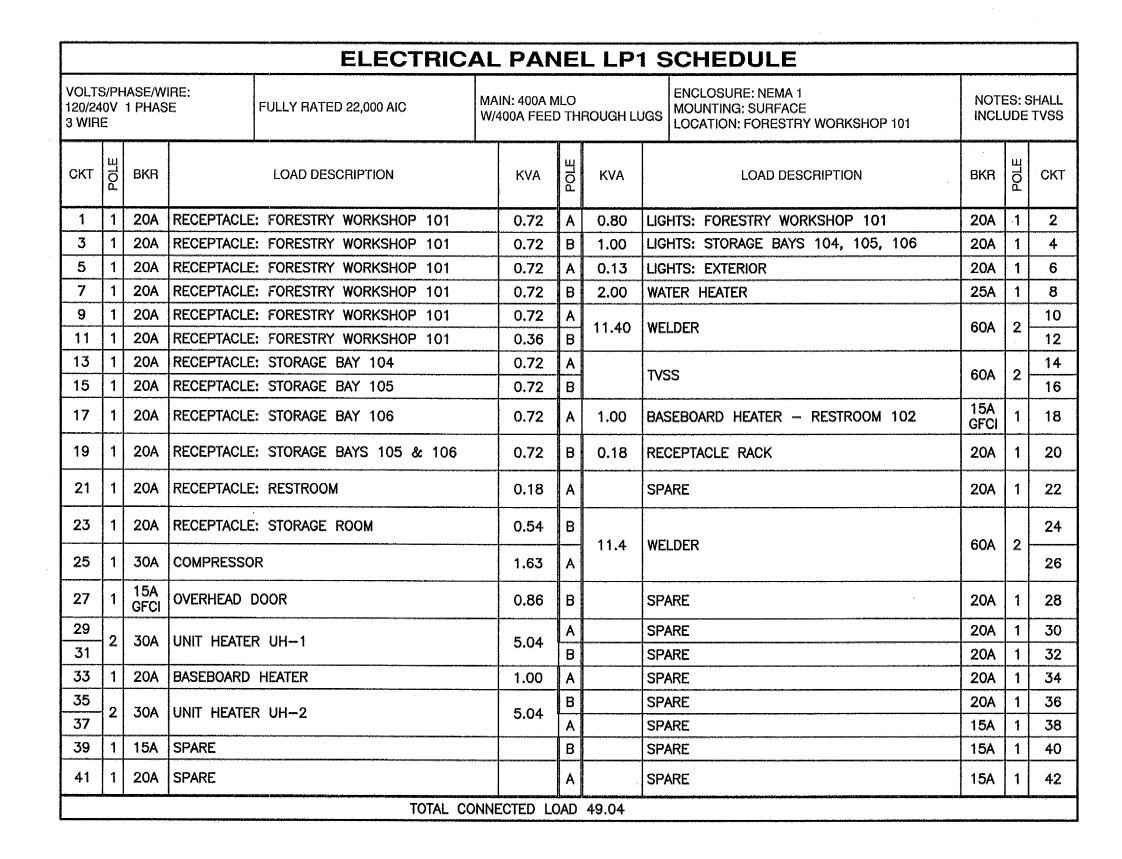



JEFFREY D. KRUMM ELECTRICAL ENGINEER E-27490

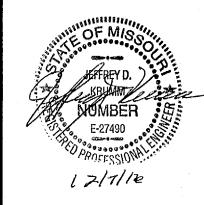SHEPHERD OF THE HILLS FISH HATCHERY

STORAGE BUILDING IMPROVEMENTS

TANEY COUNTY

	12/6/16	ISSUED	
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D D	WG FILE	•	
		56-01-64	E-601.dwa

CAD DWG FILE: 56-01-64_E-60 DRAWN BY: JMT

DESIGNED BY: JDK
CHECKED BY:
SHEET TITLE

WORKSHOP ELECTRICAL SCHEDULES

E-601


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FOR REFERENCE ONLY - PRELIMINARY REPRESENTATION BY OTHERS TO ILLUSTRATE GENERAL DESIGN INTENT OF EXHIBITS. DRAWING IS NOT INTENDED TO INDICATE THE ENTIRE EXTENTS OF FINISHED PRODUCT OR EXACT REQUIREMENTS OF EXHIBIT INSTALLATION. EXHIBITS SHALL BE BY OWNER. COORDINATE EXACT REQUIREMENTS WITH OWNER AND EXHIBITS CONTRACTOR PRIOR TO CONSTRUCTION.

10.27.16 Issued: Revised: AS NOTED Z Scale: Drawn: Checked: 14023

Plotted On: 10/26/16



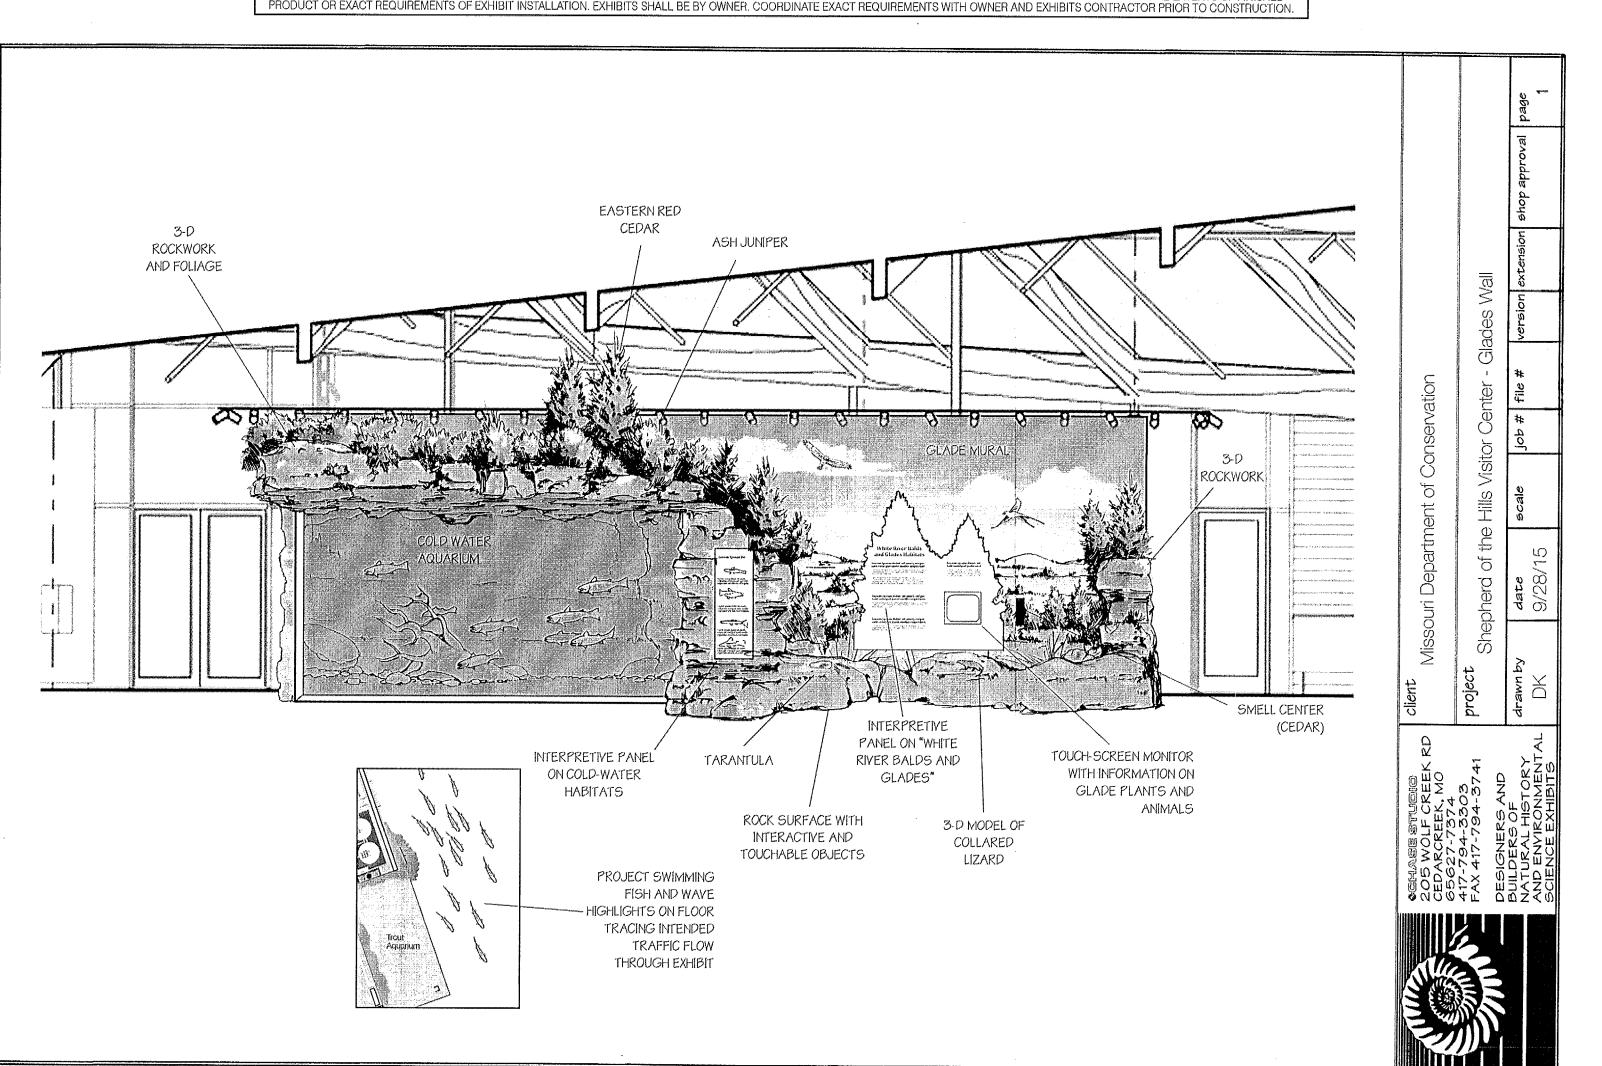

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Checked: 14023

10.27.16

AS NOTED

Plotted On: 10/26/16


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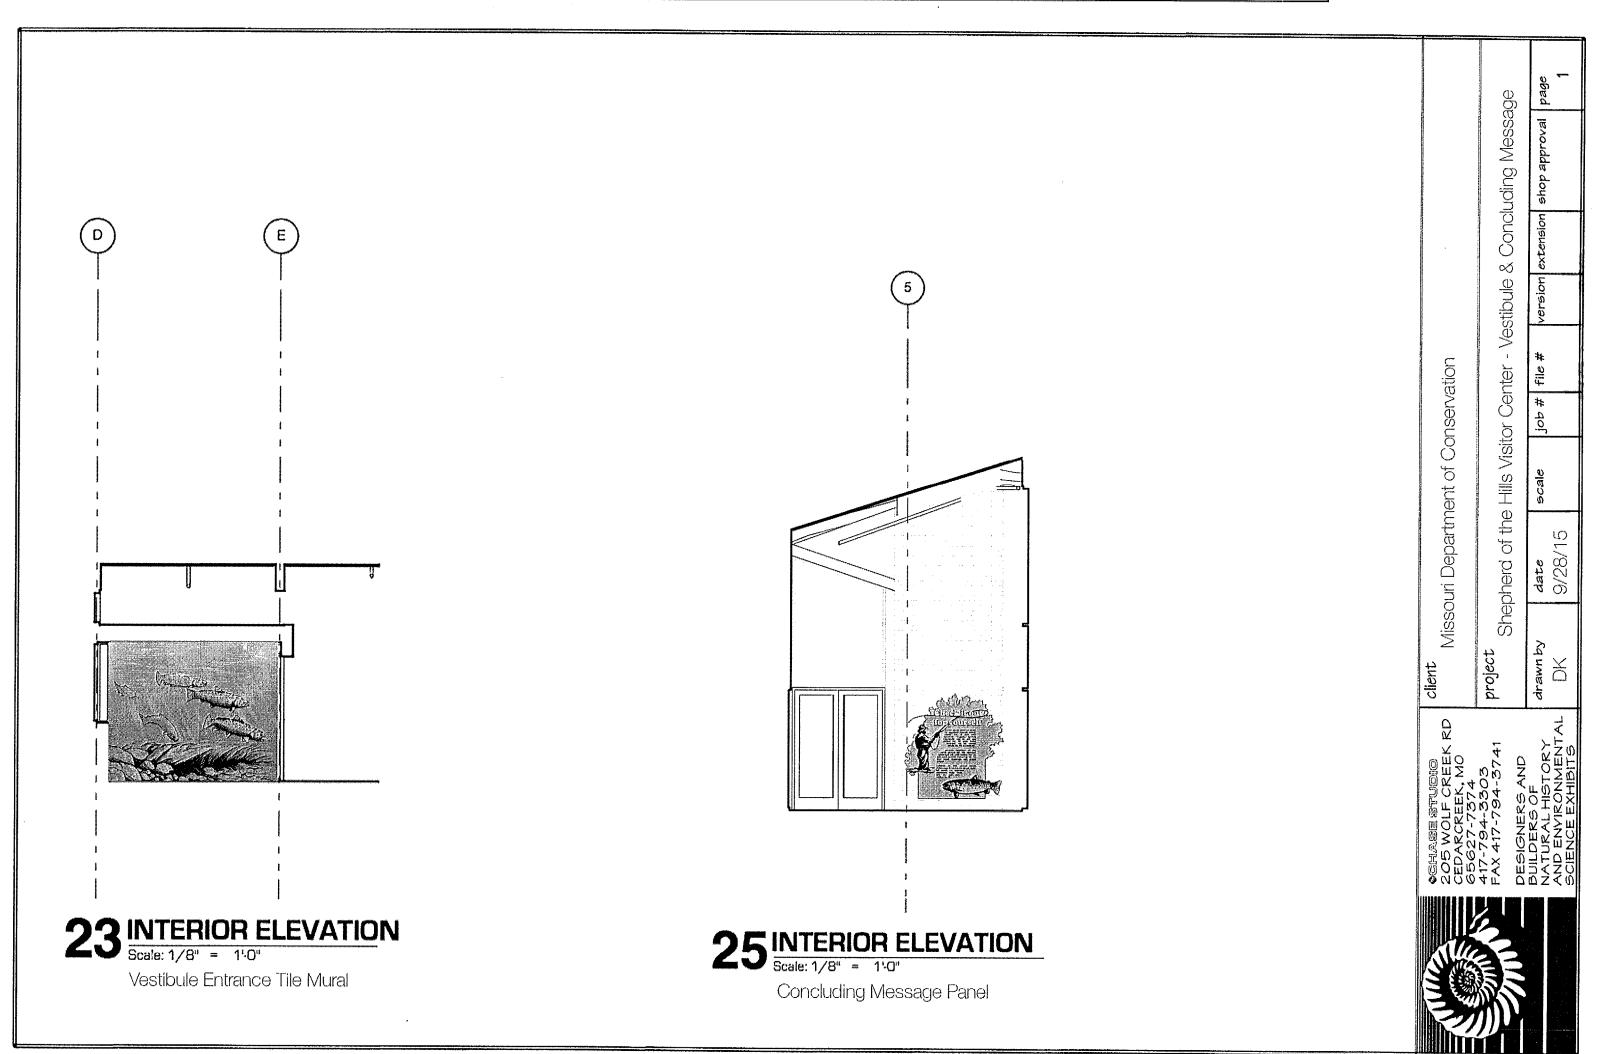
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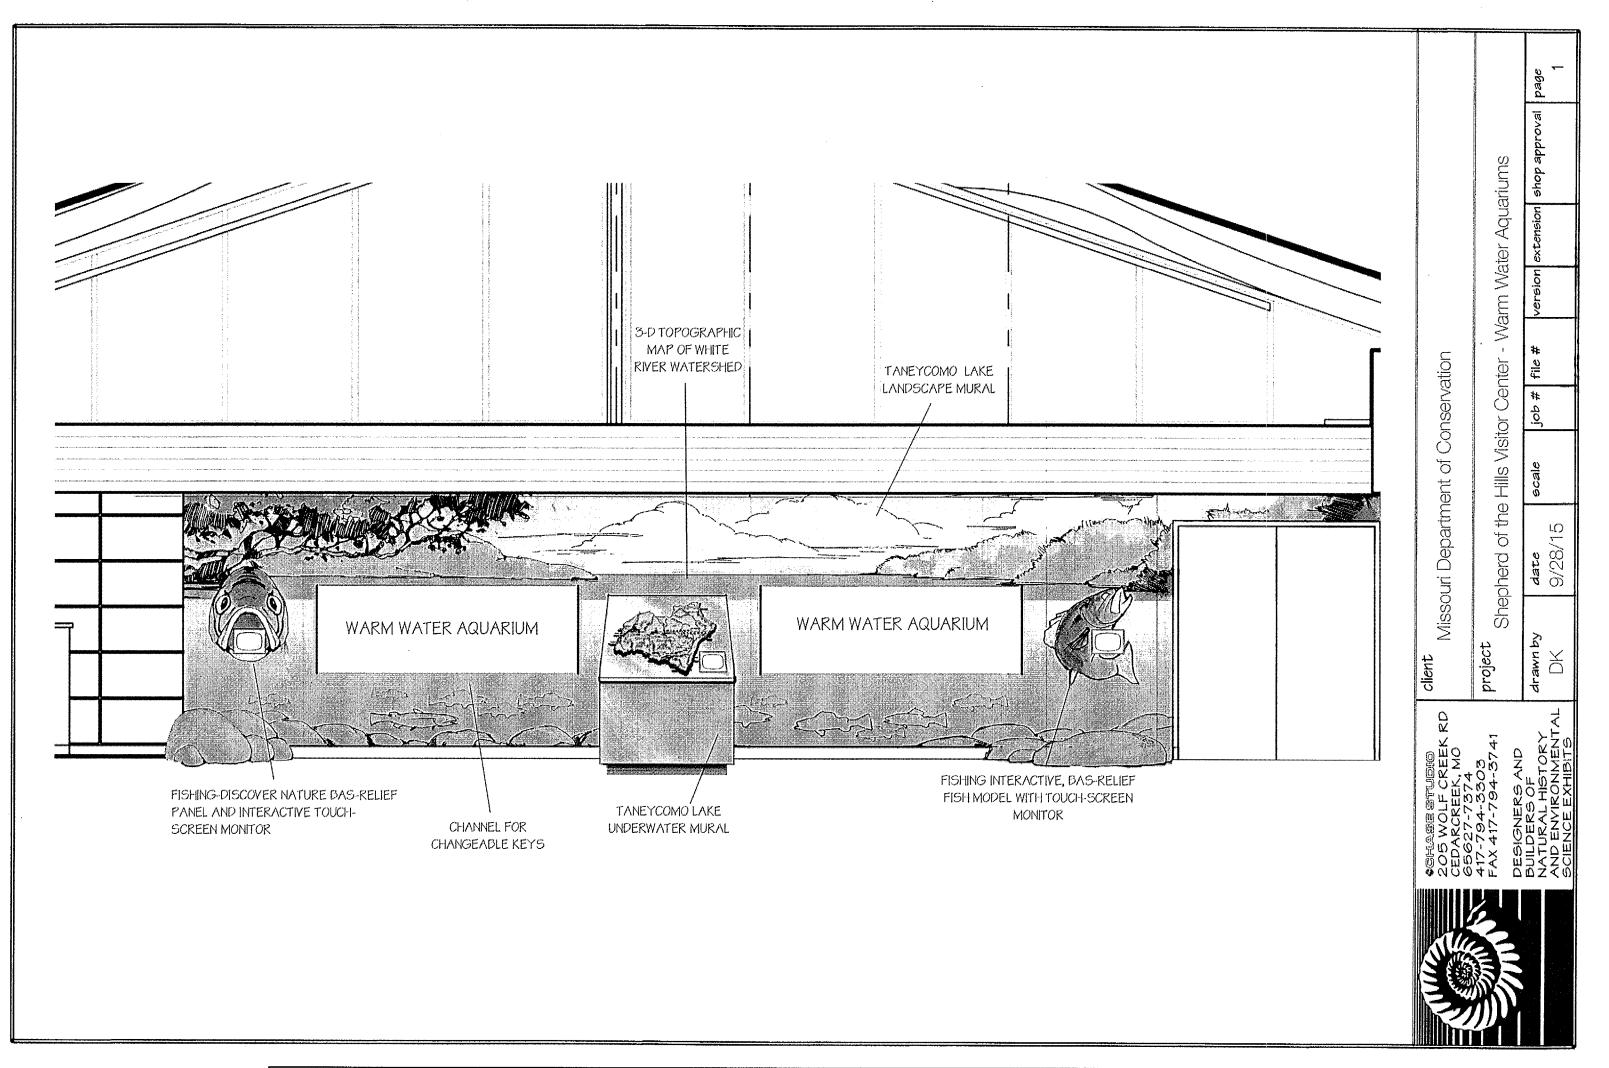


SHEPHERD OF THE HILLS CONSERVATION NATURE CENTER AND FISH HATCHERY


Issued: 10.27.16
Revised: Scale: AS NOTED
Drawn: Checked: Job: 14023

EX2.2

FOR REFERENCE ONLY - PRELIMINARY REPRESENTATION BY OTHERS TO ILLUSTRATE GENERAL DESIGN INTENT OF EXHIBITS. DRAWING IS NOT INTENDED TO INDICATE THE ENTIRE EXTENTS OF FINISHED PRODUCT OR EXACT REQUIREMENTS OF EXHIBIT INSTALLATION. EXHIBITS SHALL BE BY OWNER. COORDINATE EXACT REQUIREMENTS WITH OWNER AND EXHIBITS CONTRACTOR PRIOR TO CONSTRUCTION.

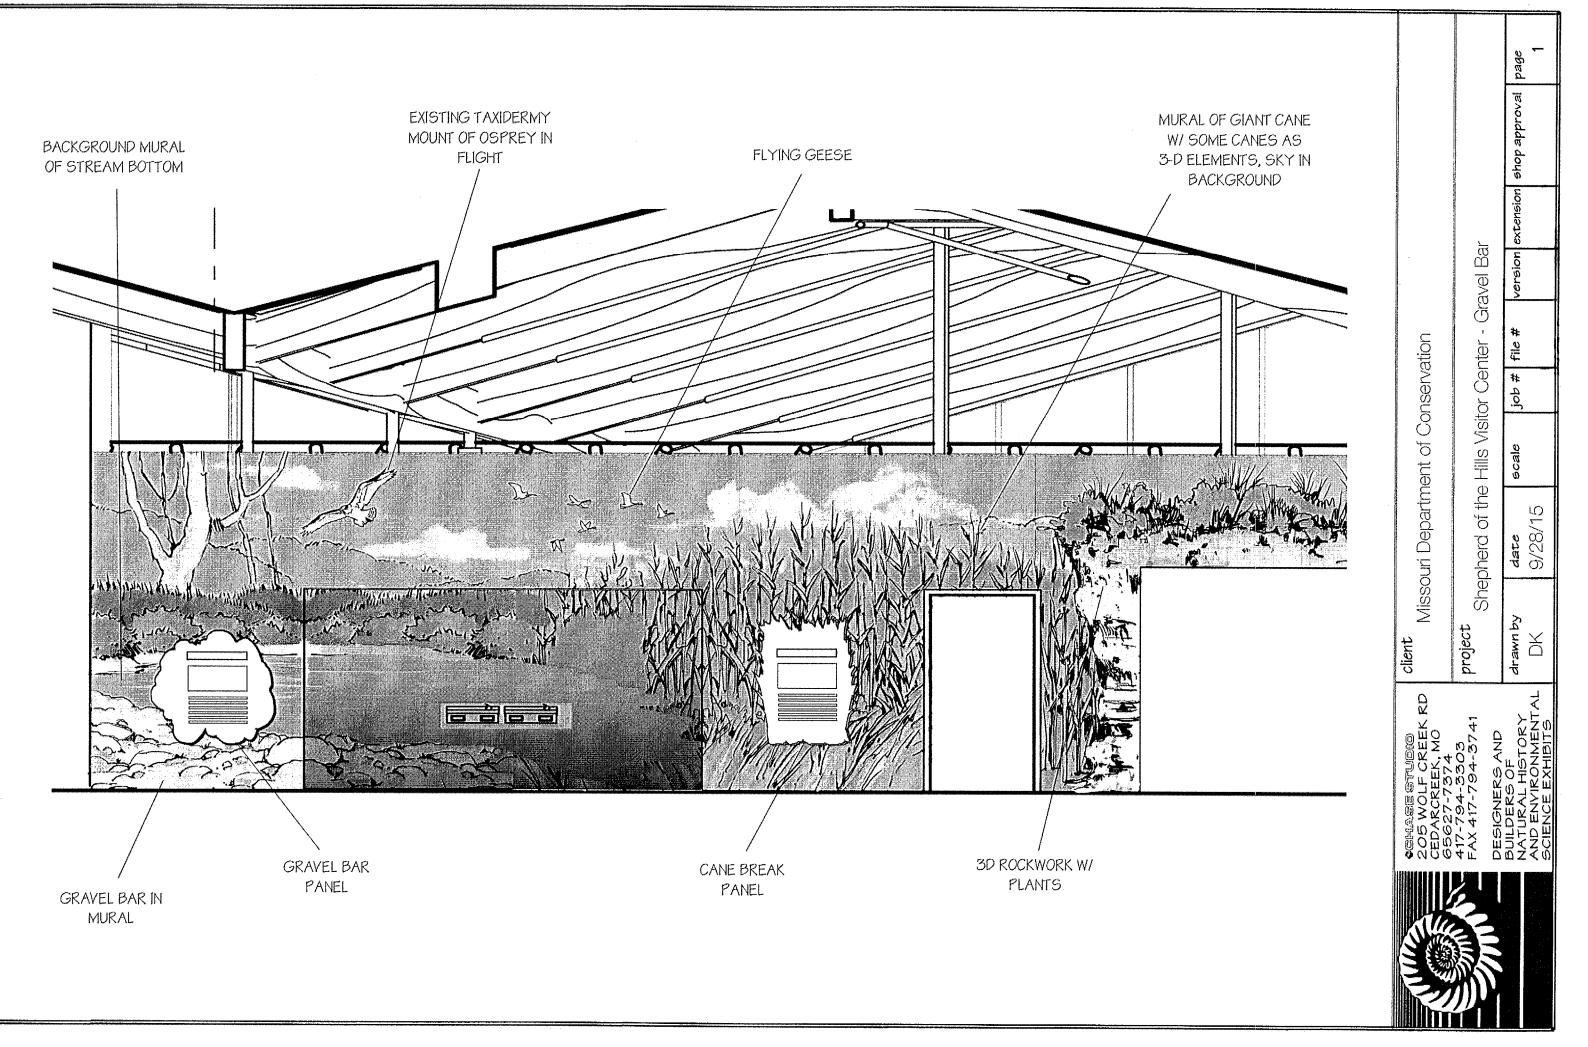

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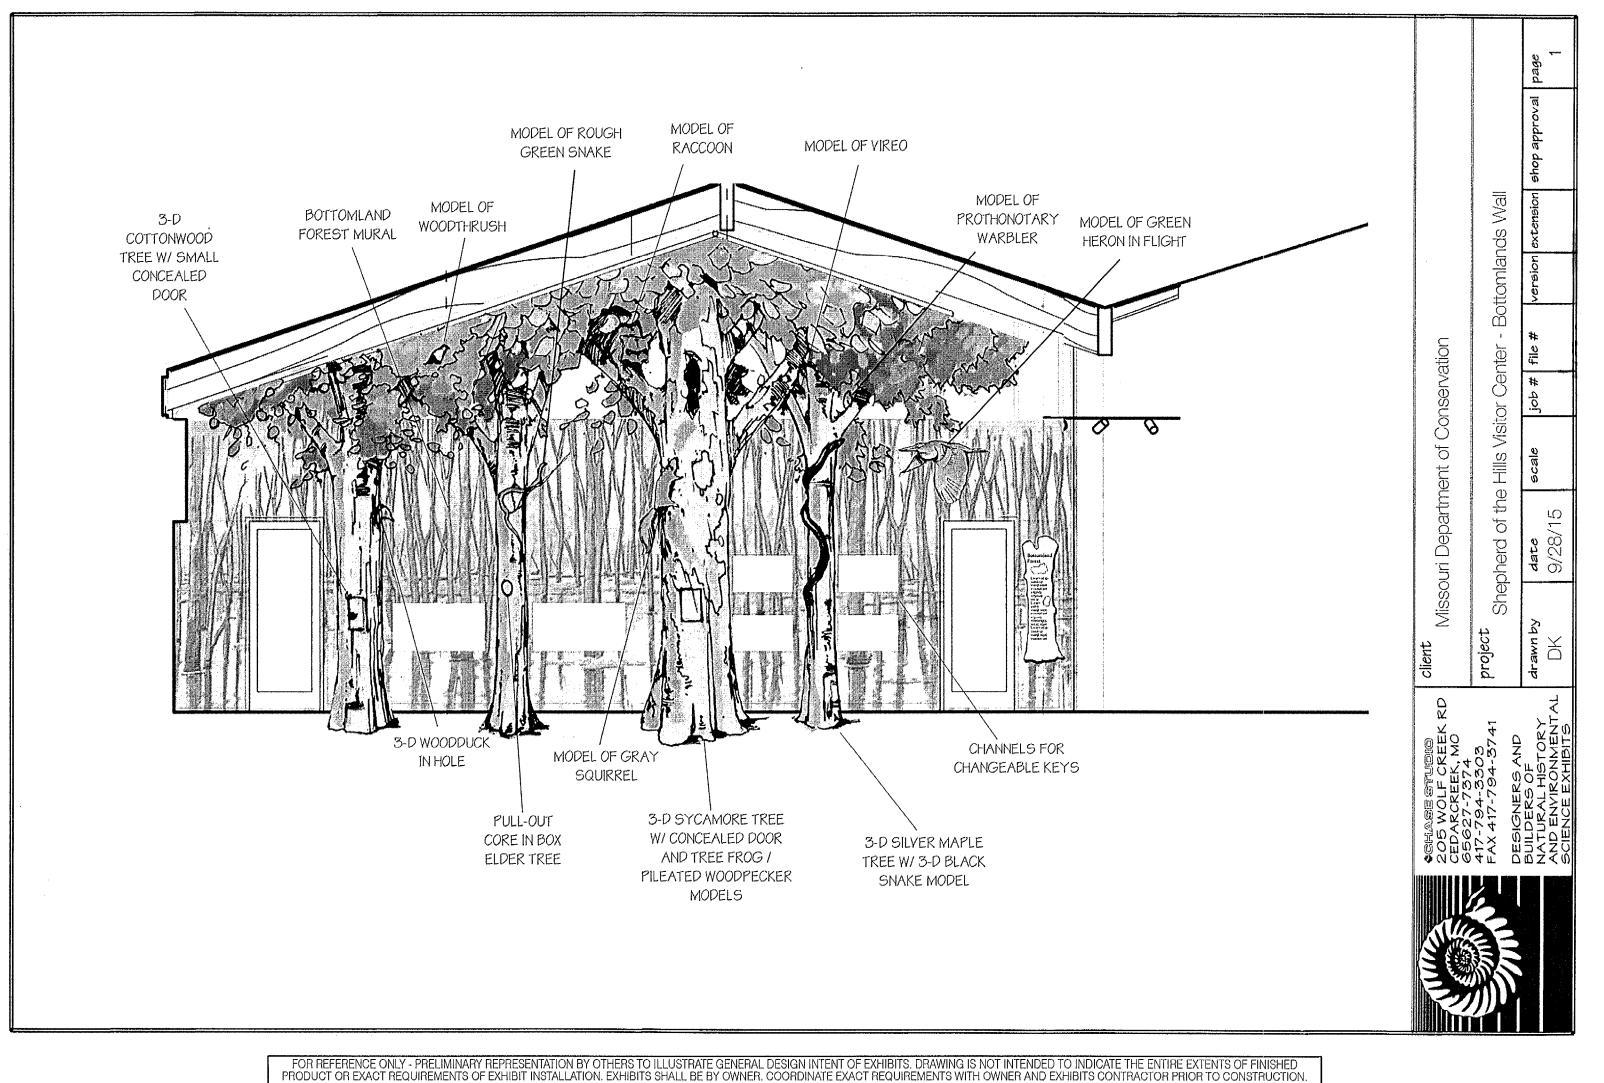
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10.27.16 Issued:

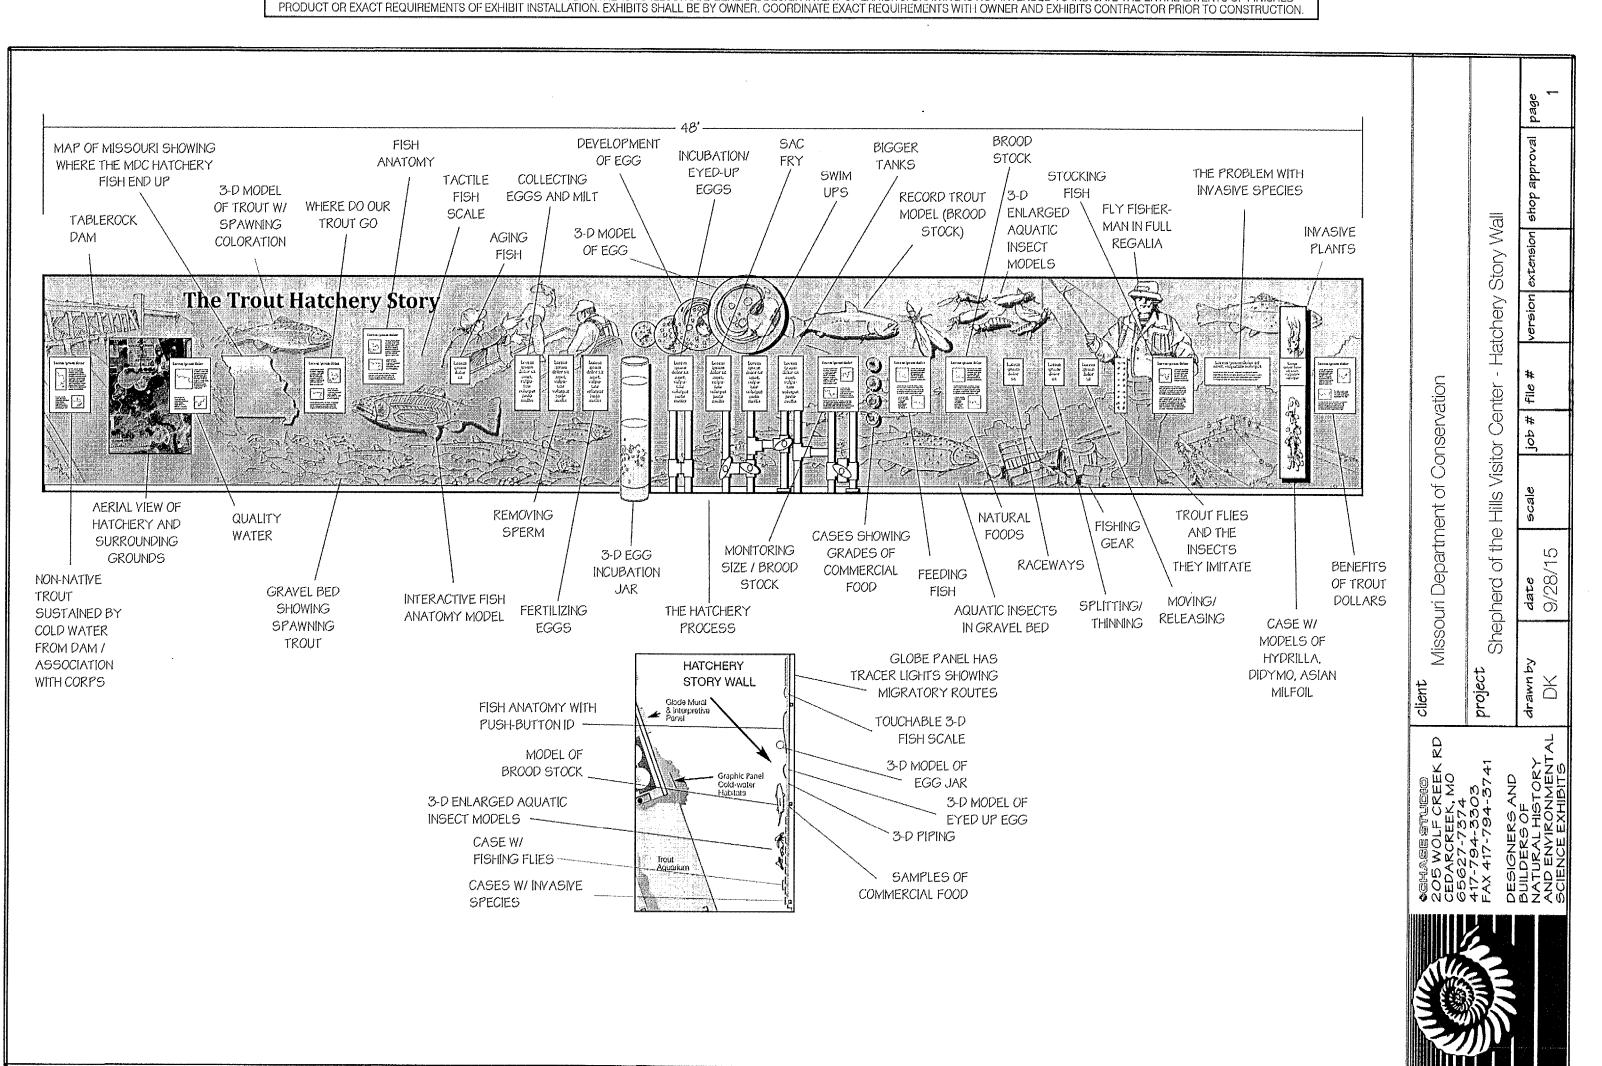Revised: AS NOTED Scale: Drawn: Checked: 14023

Plotted On: 10/26/16

FOR REFERENCE ONLY - PRELIMINARY REPRESENTATION BY OTHERS TO ILLUSTRATE GENERAL DESIGN INTENT OF EXHIBITS. DRAWING IS NOT INTENDED TO INDICATE THE ENTIRE EXTENTS OF FINISHED PRODUCT OR EXACT REQUIREMENTS OF EXHIBIT INSTALLATION. EXHIBITS SHALL BE BY OWNER. COORDINATE EXACT REQUIREMENTS WITH OWNER AND EXHIBITS CONTRACTOR PRIOR TO CONSTRUCTION.





AKE | WELLS

SHEPHERD OF THE HILLS CONSERNATURE CENTER AND FISH HATCH
MISSOURI DEPARTMENT OF CONSERVAT
Hatchery Road
Branson, MO 65616

EXHIBIT ELEVATIONS EX2.4

SHEPHERD OF THE HILLS FISH HATCHERY STORAGE BUILDING IMPROVEMENTS

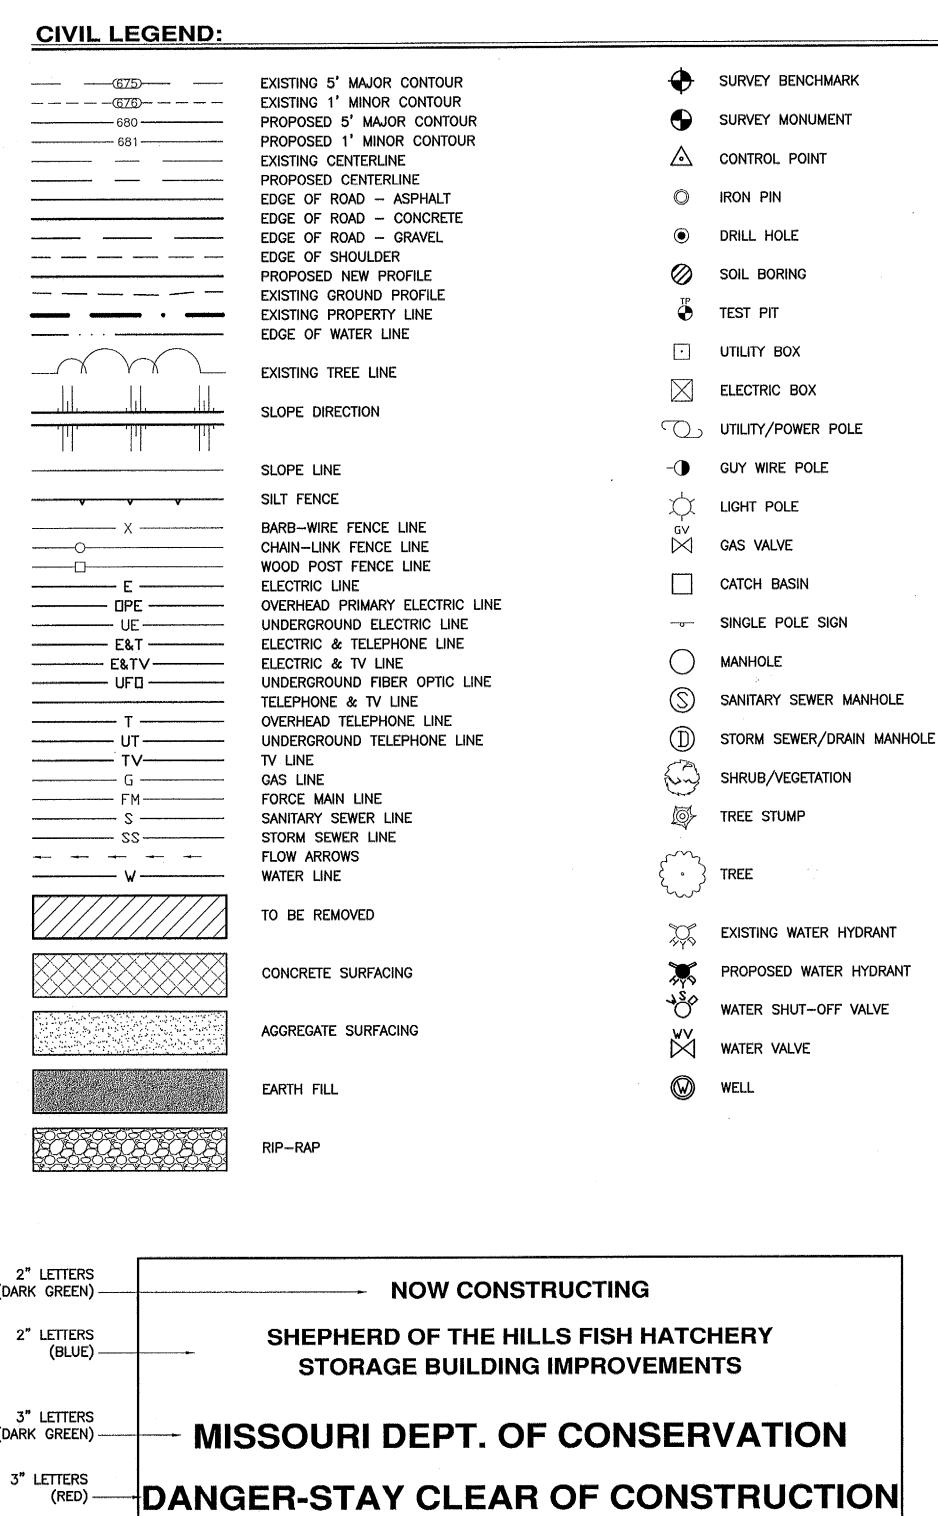

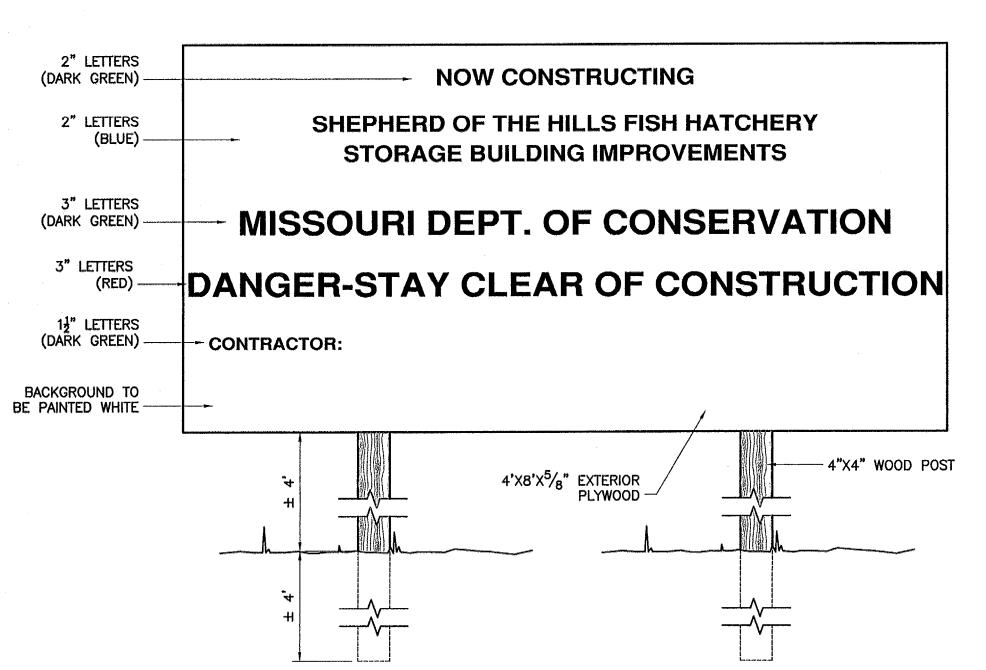

CONSTRUCTION SIGN DETAIL

ABBREVIA	TIONS LE
AFF	ABOVE FINIS
ADA	AMERICANS \
ALUM	ALUMINUM
<u>ا</u>	ANGLE
APPROX	APPROXIMATE
©	AT
ВМ	BEAM
BRG HT	BEARING HEI
BOT	воттом
BLDG	BUILDING
BLK	BLOCK
BP	BEGINNING P
BVCE	BEGIN VERTIC
BVCS	BEGIN VERTIC
CI	CAST IRON
CLG	CEILING
Q	CENTERLINE
c/c	CENTERLINE
CLR	CLEAR
CO	CLEAN OUT
CONC	CONCRETE
CFM	CUBIC FEET
CMP	CORRUGATED
	CENTERS
CNTRS	
CONST	CONSTRUCTION
CONT	CONTINUOUS
DI	DUCTILE IRO
DIA OR Ø	DIAMETER
DND	DO NOT DIS
DS	DOWNSPOUT
DTL.	DETAIL
E	EASTING
EF	EACH FACE
EF	EXHAUST FAI
EG	EXISTING GR
EL OR ELEV	ELEVATION
EP	END POINT
EW	EACH WAY
EQ	EQUAL
EQ SP	EQUALLY SPA
EQUIP	EQUIPMENT
EVCE	END VERTICA
EVCS	END VERTICA
EXIST.	EXISTING
EXP	EXPANSION
FFE	FINISH FLOO
FIN	FINISH
FCO	FLOOR CLEA
FD	FLOOR DRAIN
	FINISH GRAD
FG	
FL.	FLOW LINE
FLR	FLOOR
FT	FEET
GALV	GALVANIZED
GND	GROUND
GYP BRD	GYPSUM BOA
НМ	HOLLOW MET
HB	HOSE BIB O
HOR	HORIZONTAL
ID	INSIDE DIAME
ΙE	INVERT ELEV
INV	INVERT
INSUL	INSULATION
ID	INSOLATION

IRON PIN

LOUVER

LENGTH OF VERTICAL CURVE

EGEND: SHED FLOOR MANUFACTURING/MANUFACTURER MAXIMUM WITH DISABILITY ACT MAN HOLE MASONRY OPENING MOISTURE RESISTANT MINIMUM EIGHT MONUMENT NORTHING NOT IN CONTRACT NOT TO SCALE NUMBER TICAL CURVE ELEVATION ON CENTER OPENING TICAL CURVE STATION **OUTSIDE DIAMETER** PLATE STEEL POINT OF CURVATURE TO CENTERLINE POLYETHYLENE PERFORATED POINT OF INTERSECTION PLYWOOD PER MINUTE POINT POWER POLE ED METAL PIPE POINT OF TANGENCY POLYVINYL CHLORIDE POINT VERTICAL INTERSECTION RADIUS STURB RCWY OR RACEWAY REINFORCEMENT REINFORCED CONCRETE PIPE ROUGH OPENING ROUND ROW RIGHT OF WAY SANITARY (SEWER) SCHEDULE SCHED SCHEDULED SHEET STORM SEWER AL CURVE ELEVATION SERVICE SINK STAINLESS STEEL OR ELEVATION SQUARE SIDE WALK TOP OF CONCRETE TOP OF CURB TOP OF WALL TOP OF FOOTING TOP OF FOUNDATION TOP OF STEEL TYPICAL UNLESS NOTED OTHERWISE VERTICAL CURVE OR WALL HYDRANT METER VOLUME WATER CLEAN OUT VATION WELDED WIRE FABRIC

APPLICABLE BUILDING CODES: CODES AND ORDINANCES ADOPTED BY THE CITY OF BRANSON INCLUDING BUT NOT LIMITED TO: INTERNATIONAL BUILDING CODE 2015 INTERNATIONAL MECHANICAL CODE 2015 INTERNATIONAL PLUMBING CODE 2015 INTERNATIONAL FIRE CODE 2015 NATIONAL ELECTRIC CODE 2014 ICC/ANSI A117.1-2009 NFPA 13 CODE STUDY: GROSS AREA: 2046 SQ FT CONSTRUCTION TYPE: VB SPRINKLED: NO OCCUPANCY GROUP: U-FORESTRY WORKSHOP - 768 SQ FT

REQUIRED 2 HR SEPARATION BETWEEN U AND S-1 OCC. ALLOWABLE AREA: 1 STORY (UNSPRINKLED) OCC GROUP U: 5,500 SQ FT 1 STORY (UNSPRINKLED) OCC GROUP SO1: 9,000 SQ FT

ALLOWABLE HEIGHT: 40' OCCUPANCY LOAD: 15 OCCUPANTS (SEE PLAN)

STORAGE: N/A NUMBER OF EXITS PROVIDED: 2

EXIT PATH < 100 FT MAX

MIN DOOR WIDTH: 32"

WC 1 PER 100 REQUIRED: 1 PROVIDED (SEP FACILITIES NOT REQ'D FOR OCC OF 15 OR LESS) LAV1 PER 100 REQUIRED: 1 PROVIDED (SEP FACILITIES NOT REQ'D FOR

SERVICE SINK: REQUIRED AND PROVIDED DRINKING FOUNTAIN: NOT REQUIRED FOR OCCUPANCIES 15 OR FEWER

SERVICE SINK: REQUIRED AND PROVIDED

OCCUPANCY GROUP: S-1 - STORAGE - 1076 SQ FT

ALLOWABLE AREA: 5,500 SQ FT

WORKSHOP: 50 NET 768 SQ FT = 15

NUMBER OF EXITS REQUIRED:

OCC OF 15 OR LESS)

SHEET INDEX SHEET SHEET ID SHEET TITLE COVER SHEET VICINITY MAP DRAWING INDEX & LEGEND GENERAL DEMOLITION & SITE PLAN FIELD OFFICE DEMOLITION SITE PLAN WORKSHOP SITE PLAN SANITARY SEWER PLAN & PROFILE C-104 WATERLINE PLAN & PROFILE WATERLINE PLAN & PROFILE C-106 WATERLINE PLAN & PROFILE WATERLINE PLAN & PROFILE C-108 WATERLINE PLAN & PROFILE WATERLINE (FIRE) PLAN & PROFILE WATERLINE (FIRE) PLAN & PROFILE TRAFFIC CONTROL PLAN C-112 EROSION CONTROL PLAN SITE DETAILS C-502 SITE DETAILS Z-517 EROSION CONTROL DETAILS WORKSHOP PLANS WORKSHOP ELEVATIONS WORKSHOP SECTION & DETAILS DETAILS SCHEDULES WORKSHOP PLUMBING PLAN WORKSHOP HVAC PLAN ELECTRICAL LEGEND

ELECTRICAL SITE PLAN

E-103 WORKSHOP POWER WIRING PLAN

E-601 WORKSHOP ELECTRICAL SCHEDULES

E-104 WORKSHOP LIGHTING PLAN

COMMUNI- CATIONS SITE PLAN

PE-2015007441

DESIGN AND DEVELOPMENT

P.O. BOX 180, JEFFERSON CITY, MO 65102

(573) 522-4115 www.mdc.mo.gov


CIVIL ENGINEER PE-2015007441

CHITRA B. POUDEL

SHEPHERD OF THE HILLS FISH **HATCHERY**

STORAGE BUILDING **IMPROVEMENTS**

TANEY COUNTY

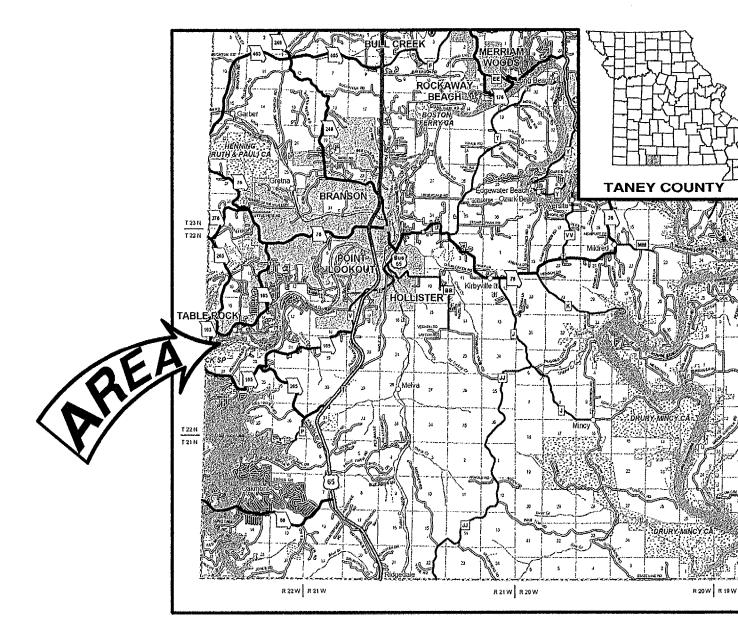

VICINITY MAP


0 15/6/16 IZZUED MARK DATE DESCRIPTION PROJECT NO: **56-01-64**

CAD DWG FILE: 56-01-64_G-001.dw DRAWN BY: JMT

DESIGNED BY: CBP CHECKED BY: SHEET TITLE

VICINITY MAP DRAWING INDEX & **LEGEND**

G-001

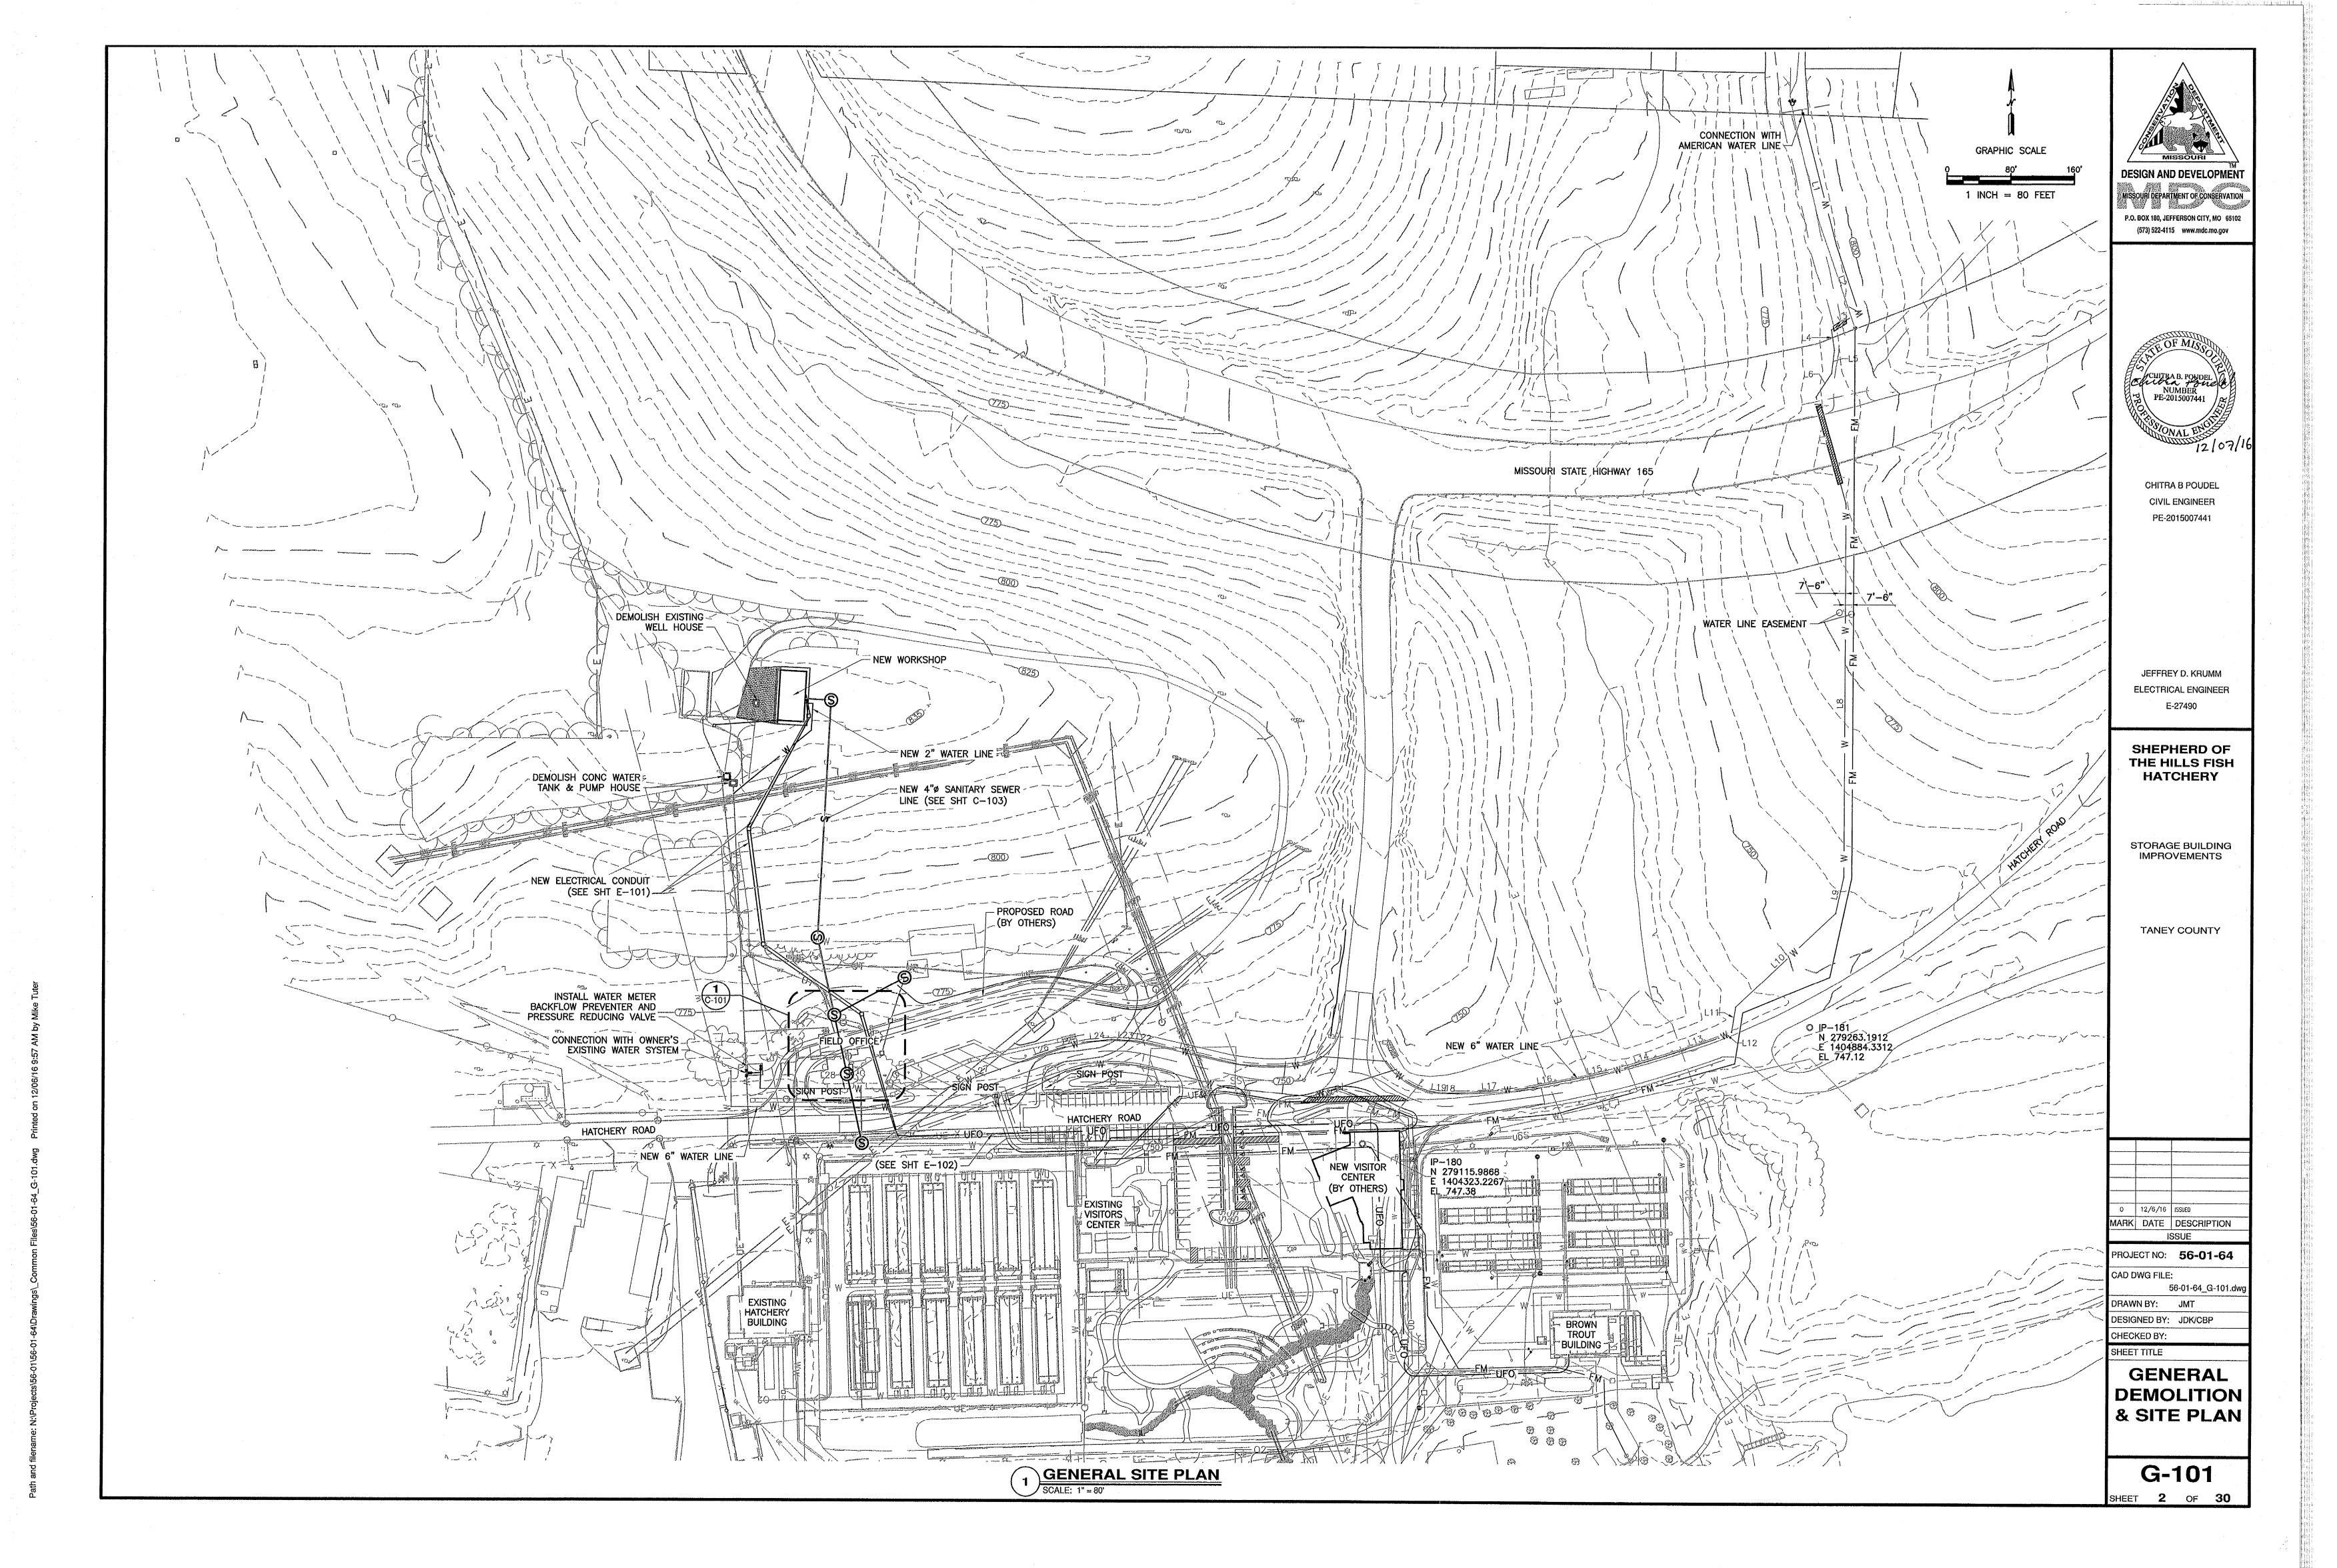

PLANTING NOTES:

- CONTRACTOR SHALL COMPLY WITH ALL FEDERAL, STATE AND LOCAL LAWS AND REGULATIONS PERTAINING TO THE INSPECTION FOR PLANT DISEASE AND INSECT INFESTATION.
- 2. OWNER'S REPRESENTATIVE SHALL APPROVE ALL PLANT MATERIAL AND PLACEMENT PRIOR TO INSTALLATION. CONTACT OWNER'S REPRESENTATIVE AT LEAST TWO (2) WEEKS PRIOR TO REVIEW.
- 3. ALL TREES AND SHRUBS SHALL EQUAL OR SURPASS AMERICAN STANDARDS FOR NURSERY STOCK ANSI Z60.1, 2004 FOR SIZE AND QUALITY.
- 4. CONTRACTOR SHALL VERIFY THE PLANT MATERIAL IS PROPERLY LABELED, IS OF PROPER SIZE, HAS A WELL DEVELOPED BRANCH AND ROOT STRUCTURE, AND IS IN ACCORDANCE WITH THE AMERICAN ASSOCIATION OF NURSERYMEN. COMPLY WITH THE FOLLOWING:
 - A. DO NOT PRUNE PLANT MATERIAL PRIOR TO DELIVERY WITHOUT SPECIFIC APPROVAL BY OWNER'S REPRESENTATIVE.
 - B. PLANTS ARE SUBJECT TO OWNER'S REPRESENTATIVE INSPECTION FOR SIZE, VARIETY, CONDITION, LATENT DEFECTS AND INJURY AT THE PLACE OF GROWTH AND AT THE PROJECT SITE AT ANY TIME BEFORE AND DURING PROGRESS OF WORK.
 - C. WHEN REQUESTED BY OWNER'S REPRESENTATIVE, SHOW SAMPLES TO PROVE THAT NO ROOT BOUND CONDITIONS EXIST
 - REMOVE REJECTED PLANTS FROM THE SITE IMMEDIATELY AND REPLACE WITH APPROVED MATERIALS.
 - E. REPLACEMENT PLANTS SHALL BE THE SAME TYPE AND SIZE AS ORIGINALLY PLANTED.
- 5. SUBSTITUTIONS WILL NOT BE PERMITTED WITHOUT THE OWNER'S REPRESENTATIVE'S WRITTEN APPROVAL.
- 6. CONTRACTOR SHALL PROVIDE A WRITTEN GUARANTEE TO THE OWNER THAT ALL TREES, SHRUBS, AND PLANT MATERIALS WILL MAINTAIN VIGOROUS AND HEALTHY GROWTH FOR THE SPECIFIED GUARANTEE PERIOD, UNLESS OTHERWISE STATED.
- 7. GUARANTEE PERIOD SHALL BEGIN UPON SUBSTANTIAL COMPLETION OF WORK AFTER SUCCESSFUL COMPLETION OF THE SPECIFIED MAINTENANCE PERIOD.
- 8. CONTRACTOR SHALL REMOVE TAGS, LABELS, NURSERY STAKES, WIRE BASKETS OR CAGES, AND TIES FROM ALL PLANTS
- 9. SOIL PREPARATION, FERTILIZATION, PLANTING, AND STAKING AND GUYING SHALL CONFORM TO DETAILS AND SPECIFICATIONS.
- 10. PLANT MATERIAL QUANTITIES ARE PROVIDED FOR PRELIMINARY COST ESTIMATE PURPOSES ONLY. LANDSCAPE CONTRACTOR IS RESPONSIBLE FOR VERIFYING QUANTITIES AS SHOWN ON PLANS.
- 11. CONTRACTOR SHALL COORDINATE LOCATION OF PLANT MATERIAL WITH ALL OTHER CONTRACTORS.
- 12. ALL PLANT PIT EXCAVATION SHALL BE PER DETAILS AND SPECIFICATIONS.
- 13. IF PLANTING PITS ARE EXCAVATED USING A POWER AUGER, BREAK VERTICAL SIDES WITH A BALLING BAR OR SPADE TO INTERRUPT CONTINUOUS CURVE INFLUENCE ON ROOT DEVELOPMENT
- 14. CONTRACTOR SHALL KILL AND REMOVE ALL EXISTING WEEDS FROM
- 15. BERMS AND SLOPES ADJACENT TO PAVEMENT TO BE GRADED PER
- 16. CONTRACTOR SHALL REMOVE ALL EXCESS SOIL, CONTAMINATED SOILS, ROCKS, CLODS, AND DEBRIS AS IT ACCUMULATES ON A DAILY
- 17. CONTRACTOR SHALL GRADE AROUND ALL PLANTS TO FINISH GRADE UNLESS OTHERWISE NOTED.
- 18. ALL PLANTINGS, EXCLUDING SEED AND SOD, SHALL BE HELD 3' CLEAR OF FIRE HYDRANTS.
- 19. ALL PLANTING AREAS TO BE LAID OUT IN THE FIELD BY THE CONTRACTOR FOR APPROVAL BY OWNER'S REPRESENTATIVE PRIOR TO ANY CONSTRUCTION.


LAYOUT NOTES:


- DO NOT SCALE DRAWINGS. USE DIMENSIONS SHOWN.
- 2. SITE DIMENSIONS ARE TO FACE OF CURB, PROPERTY LINE OR FACE OF BUILDING UNLESS OTHERWISE NOTED. ALL DIMENSIONS AND RADII TO OR FROM CURB LINES ARE TO FACE OF CURB.
- 3. ALL WALKWAY SURFACES SHALL BE BELOW 5% SLOPE, 2% CROSS SLOPE AND SHALL MEET ALL ADA REQUIREMENTS, OR AS INDICATED.
- 4. ALL EXTERIOR PAVING FINISH FLOOR ELEVATION AT BUILDING FACADE SHALL BE 1/8" MIN., 1/4" MAX. BELOW BUILDING FINISH FLOOR ELEVATION. TYP.

GENERAL NOTES:

- 1. THESE NOTES PERTAIN TO ALL CONSTRUCTION AND THE FOLLOWING DOCUMENTS
- 2. ALL UNDERGROUND FACILITIES, STRUCTURES, AND UTILITIES HAVE BEEN PLOTTED FROM THE SURVEY PROVIDED BY THE OWNER. THEREFORE, THE RELATIONSHIP BETWEEN PROPOSED WORK AND EXISTING FACILITIES, STRUCTURES, AND UTILITIES MUST BE CONSIDERED APPROXIMATE. IT IS THE RESPONSIBILITY OF THE CONTRACTOR TO DETERMINE THE EXACT LOCATION AND EXISTENCE OF ANY UTILITIES NOT SHOWN. ALL UTILITIES SHALL BE LOCATED AND MARKED BOTH HORIZONTALLY AND VERTICALLY TO ENSURE CLEARANCE OF ANY PROPOSED SITE WORK, UTILITY COMPANY REPRESENTATIVES SHALL BE ON SITE DURING TIMES OF EXCAVATION IN THE VICINITY OF THEIR FACILITIES. ANY DISCREPANCIES, OMISSIONS, AND/OR CONFLICTS TO BE ADDRESSED TO OWNER'S REPRESENTATIVE PRIOR TO CONTINUATION OF WORK
- 3. ALL ELEVATIONS ARE BASED ON INFORMATION PROVIDED BY THE OWNER. 4. ALL EXCAVATION, WHETHER THEY ARE UTILITY TRENCHES OR FOOTING EXCAVATIONS, SHALL BE CONSTRUCTED IN ACCORDANCE WITH THE LATEST OCCUPATIONAL SAFETY AND HEALTH ADMINISTRATION (OSHA) "CONSTRUCTION
- STANDARDS FOR EXCAVATION." PRIOR TO BEGINNING ANY WORK ON THE SITE, THE CONTRACTOR SHALL CONTACT THE OWNER FOR SPECIFIC INSTRUCTIONS RELEVANT TO THE SEQUENCING OF
- 6. THE CONTRACTOR SHALL RESTORE TO ORIGINAL CONDITION ALL "OFF SITE"
- AREAS/PROPERTY AND EASEMENTS DISTURBED BY HIS OPERATIONS 7. THE CONTRACTOR SHALL KEEP EXISTING ROADWAYS AND SIDEWALKS CLEAN OF MUD AND DEBRIS AT ALL TIMES.
- 8. CONTRACTOR SHALL VERIFY THE LOCATION OF THE EXISTING UTILITIES PRIOR TO ANY GRADING OPERATIONS AND PROTECT THE UTILITIES DURING THIS WORK
- 9. CONTRACTOR TO PROVIDE SAMPLES AND MOCK-UPS OF ALL MATERIALS FOR OWNER'S REPRESENTATIVES APPROVAL. COLORS TO BE REVIEWED AND APPROVED BY OWNER. THIS SHOULD INCLUDE SAMPLES OF:
 - ALL JOINTS, SEALANTS, AND COLORS
 - STAMPED, COLORED CONCRETE PAVING
 - PLANT MATERIAL
- BOULDERS. CONTRACTOR TO PROVIDE MOCK UP PER SPECIFICATIONS.
- 11. GENERAL CONTRACTOR SHALL COORDINATE ALL WORK BETWEEN ELECTRICAL, PLUMBING, LANDSCAPE, IRRIGATION CONTRACTORS, AND OTHER TRADES
- 12. ALL MATERIAL TYPES, COLORS, FINISHES, AND PROCESSES SHALL BE SELECTED
- AND APPROVED BY OWNER'S REPRESENTATIVE. 13. ALL BOULDERS AND PAVING TO BE LAID OUT IN THE FIELD BY THE CONTRACTOR
- FOR APPROVAL BY OWNER'S REPRESENTATIVE PRIOR TO ANY CONSTRUCTION. 14. DO NOT DISTURB ANY UTILITIES UNLESS NOTED OTHERWISE.
- 15. USE OF EXPLOSIVES AND BURNING ON-SITE WILL NOT BE PERMITTED
- SIGNS, LIGHTS, AND BARRICADES SHALL BE INSTALLED AT LOCATIONS NECESSARY TO MAINTAIN A SAFE WORK SITE CONDITION AS DIRECTED/APPROVED BY THE OWNER AND IN ACCORDANCE WITH THE MANUAL ON UNIFORM TRAFFIC CONTROL DEVICES.
- 17. THE CONTRACTOR SHALL OBTAIN ALL NECESSARY PERMITS TO ACCOMPLISH THIS WORK.
- 18. ALL QUESTIONS REGARDING THESE CONSTRUCTION DOCUMENTS SHALL BE SUBMITTED IN WRITING TO THE OWNER'S REPRESENTATIVE.

LEGEND

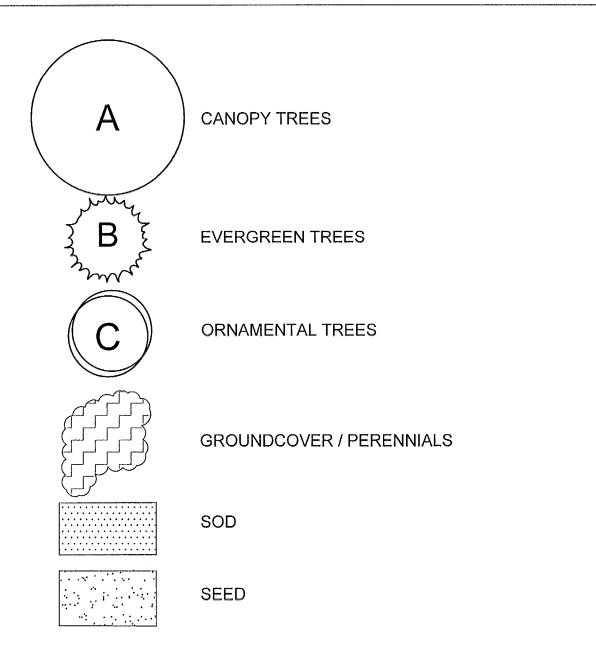

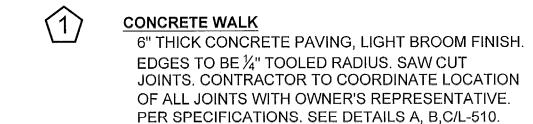

SPECIALTY PAVING PER ARCHITECTURAL. SEE SHEET A0.2.

NATURAL STONE STEPS REGIONAL LIMESTONE LEDGEROCK STEPS. SEE DETAIL C/L-512

PEDESTRIAN BRIDGE 20' STEEL BRIDGE STRUCTURE WITH ADA COMPLIANT STEEL GRATE DECKING AND STEEL GUARDRAIL. GUARDRAIL FEATURES WIRE PANEL INSERTS EQUAL TO OMEGA FENCING. FINISHES: STEEL: GALVANIZED AND SEALED, SEE DETAIL G/L-510.

AMPHITHEATER LANDING 5" COLOR CONDITIONED STAMPED CONCRETE PAVING (SCOFIELD CHROMIX ADMIXTURE C21 - ADOBE TAN AND ANTIQUING RELEASE AGENT WITH LITHOTEX STAMP FRACTURED EARTH/EMBOSSING SKIN OR EQUAL). ANTIQUING RELEASE AGENT TO BE DETERMINED COLOR TO COMPLEMENT NATIVE SOIL. INCORPORATE LEAF IMPRINTS/TWIGS WITH REGIONAL PLANT MATERIAL AND GRAVEL. COORDINATE WITH OWNER REPRESENTATIVE. SEE DETAIL A/L-400. SEE SHEET L-400.

AMPHITHEATER SEAT WALL SOLID LIMESTONE BLOCK SEAT WALL DIMENSIONALLY CUT TOP, BOTTOM AND SIDES. EXPOSED FACE, SPLIT. TOP, MEDIUM SANDBLAST. BEVEL ON ALL CUT EDGES. SIZE: 18"H x 24"D x 36"L. SEE DETAIL C&D/L-400. SEE SHEET L-400.

AMPHITHEATER STAIRS PRECAST CONCRETE STEPS. SPLIT FACE APPEARANCE. INTEGRALLY COLORED TO MATCH LIMESTONE WALLS. COLOR: OZARK BLEND. SEE DETAIL E/L-400.

SMALL CULVERT SEE CIVIL DRAWINGS FOR CULVERT DETAILS. PIPE TO BE DISGUISED WITH WEATHERED REGIONAL LIMESTONE LEDGE ROCK. SIZE VARIES: +/-18"H x 30"-36"D x 24"-60"L. SEE DETAIL B/L-512.

LANDSCAPE BOULDERS WEATHERED REGIONAL LIMESTONE BOULDERS AND LEDGE ROCKS WITH MOSS AND LICHEN. SIZE VARIES: 12"-36"H x 30"-36"D x 24"-60"L. SEE DETAIL D/L-510.

STACKED LIMESTONE BOULDERS WEATHERED REGIONAL LIMESTONE LEDGE ROCKS. STACKED TO HEIGHT AS INDICATED ON PLANS & DETAILS. LAYOUT PER PLANS. SIZE VARIES: +/-18"H x 30"-36"D x 24"-60"L. SEE DETAIL D/L-511.

LIMESTONE WEIR WEATHERED REGIONAL LIMESTONE BOULDERS, LAYOUT PER PLANS, SIZE VARIES: 12"-24"H x 12"-24"D x 24"-36"L. SEE DETAILS B,C/L-511.

BRIDGE ABUTMENTS VENEER WEATHERED REGIONAL LIMESTONE LEDGE ROCKS, SIZE VARIES: +/-18"H x 30"-36"D x 24"-60"L. SEE DETAIL G/L-510.

CIRCULAR PLANTER 7' DIAMETER PLANTER. SEE DETAIL F/L-510

RIVER COBBLE STREAM BED REGIONAL OZARK STREAM COBBLES WITH RANDOMLY PLACED LIMESTONE BOULDERS. COBBLE SIZE VARIES, MIXTURE TO BE BLENDED THOROUGHLY. SEE DETAIL E/L-510.

ROAD CULVERT SEE CIVIL DRAWINGS FOR CULVERT DETAILS. PIPE TO BE DISGUISED WITH WEATHERED REGIONAL LIMESTONE LEDGE ROCK. SIZE VARIES: +/-18"H x 30"-36"D x 24"-60"L. SEE DETAIL E/L-300 & D/L-511 & B/L-512.

NATURAL PATH DECOMPOSED LIMESTONE PATH. 5' WIDE.SEE DETAIL H/L-510.

NOT USED

FISHING ROCK LARGE LIMESTONE FLAT ROCK. TO BE FIELD SELECTED BY OWNER'S REPRESENTATIVE. SIZE: 18"-36"H x 6'-8"W x 6'-8"L.

BLUE STAR MEMORIAL POLE MOUNTED BRONZE MEMORIAL PLAQUE. OWNER FURNISHED CONTRACTOR INSTALLED. LAYOUT PER PLANS.

FLAG POLE

3 ALUMINUM FLAG POLES WITH UPLIGHTS. SEE SITE PLAN FOR HEIGHTS. FOOTINGS PER MANUFACTURER SPECIFICATIONS



EQUAL TO 6' ANOVA NEWCASTLE BACKLESS BENCH BLACK FINISH, SEAT AND ARMS. ANCHORED IN PLACE INSTALL PER MANUFACTURER SPECIFICATIONS

TRASH RECEPTACLE EQUAL TO ANOVA EXPOSITION 45 GAL TRASH RECEPTACLE. BLACK FINISH. ANCHORED IN PLACE. INCLUDE 30"X36" CONCRETE PAD. INSTALL PER MANUFACTURER SPECIFICATIONS.

BIRDHOUSE PURPLE MARTIN HOUSE. ALUMINUM CONSTRUCTION WITH AT LEAST 6 COMPARTMENTS. POLE HEIGHT 18' FOOTINGS PER MANUFACTURER SPECIFICATION. COLOR WHITE. LOCATIONS TO BE FIELD VERIFIED BY OWNER REPRESENTATIVE AND LANDSCAPE ARCHITECT. EQUAL TO TRENDSETTER 12.

BMP BRIDGE CROSSING 15' STEEL BRIDGE STRUCTURE WITH ADA COMPLIANT STEEL GRATE DECKING AND EDGE PROTECTION. FINISHES; STEEL: SEALED GALVANIZED. SEE DETAIL A/L-512.

> TO BE EQUAL TO 6' OMEGA "SECUR" DOUBLE WIRE FENCE OR APPROVED EQUAL. 3"X3" POST WITH SQUARE CAPS. COLOR: BLACK. PEDESTRIAN CROSSINGS TO BE GATED WITH EQUAL TO 6' OPENING OMEGA SECUR DOUBLE WIRE DOUBLE SWING GATE. LAYOUT PER PLANS PROVIDE SHOP DRAWINGS FOR APPROVAL. INSTALL PER MANUFACTURER SPECIFICATIONS.

DECORATIVE GRAVEL BAND BAND OF 1-2" DIAMETER DECORATIVE GRAVEL OF VARIOUS WIDTH AT BASE OF BUILDING RESTRAINED WITH ALUMINUM EDGE CONSTRAINT. GRAVEL TO BE REGIONAL RIVER GRAVEL. THICKNESS: 3" WITH FILTER FABRIC ON SUBGRADE.

DECORATIVE CONCRETE NODES 6" COLORED CONDITIONED STAMPED CONCRETE PAVING (SCOFIELD CHROMIX ADMIXTURE C21 - ADOBE TAN AND ANTIQUING RELEASE AGENT WITH LITHOTEX STAMP FRACTURED EARTH/EMBOSSING SKIN OR EQUAL). ANTIQUING RELEASE AGENT TO BE DETERMINED, COLOR TO COMPLEMENT NATIVE SOIL. INSTALL LIMESTONE BOULDERS AS SHOWN ON PLAN AND PER DETAIL D/L-510

PEDESTRIAN GATE 6' WIDE OMEGA "DOUBLE WIRE DOUBLE SWING GATE" FENCE OR APPROVED EQUAL. 3"X3" POST WITH SQUARE CAPS. COLOR: BLACK. PROVIDE SHOP DRAWINGS FOR APPROVAL. INSTALL PER MANUFACTURERS REQUREMENTS.

INTERPRETIVE SIGNAGE TO BE DETERMINED


VEHICULAR SWING GATE MANUAL SWING GATE WITH LOCKABLE CONNECTION AND TIE BACK POSTS. COLOR: BLACK POWDER COAT FINISH. INSTALL PER MANUFACTURER SPECIFICATIONS. SUBMIT SHOP DRAWINGS FOR OWNER REPRESENTATIVE APPROVAL. SEE DETAILS F/L-401 & D,E/L-512. TO BE EQUAL

TO BARRIER GATE ARM OPERATORS SWING GATE. **VEHICULAR GATE** 16' WIDE 6' TALL TO BE EQUAL TO OMEGA "SECUR DOUBLE WIRE" FENCE. 4"X4" POST WITH SQUARE CAPS. COLOR: BLACK. PROVIDE SHOP DRAWINGS FOR APPROVAL. INSTALL PER MANUFACTURERS REQUIREMENTS.

FISH SCULPTURE WEATHERED STEEL FISH SCULTURE. LAYOUT PER OWNER REPRESENTATIVE IN FIELD. SEE SHEETS L-401 & L-513.

> **BIRDHOUSE** POLY LUMBER BLUEBIRD HOUSE. TO BE POLE MOUNTED AT A HEIGHT OF 6'. POLE TO BE ALUMINUM WITH FOOTINGS PER MANUFACTURER SPECIFICATIONS. FINAL LOCATIONS TO BE FIELD VERIFIED BY OWNER REPRESENTATIVE AND LANDSCAPE ARCHITECT. TO BE EQUAL TO DUNCRAFT BIRD-SAFE BLUEBIRD HOUSE.

SWT

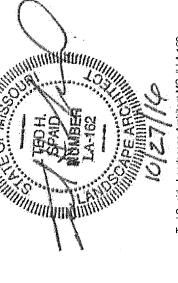

SO

TBD ssued: Revised: AS NOTED CS Drawn: Checked: KDR 14023


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Plotted On: 10/27/2016

Call Before you DIG

1-800-344-7483

MISSOURI ONE-CALL SYSTEM INC.

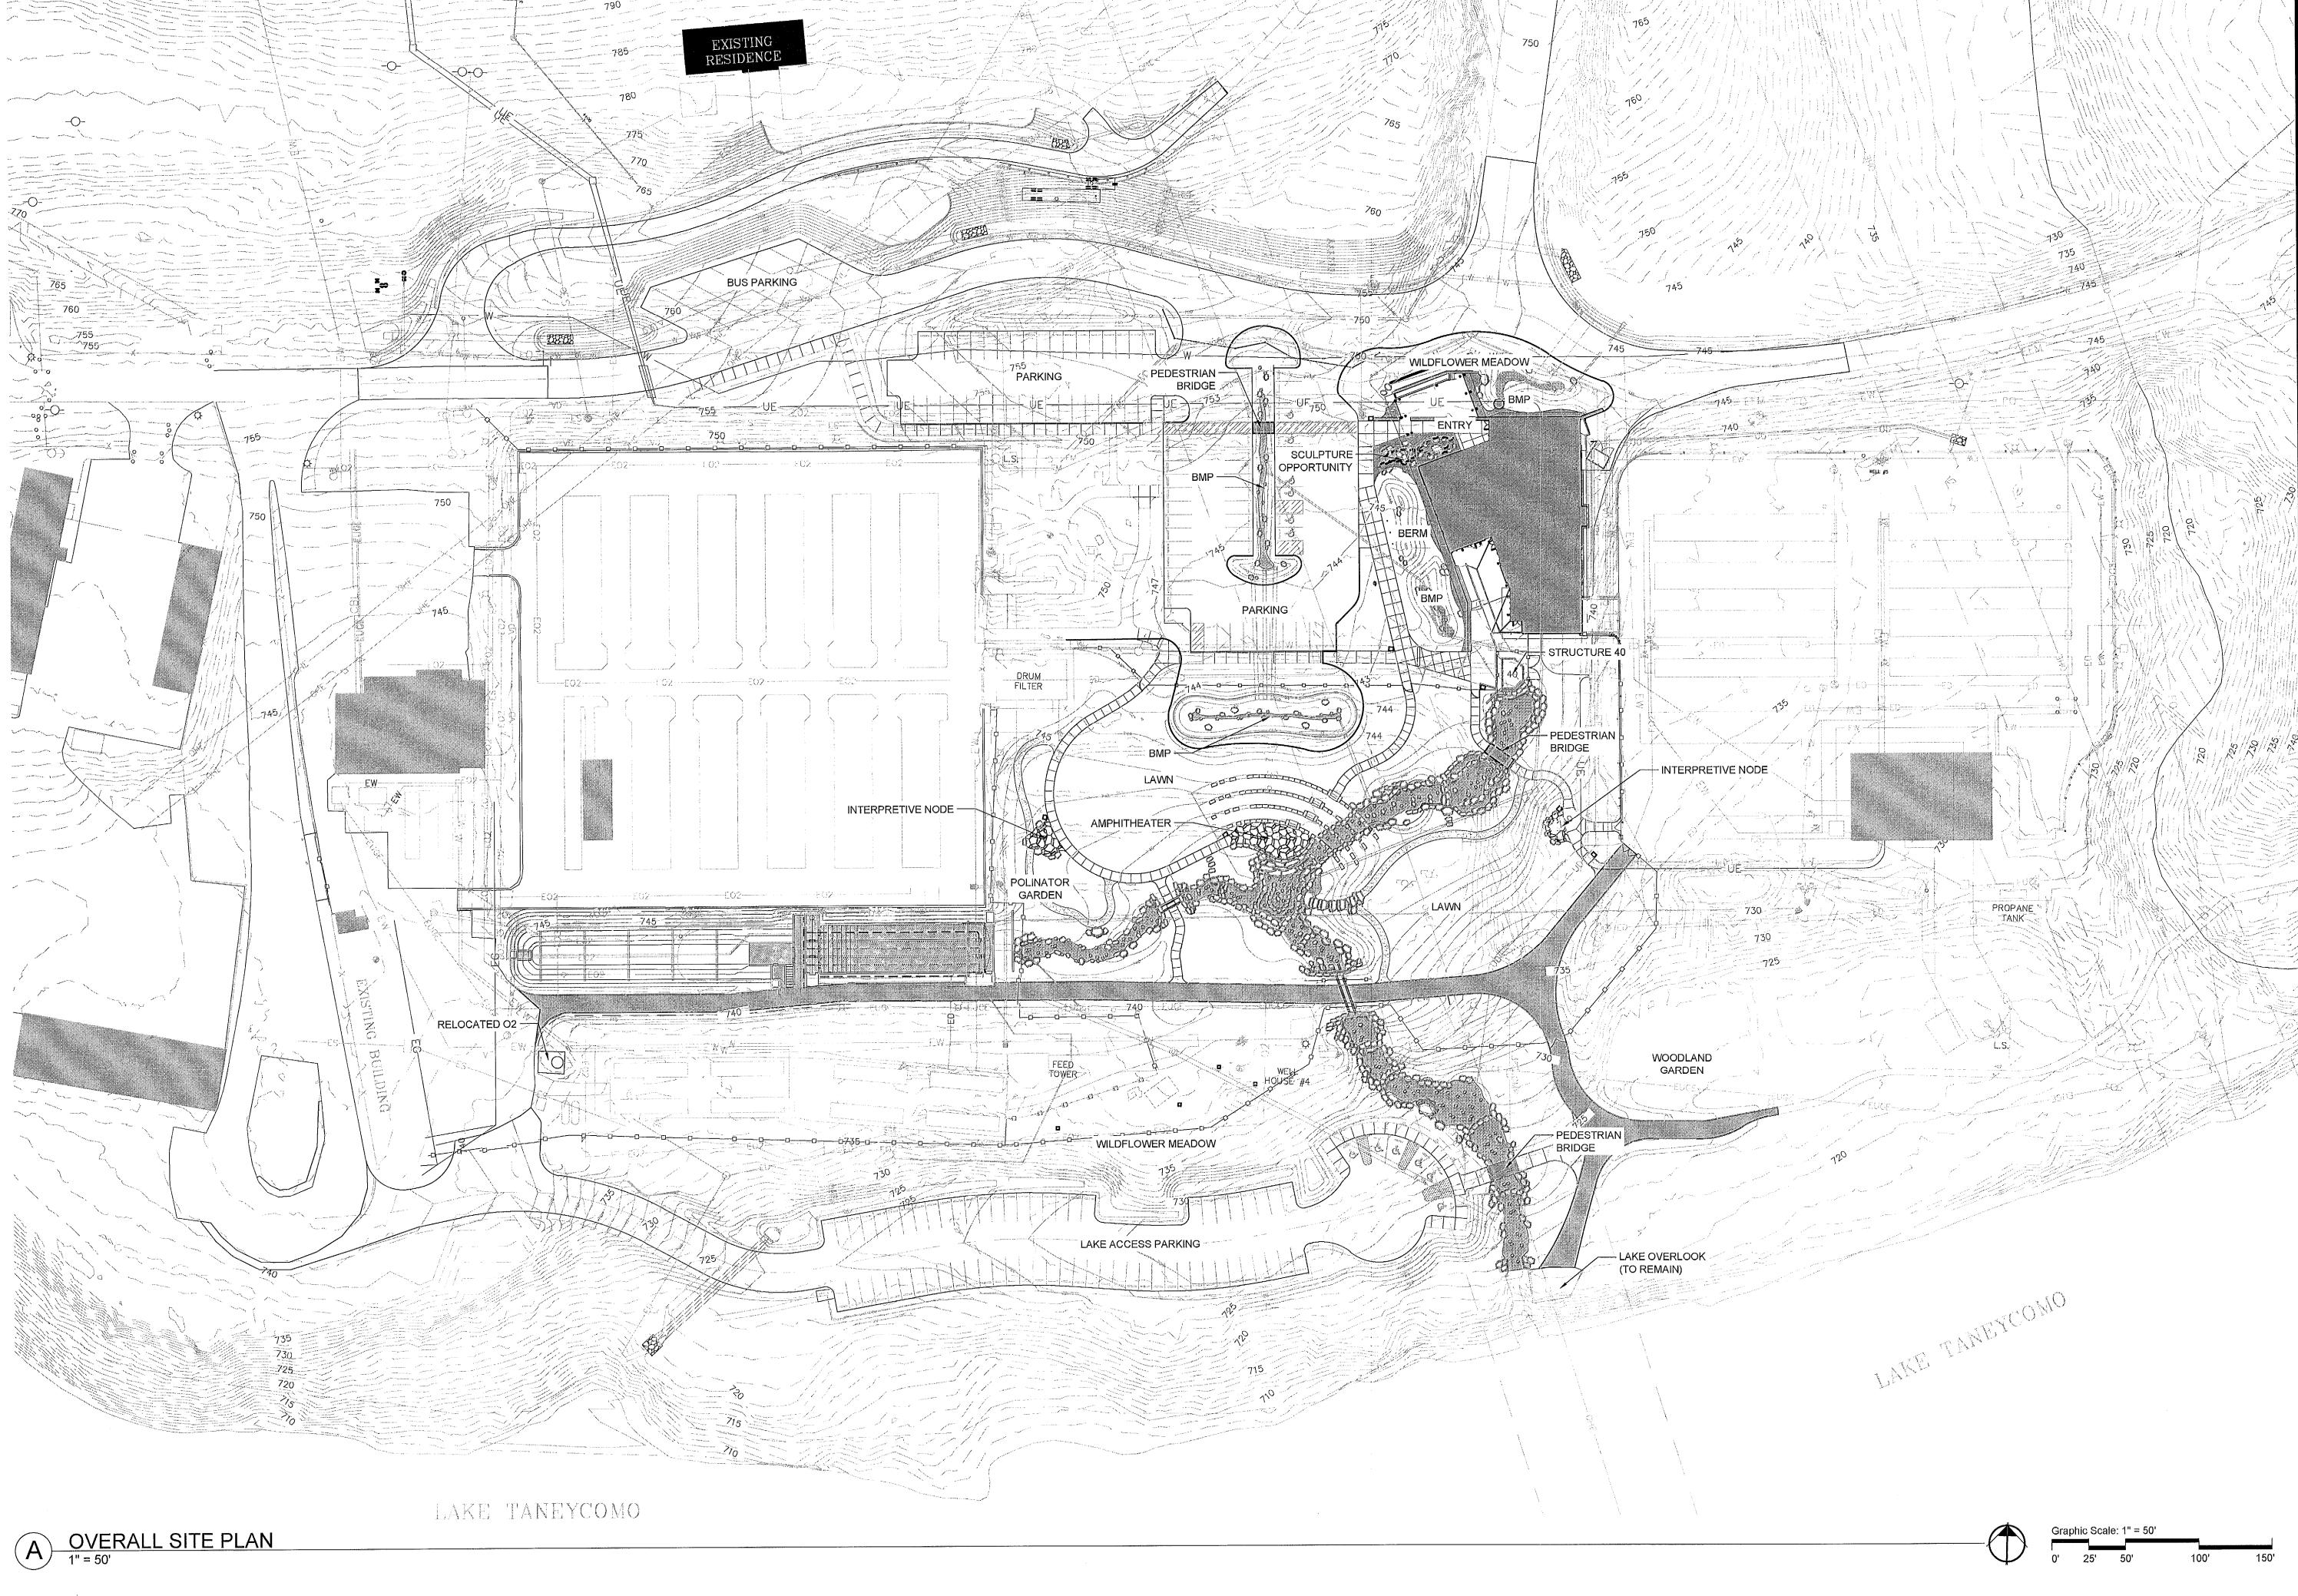

NOTIFY OWNER IMMEDIATELY IN EVENTS OF DISCREPANCIES, OMISSIONS, AND/OR CONFLICTS IN THE DRAWINGS OR SPECIFICATIONS. THE CONTRACTOR IS NOT AUTHORIZED TO SCALE THE DRAWINGS. ALL

QUESTIONS IN REFERENCE TO CONTRACT DOCUMENTS SHALL BE IMMEDIATELY DIRECTED TO THE OWNER.


Checked: KDR

AS NOTED

SHEPHERD
CONSERVA
MISSOURI DE
Hatchery Road
Branson, MO 6

1-800-344-7483 MISSOURI ONE-CALL SYSTEM INC. NOTIFY OWNER IMMEDIATELY IN EVENTS OF DISCREPANCIES, OMISSIONS, AND/OR CONFLICTS IN THE DRAWINGS OR SPECIFICATIONS. THE CONTRACTOR IS NOT AUTHORIZED TO SCALE THE DRAWINGS. ALL QUESTIONS IN REFERENCE TO CONTRACT DOCUMENTS SHALL BE IMMEDIATELY DIRECTED TO THE OWNER.

Drawn: CS Checked: KDR 14023

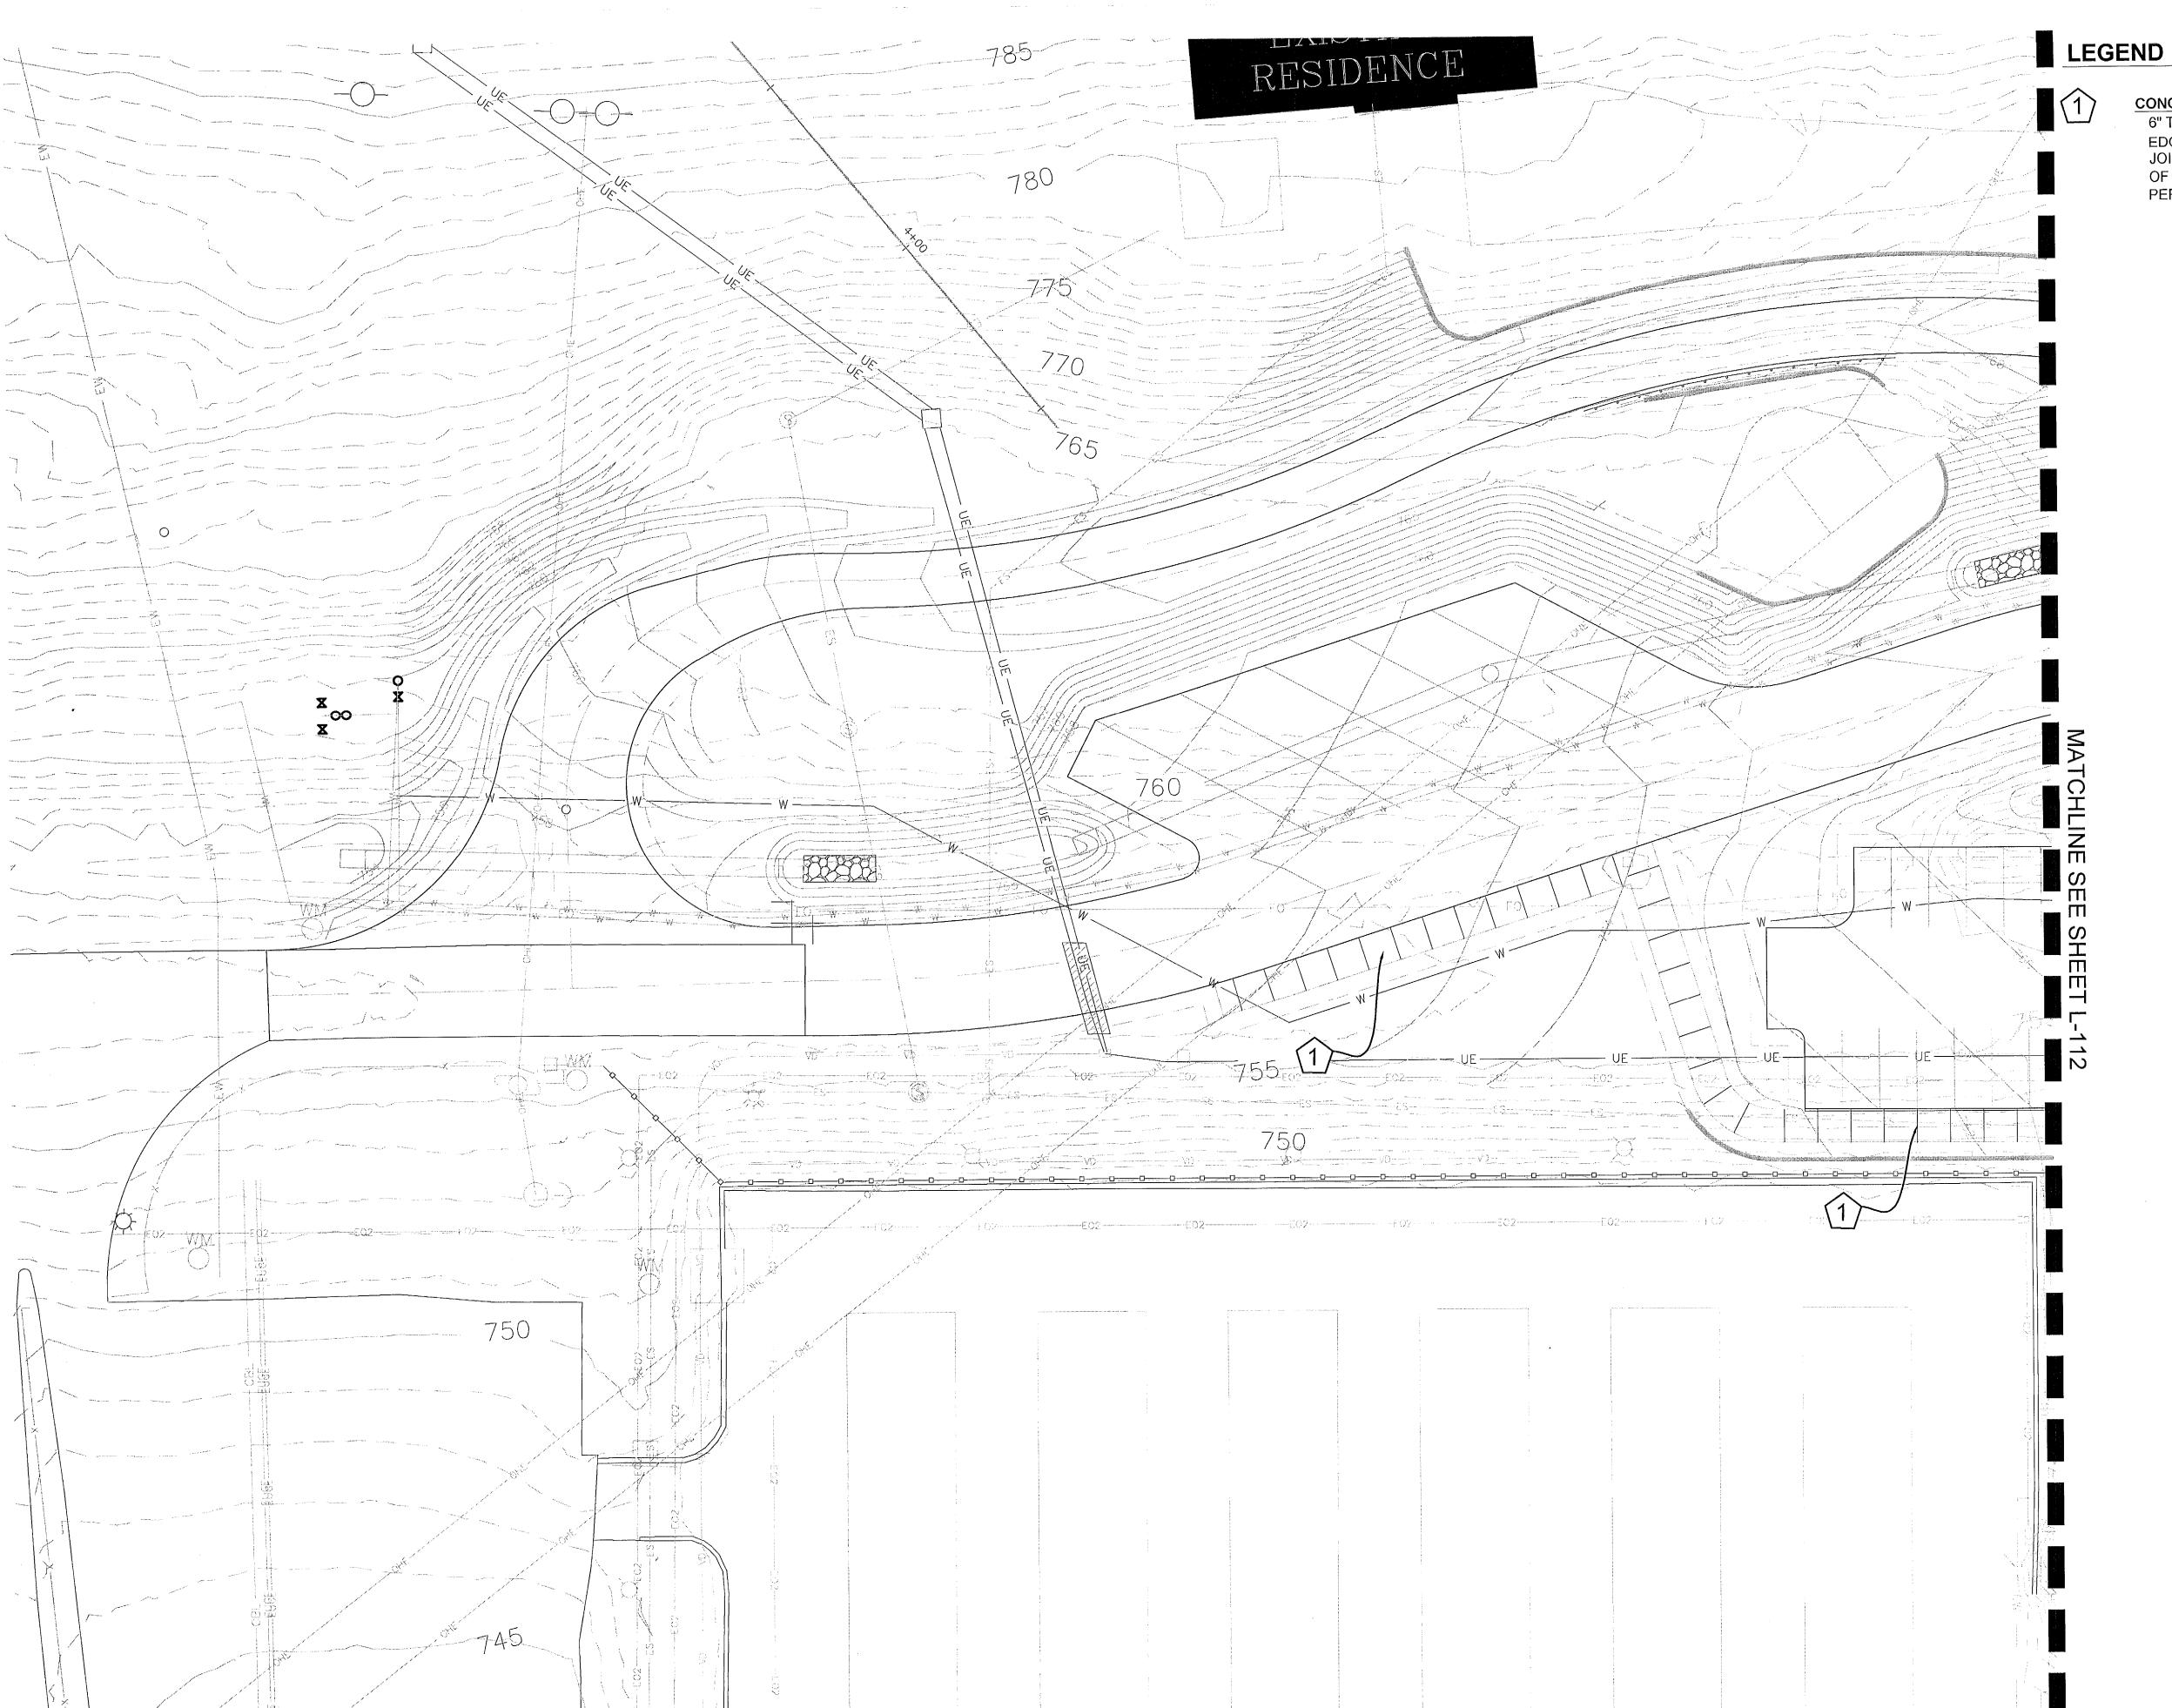

CONCRETE WALK
6" THICK CONCRETE PAVING, LIGHT BROOM FINISH. EDGES TO BE ¼" TOOLED RADIUS. SAW CUT JOINTS. CONTRACTOR TO COORDINATE LOCATION OF ALL JOINTS WITH OWNER'S REPRESENTATIVE. PER SPECIFICATIONS. SEE DETAILS A, B,C/L-510.

DAKE 19 archite

SHEPHERD CONSERVAT

AS NOTED CS Checked: KDR 14023

Plotted On: 10/27/2016

NOTIFY OWNER IMMEDIATELY IN EVENTS OF DISCREPANCIES, OMISSIONS, AND/OR CONFLICTS IN THE DRAWINGS OR SPECIFICATIONS. THE CONTRACTOR IS NOT AUTHORIZED TO SCALE THE DRAWINGS. ALL QUESTIONS IN REFERENCE TO CONTRACT DOCUMENTS SHALL BE IMMEDIATELY DIRECTED TO THE OWNER.

CONCRETE WALK

DETAIL D/L-510.

6" THICK CONCRETE PAVING, LIGHT BROOM FINISH. EDGES TO BE 1/4" TOOLED RADIUS. SAW CUT JOINTS. CONTRACTOR TO COORDINATE LOCATION OF ALL JOINTS WITH OWNER'S REPRESENTATIVE. PER SPECIFICATIONS. SEE DETAILS A, B,C/L-510. REFERENCE ARCHITECTURAL. SEE SHEET A0.2.

SPECIALTY PAVING PER ARCHITECTURAL. SEE SHEET A0.2.

LANDSCAPE BOULDERS WEATHERED REGIONAL LIMESTONE BOULDERS AND LEDGE ROCKS WITH MOSS AND LICHEN. SIZE VARIES: 12"-36"H x 30"-36"D x 24"-60"L. SEE

CIRCULAR PLANTER

7' DIAMETER PLANTER. SEE DETAIL F/L-510

RIVER COBBLE STREAM BED REGIONAL OZARK STREAM COBBLES WITH RANDOMLY PLACED LIMESTONE BOULDERS. COBBLE SIZE VARIES, MIXTURE TO BE BLENDED THOROUGHLY. SEE DETAIL E/L-510.

BLUE STAR MEMORIAL POLE MOUNTED BRONZE MEMORIAL PLAQUE. OWNER FURNISHED CONTRACTOR INSTALLED. LAYOUT PER PLANS.

FLAG POLE 3 ALUMINUM FLAG POLES WITH UPLIGHTS. SEE SITE PLAN FOR HEIGHTS. FOOTINGS PER MANUFACTURER SPECIFICATIONS

TRASH RECEPTACLE EQUAL TO ANOVA EXPOSITION 45 GAL TRASH RECEPTACLE. BLACK FINISH. ANCHORED IN PLACE. INCLUDE 30"X36" CONCRETE PAD. INSTALL PER MANUFACTURER SPECIFICATIONS.

BMP BRIDGE CROSSING 15' STEEL BRIDGE STRUCTURE WITH ADA COMPLIANT STEEL GRATE DECKING AND EDGE PROTECTION. FINISHES; STEEL: SEALED GALVANIZED. SEE DETAIL A/L-512.

DECORATIVE GRAVEL BAND BAND OF 1-2" DIAMETER DECORATIVE GRAVEL OF VARIOUS WIDTH AT BASE OF BUILDING RESTRAINED WITH ALUMINUM EDGE CONSTRAINT. GRAVEL TO BE REGIONAL RIVER

GRAVEL. THICKNESS: 3" WITH FILTER FABRIC ON SUBGRADE. VEHICULAR SWING GATE MANUAL SWING GATE WITH LOCKABLE CONNECTION AND TIE BACK POSTS. COLOR: BLACK POWDER COAT FINISH.


INSTALL PER MANUFACTURER SPECIFICATIONS. SUBMIT SHOP DRAWINGS FOR OWNER REPRESENTATIVE APPROVAL. SEE DETAILS F/L-401 & D,E/L-512. TO BE EQUAL TO BARRIER GATE ARM OPERATORS SWING GATE.

AS NOTED Drawn: Checked: 14023

NOTIFY OWNER IMMEDIATELY IN EVENTS OF DISCREPANCIES, OMISSIONS, AND/OR CONFLICTS IN THE DRAWINGS OR SPECIFICATIONS. THE CONTRACTOR IS NOT AUTHORIZED TO SCALE THE DRAWINGS, ALL QUESTIONS IN REFERENCE TO CONTRACT DOCUMENTS SHALL BE IMMEDIATELY DIRECTED TO THE OWNER.

Call Before you DIG TOLL FREE 1-800-344-7483 MISSOURI ONE-CALL SYSTEM INC.

MATCHLINE SEE SHEET L-114

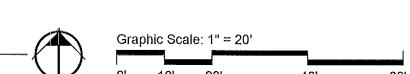

LEGEND

CONCRETE WALK

6" THICK CONCRETE PAVING, LIGHT BROOM FINISH. EDGES TO BE 1/4" TOOLED RADIUS. SAW CUT JOINTS. CONTRACTOR TO COORDINATE LOCATION OF ALL JOINTS WITH OWNER'S REPRESENTATIVE. PER SPECIFICATIONS. SEE DETAILS A, B,C/L-510.

SPECIALTY PAVING

PER ARCHITECTURAL. SEE SHEET A0.2.

NATURAL STONE STEPS

REGIONAL LIMESTONE LEDGEROCK STEPS. SEE DETAIL C/L-512

PEDESTRIAN BRIDGE

20' STEEL BRIDGE STRUCTURE WITH ADA COMPLIANT STEEL GRATE DECKING AND STEEL GUARDRAIL. GUARDRAIL FEATURES WIRE PANEL INSERTS EQUAL TO OMEGA FENCING. FINISHES: STEEL: GALVANIZED AND SEALED. SEE DETAIL G/L-510.

AMPHITHEATER SEAT WALL

SOLID LIMESTONE BLOCK SEAT WALL. DIMENSIONALLY CUT TOP, BOTTOM AND SIDES. EXPOSED FACE, SPLIT. TOP, MEDIUM SANDBLAST. BEVEL ON ALL CUT EDGES. SIZE: 18"H x 24"D x 36"L. SEE DETAIL C&D/L-400.

SMALL CULVERT

SEE CIVIL DRAWINGS FOR CULVERT DETAILS. PIPE TO BE DISGUISED WITH WEATHERED REGIONAL LIMESTONE LEDGE ROCK. SIZE VARIES: +/-18"H x 30"-36"D x 24"-60"L. SEE DETAIL B/L-512.

LANDSCAPE BOULDERS

WEATHERED REGIONAL LIMESTONE BOULDERS AND LEDGE ROCKS WITH MOSS AND LICHEN. SIZE VARIES: 12"-36"H x 30"-36"D x 24"-60"L. SEE DETAIL D/L-510.

STACKED LIMESTONE BOULDERS

WEATHERED REGIONAL LIMESTONE LEDGE ROCKS. STACKED TO HEIGHT AS INDICATED ON PLANS & DETAILS. LAYOUT PER PLANS. SIZE VARIES: +/-18"H x 30"-36"D x 24"-60"L. SEE DETAIL D/L-511.

LIMESTONE WEIR

WEATHERED REGIONAL LIMESTONE **BOULDERS. LAYOUT PER PLANS. SIZE VARIES:** 12"-24"H x 12"-24"D x 24"-36"L. SEE DETAILS B,C/L-511.

RIVER COBBLE STREAM BED REGIONAL OZARK STREAM COBBLES WITH RANDOMLY PLACED LIMESTONE BOULDERS. COBBLE SIZE VARIES, MIXTURE TO BE BLENDED THOROUGHLY. SEE DETAIL E/L-510.

ROAD CULVERT SEE CIVIL DRAWINGS FOR CULVERT DETAILS. PIPE TO BE DISGUISED WITH WEATHERED REGIONAL LIMESTONE LEDGE ROCK. SIZE VARIES: +/-18"H x 30"-36"D x 24"-60"L. SEE DETAIL E/L-300 & D/L-511 & B/L-512.

NATURAL PATH

DECOMPOSED LIMESTONE PATH. 5' WIDE.SEE DETAIL H/L-510.

FISHING ROCK

LARGE LIMESTONE FLAT ROCK. TO BE FIELD SELECTED BY OWNER'S REPRESENTATIVE. SIZE: 18"-36"H x 6'-8'W x 6'-8'L.

TRASH RECEPTACLE

EQUAL TO ANOVA EXPOSITION 45 GAL TRASH RECEPTACLE. BLACK FINISH. ANCHORED IN PLACE. INCLUDE 30"X36" CONCRETE PAD. INSTALL PER MANUFACTURER SPECIFICATIONS.

6' FENCE


TO BE EQUAL TO 6' OMEGA "SECUR" DOUBLE WIRE FEN(OR APPROVED EQUAL. 3"X3" POST WITH SQUARE CAPS. COLOR: BLACK. PEDESTRIAN CROSSINGS TO BE GATED WITH EQUAL TO 6' OPENING OMEGA SECUR DOUBLE WIF DOUBLE SWING GATE. LAYOUT PER PLANS PROVIDE SHOP DRAWINGS FOR APPROVAL. INSTALL PER MANUFACTURER SPECIFICATIONS.

PEDESTRIAN GATE

6' WIDE OMEGA "DOUBLE WIRE DOUBLE SWING GATE" FENCE OR APPROVED EQUAL. 3"X3" POST WITH SQUARE CAPS. COLOR: BLACK. PROVIDE SHOP DRAWINGS FOR APPROVAL. INSTALL PER MANUFACTURERS REQUREMENTS

VEHICULAR GATE

16' WIDE 6' TALL TO BE EQUAL TO OMEGA "SECUR DOUBLE WIRE" FENCE. 4"X4" POST WITH SQUARE CAPS. COLOR: BLACK. PROVIDE SHOP DRAWINGS FOR APPROVAL. INSTALL PER MANUFACTURERS REQUIREMENTS.

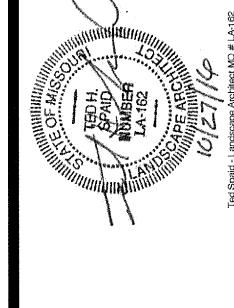

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LEGEND

CONCRETE WALK

6" THICK CONCRETE PAVING, LIGHT BROOM FINISH. EDGES TO BE 1/4" TOOLED RADIUS. SAW CUT JOINTS. CONTRACTOR TO COORDINATE LOCATION OF ALL JOINTS WITH OWNER'S REPRESENTATIVE. PER SPECIFICATIONS. SEE DETAILS A, B,C/L-510.

PEDESTRIAN BRIDGE

20' STEEL BRIDGE STRUCTURE WITH ADA COMPLIANT STEEL GRATE DECKING AND STEEL GUARDRAIL. GUARDRAIL FEATURES WIRE PANEL INSERTS EQUAL TO OMEGA FENCING, FINISHES: STEEL: GALVANIZED AND SEALED. SEE DETAIL G/L-510.

LANDSCAPE BOULDERS

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RIVER COBBLE STREAM BED

REGIONAL OZARK STREAM COBBLES WITH RANDOMLY PLACED LIMESTONE BOULDERS. COBBLE SIZE VARIES, MIXTURE TO BE BLENDED THOROUGHLY. SEE DETAIL E/L-510.

ROAD CULVERT

SEE CIVIL DRAWINGS FOR CULVERT DETAILS. PIPE TO BE DISGUISED WITH WEATHERED REGIONAL LIMESTONE LEDGE ROCK. SIZE VARIES: +/-18"H x 30"-36"D x 24"-60"L. SEE DETAIL E/L-300 & D/L-511 & B/L-512.

BIRDHOUSE

PURPLE MARTIN HOUSE. ALUMINUM CONSTRUCTION WITH A LEAST 6 COMPARTMENTS. POLE HEIGHT 18' FOOTINGS PER MANUFACTURER SPECIFICATION. COLOR WHITE. LOCATIONS TO BE FIELD VERIFIED BY OWNER REPRESENTATIVE AND LANDSCAPE ARCHITECT. EQUAL TO TRENDSETTER 12.

TO BE EQUAL TO 6' OMEGA "SECUR" DOUBLE WIRE FENCE OR APPROVED EQUAL. 3"X3" POST WITH SQUARE CAPS. COLOR: BLACK. PEDESTRIAN CROSSINGS TO BE GATED WITH EQUAL TO 6' OPENING OMEGA SECUR DOUBLE WIRE DOUBLE SWING GATE. LAYOUT PER PLANS PROVIDE SHOP DRAWINGS FOR APPROVAL. INSTALL PER MANUFACTURER SPECIFICATIONS.

VEHICULAR GATE

16' WIDE 6' TALL TO BE EQUAL TO OMEGA "SECUR DOUBLE WIRE" FENCE. 4"X4" POST WITH SQUARE CAPS. COLOR: BLACK. PROVIDE SHOP DRAWINGS FOR APPROVAL. INSTALL PER MANUFACTURERS REQUIREMENTS.

POLY LUMBER BLUEBIRD HOUSE. TO BE POLE MOUNTED AT A HEIGHT OF 6'. POLE TO BE ALUMINUM WITH FOOTINGS PER MANUFACTURER SPECIFICATIONS. FINAL LOCATIONS TO BE FIELD VERIFIED BY OWNER REPRESENTATIVE AND LANDSCAPE ARCHITECT. TO BE EQUAL TO DUNCRAFT BIRD-SAFE BLUEBIRD HOUSE.

WELLS e c t u r e


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A LAYOUT PLAN
1" = 20'

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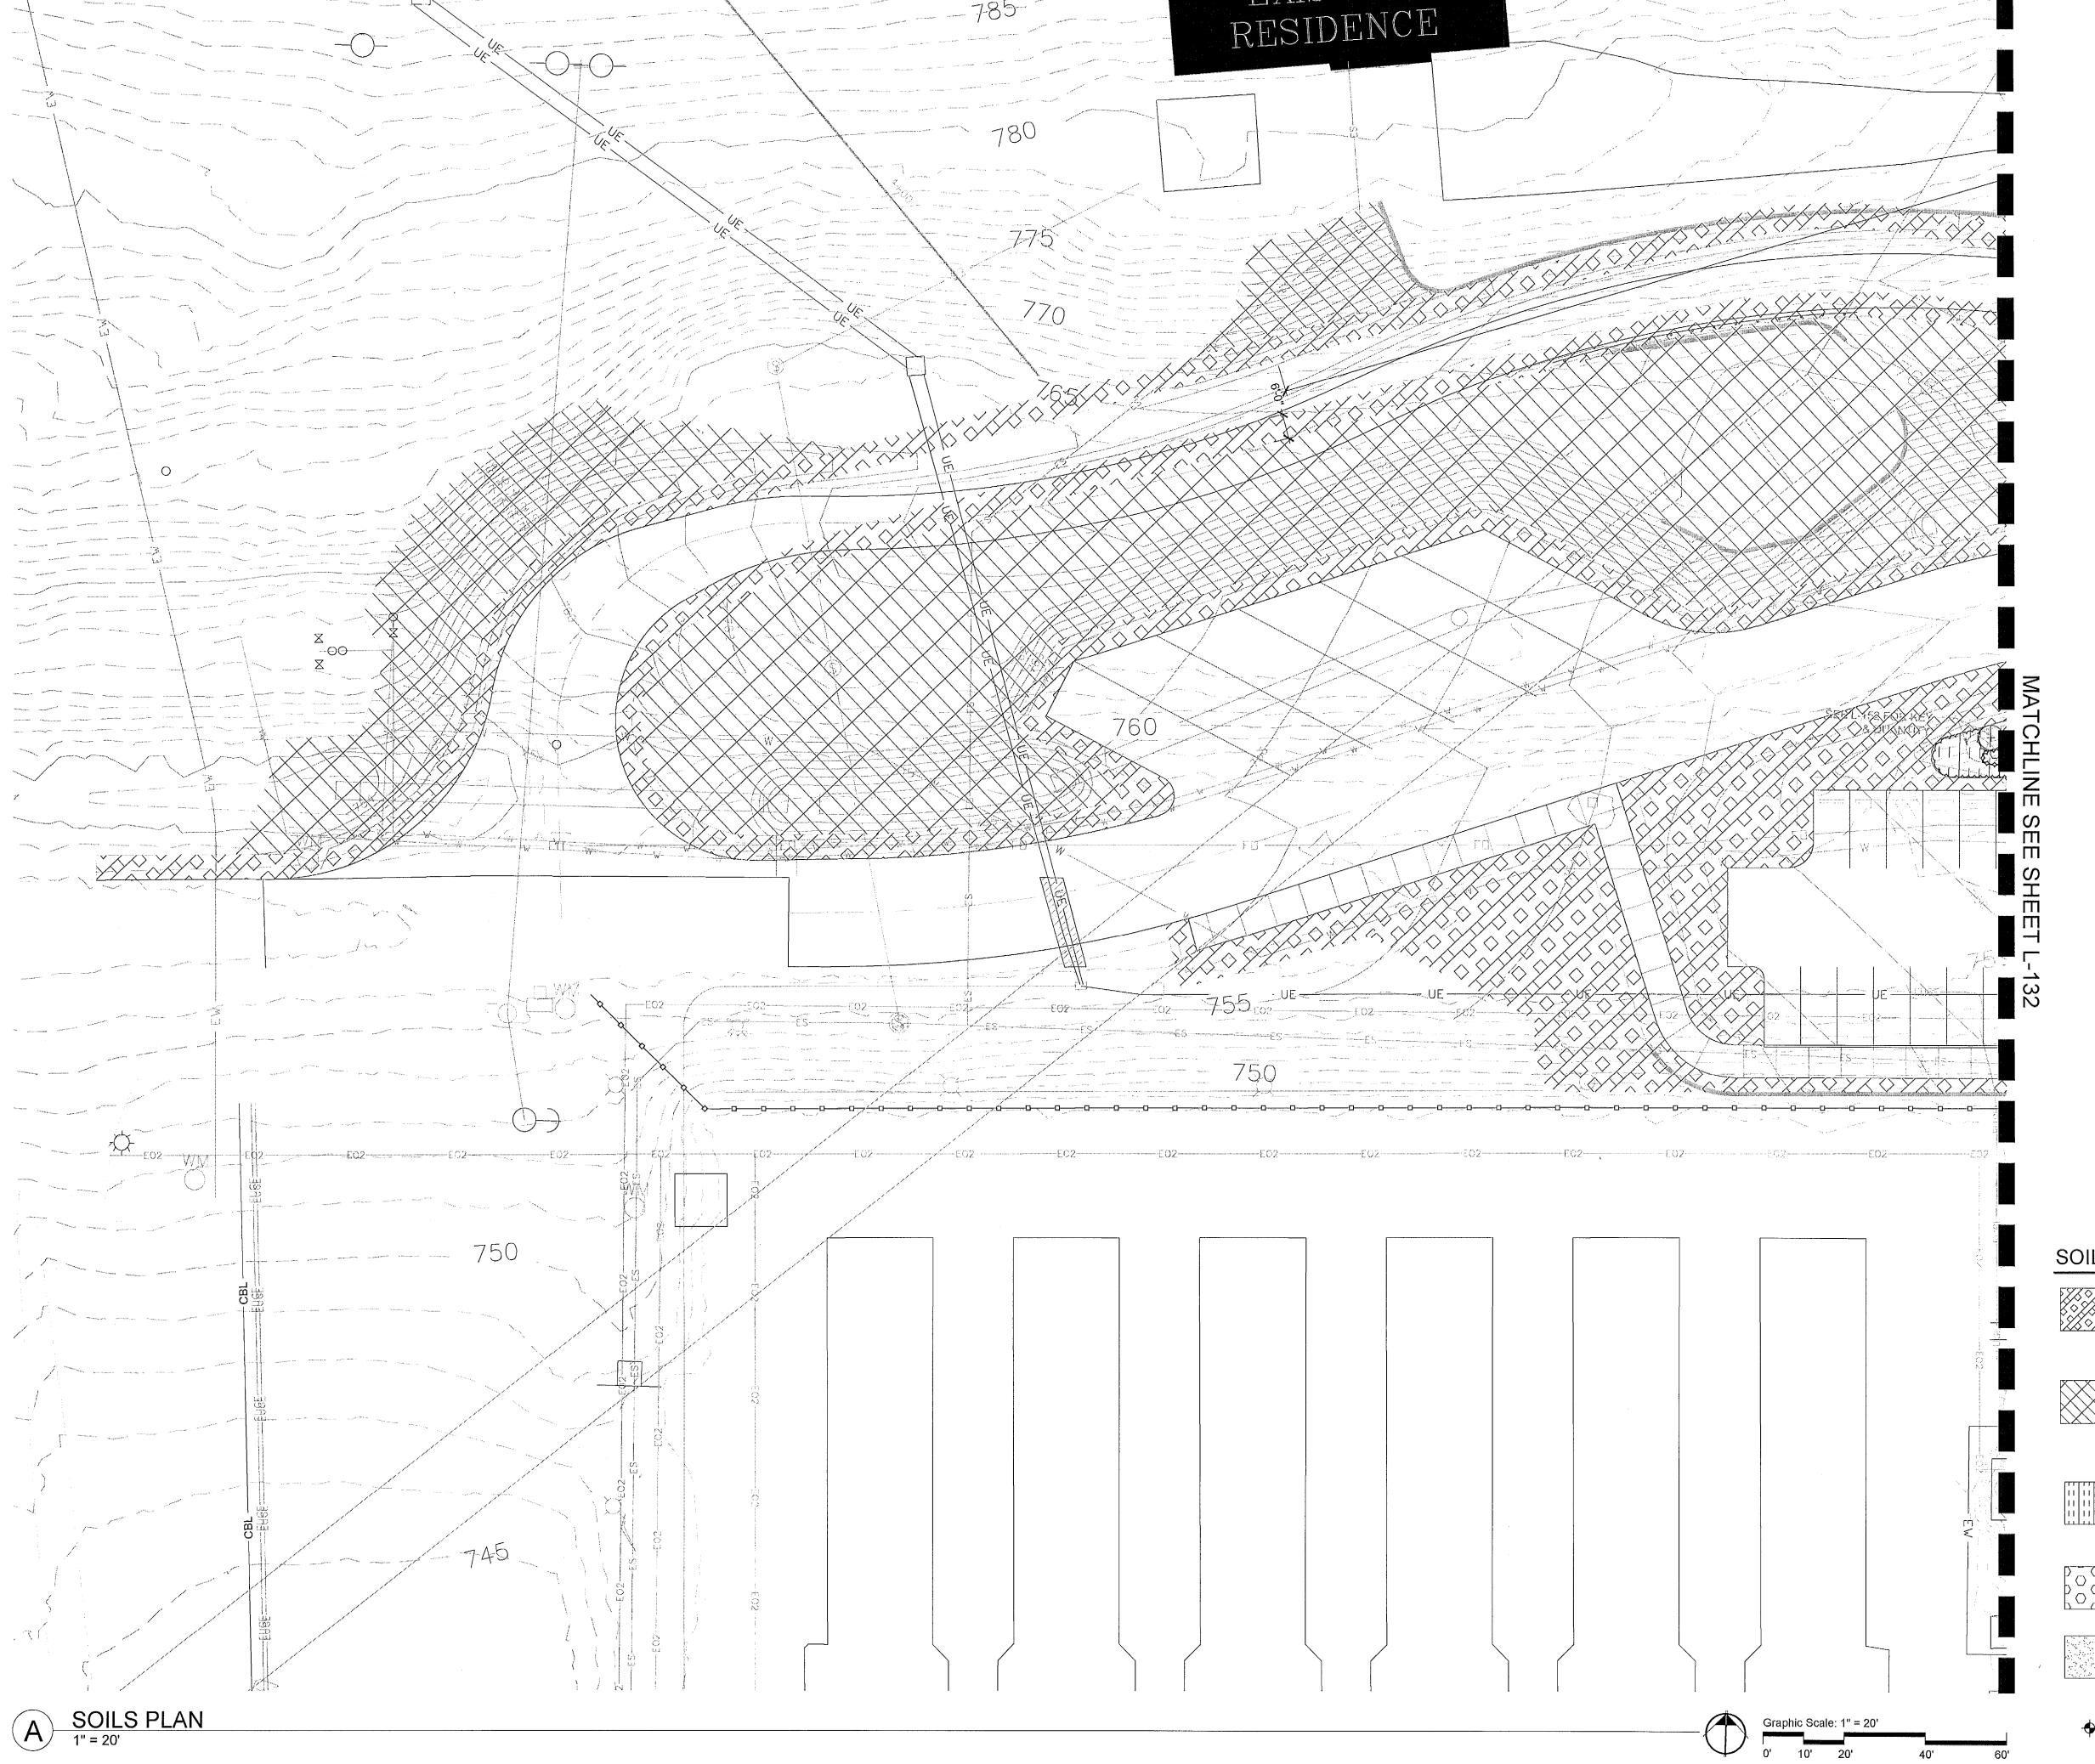
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SOILS LEGEND



TURF SOIL
6" DEPTH TOP SOIL PRODUCED FROM ON SITE
SOILS AND AMENDED OR IMPORTED TOP SOIL
AMENDED PER SPECIFICATIONS.

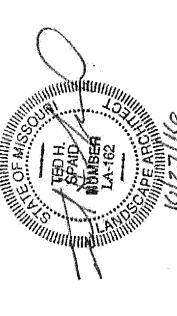

NATIVE SEED & MEADOW SOIL
6" DEPTH TOP SOIL PRODUCED FROM ON SITE
SOILS AND AMENDED PER SPECIFICATIONS.



PERENNIAL SOIL

12" DEPTH TOP SOIL PRODUCED FROM ON SITE
SOILS OR IMPORTED SOILS AND AMENDED PER
SPECIFICATIONS.

BMP SOIL
IMPORTED BMP SOIL MIX PER DETAILS AND
SPECIFICATIONS DEPTH VARIES SEE PLAN AND
DETAILS.



RAIN GARDEN MINERAL MULCH


2" DEPTH, %" CLEAN, MISSOURI CRUSHED GRANITE
(BLACK). PROVIDE SAMPLE FOR LANDSCAPE
ARCHITECT'S APPROVAL.



SOIL SAMPLE LOCATION

NOTIFY OWNER IMMEDIATELY IN EVENTS OF DISCREPANCIES, OMISSIONS, AND/OR CONFLICTS IN THE DRAWINGS OR SPECIFICATIONS. THE

CONTRACTOR IS NOT AUTHORIZED TO SCALE THE DRAWINGS. ALL QUESTIONS IN REFERENCE TO CONTRACT DOCUMENTS SHALL BE IMMEDIATELY DIRECTED TO THE OWNER.

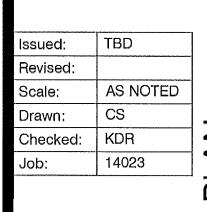

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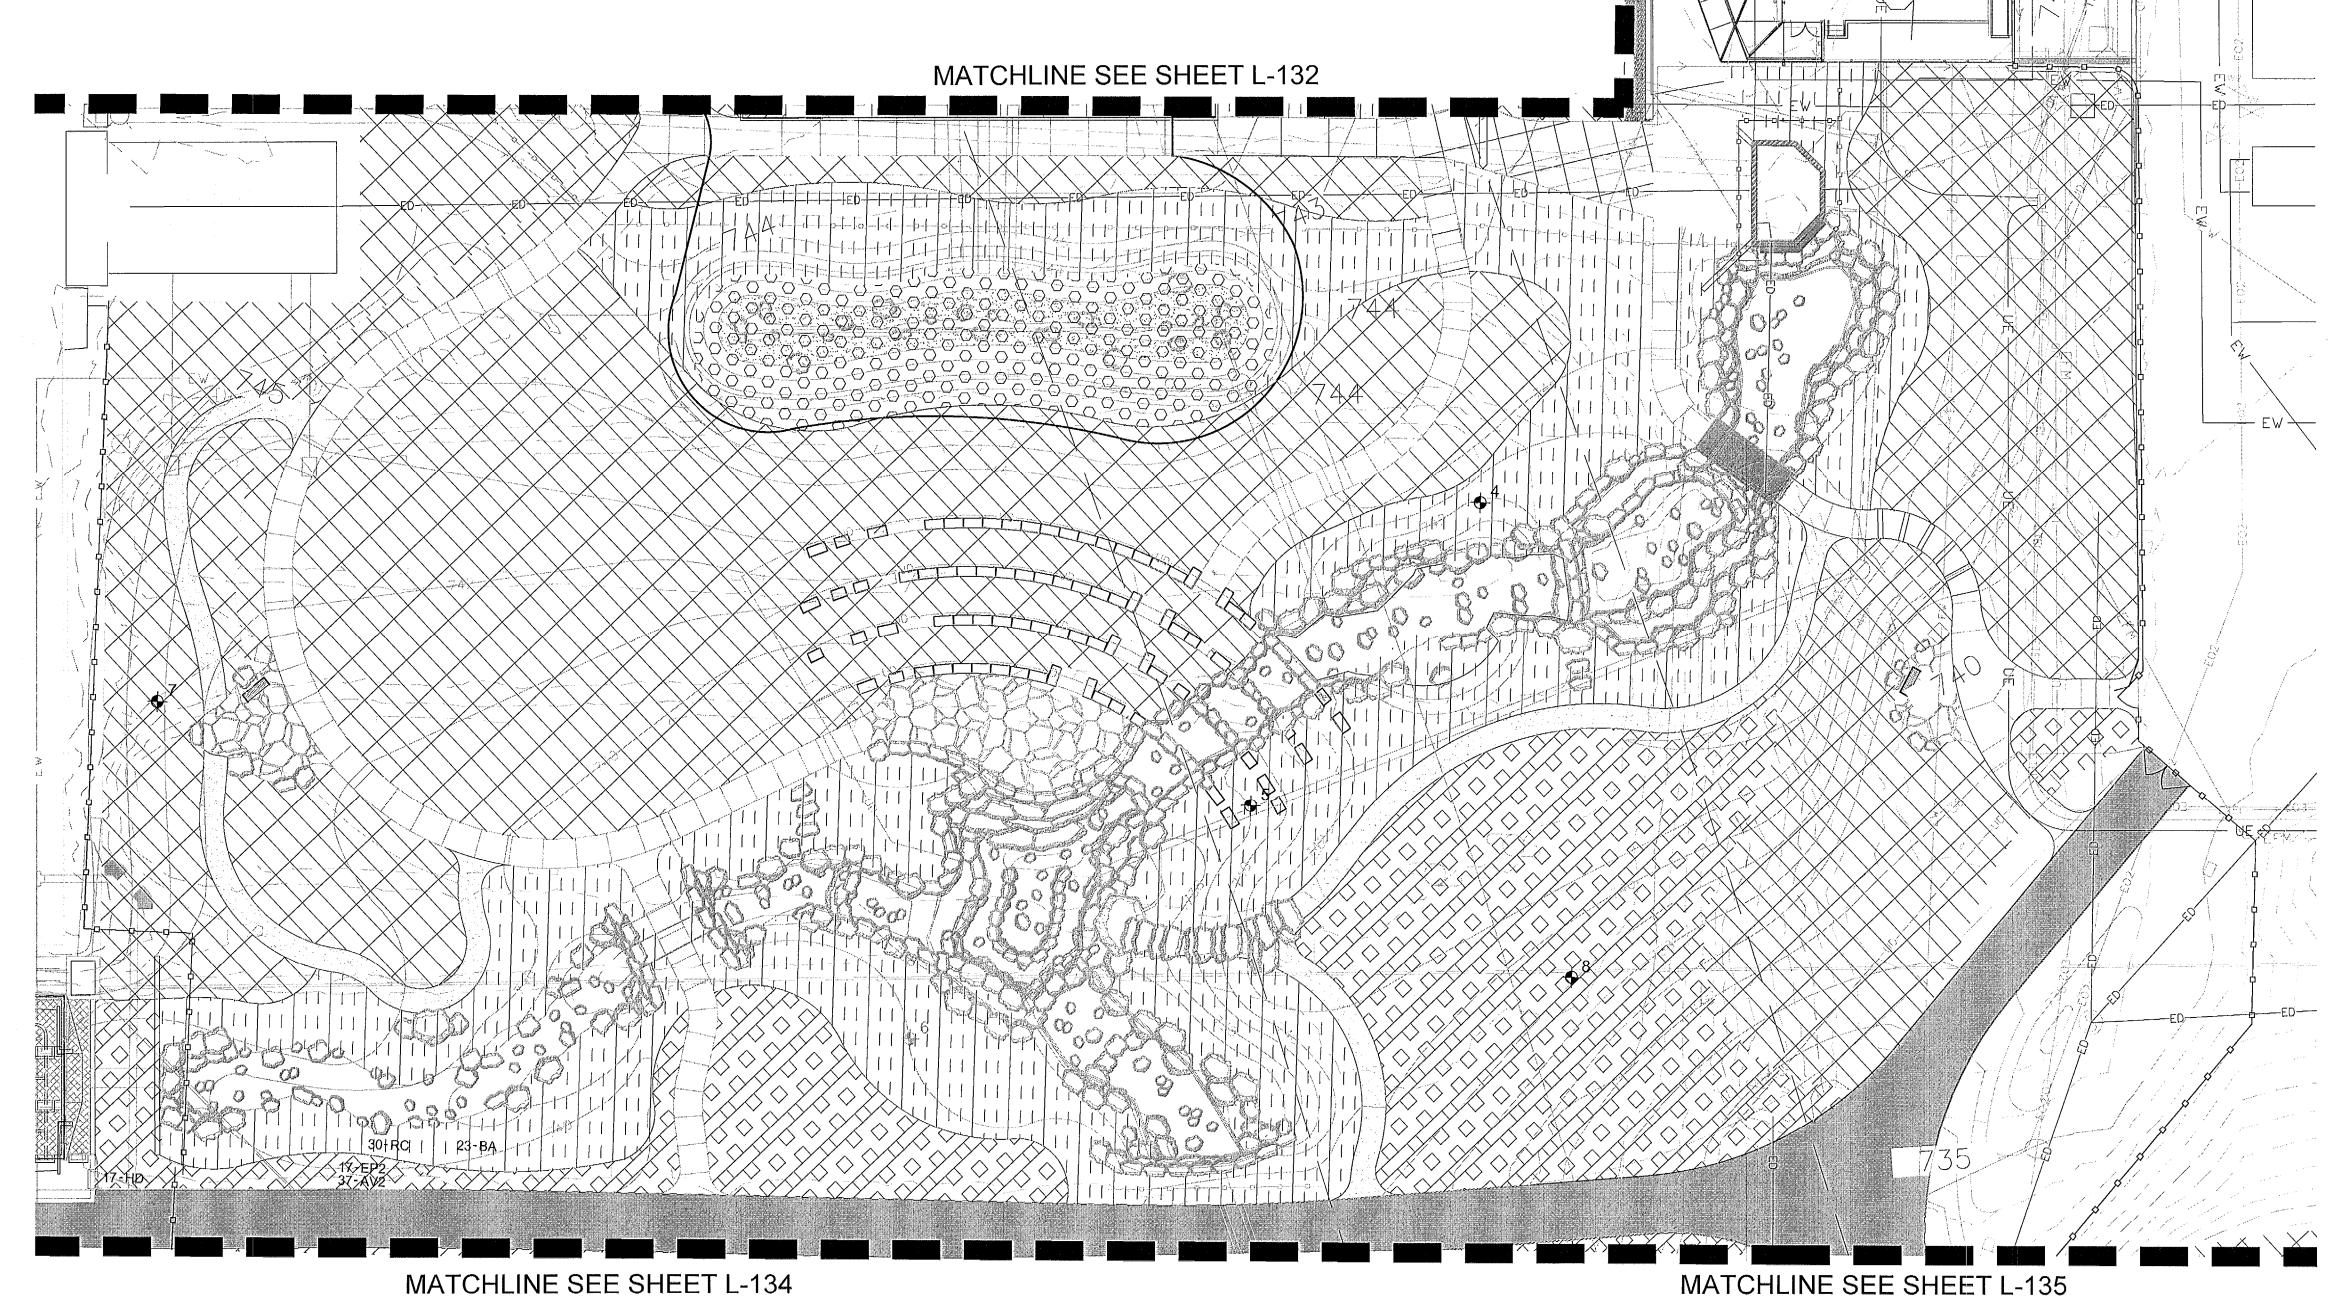
1-800-344-7483 MISSOURI ONE-CALL SYSTEM INC.

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SOILS LEGEND



TURF SOIL
6" DEPTH TOP SOIL PRODUCED FROM ON SITE
SOILS AND AMENDED OR IMPORTED TOP SOIL
AMENDED PER SPECIFICATIONS.



NATIVE SEED & MEADOW SOIL
6" DEPTH TOP SOIL PRODUCED FROM ON SITE
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12" DEPTH TOP SOIL PRODUCED FROM ON SITE
SOILS OR IMPORTED SOILS AND AMENDED PER
SPECIFICATIONS.



BMP SOIL
IMPORTED BMP SOIL MIX PER DETAILS AND
SPECIFICATIONS DEPTH VARIES SEE PLAN AND
DETAILS.



RAIN GARDEN MINERAL MULCH 2" DEPTH, $\frac{3}{8}$ " CLEAN, MISSOURI CRUSHED GRANITE (BLACK). PROVIDE SAMPLE FOR LANDSCAPE ARCHITECT'S APPROVAL.



SOIL SAMPLE LOCATION

NOTE: OVER EXCAVATE STREAM IMPROVEMENT AREAS 12" BELOW FINISHED GRADE. REPLACE OVER-DIG WITH TWO 6" LIFTS OF COMPACTED CLAY. COMPACT CLAY TO 95% PROCTOR

NOTIFY OWNER IMMEDIATELY IN EVENTS OF DISCREPANCIES, OMISSIONS, AND/OR CONFLICTS IN THE DRAWINGS OR SPECIFICATIONS. THE CONTRACTOR IS NOT AUTHORIZED TO SCALE THE DRAWINGS. ALL QUESTIONS IN REFERENCE TO CONTRACT DOCUMENTS SHALL BE IMMEDIATELY DIRECTED TO THE OWNER.

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SOILS PLAN 1" = 20'

SOILS LEGEND

TURF SOIL
6" DEPTH TOP SOIL PRODUCED FROM ON SITE
SOILS AND AMENDED OR IMPORTED TOP SOIL
AMENDED PER SPECIFICATIONS.



NATIVE SEED & MEADOW SOIL
6" DEPTH TOP SOIL PRODUCED FROM ON SITE
SOILS AND AMENDED PER SPECIFICATIONS.



PERENNIAL SOIL

12" DEPTH TOP SOIL PRODUCED FROM ON SITE

SOILS OR IMPORTED SOILS AND AMENDED PER

SPECIFICATIONS.



BMP SOIL
IMPORTED BMP SOIL MIX PER DETAILS AND
SPECIFICATIONS DEPTH VARIES SEE PLAN AND
DETAILS.



RAIN GARDEN MINERAL MULCH

2" DEPTH, %" CLEAN, MISSOURI CRUSHED GRANITE
(BLACK). PROVIDE SAMPLE FOR LANDSCAPE
ARCHITECT'S APPROVAL.



SOIL SAMPLE LOCATION

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TOLL FREE 1-800-344-7483



SOILS LEGEND



TURF SOIL
6" DEPTH TOP SOIL PRODUCED FROM ON SITE
SOILS AND AMENDED OR IMPORTED TOP SOIL
AMENDED PER SPECIFICATIONS.



NATIVE SEED & MEADOW SOIL 6" DEPTH TOP SOIL PRODUCED FROM ON SITE SOILS AND AMENDED PER SPECIFICATIONS.



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SOILS OR IMPORTED SOILS AND AMENDED PER
SPECIFICATIONS.



BMP SOIL
IMPORTED BMP SOIL MIX PER DETAILS AND
SPECIFICATIONS DEPTH VARIES SEE PLAN AND
DETAILS.




RAIN GARDEN MINERAL MULCH
2" DEPTH, 3/8" CLEAN, MISSOURI CRUSHED GRANITE
(BLACK). PROVIDE SAMPLE FOR LANDSCAPE
ARCHITECT'S APPROVAL.



SOIL SAMPLE LOCATION

NOTE: OVER EXCAVATE STREAM IMPROVEMENT AREAS 12" BELOW FINISHED GRADE. REPLACE OVER-DIG WITH TWO 6" LIFTS OF COMPACTED CLAY. COMPACT CLAY TO 95% PROCTOR

NOTIFY OWNER IMMEDIATELY IN EVENTS OF DISCREPANCIES, OMISSIONS, AND/OR CONFLICTS IN THE DRAWINGS OR SPECIFICATIONS. THE CONTRACTOR IS NOT AUTHORIZED TO SCALE THE DRAWINGS. ALL QUESTIONS IN REFERENCE TO CONTRACT DOCUMENTS SHALL BE IMMEDIATELY DIRECTED TO THE OWNER.

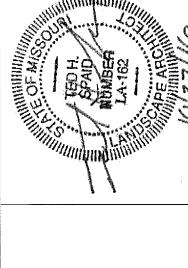

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MDC - SHEPHERD OF THE HILLS PLANT LEGEND DECIDUOUS TREES BOTANICAL NAME Sugar Maple Acer saccharum Betula nigra Cladrastis kentukea American Yellowwood Shagbark Hickory Carya ovata Black Gum nyssa sylvatica White Oak Quercus alba Chinkapin Oak Quercus muehlenbergii Overcup Oak Quercus lyrata Burr Oak Quercus macrocarpa Red Oak Quercus rubra Shumard Red Oak Quercus shumardii BOTANICAL NAME COMMON NAME EVERGREEN TREES Pinus echinata Short Leaf Pine COMMON NAME FLOWERING TREES BOTANICAL NAME American Hornbeam Carpinus caroliniana Eastern Redbud Cercis canadensis American Smoke Tree Cotinus obovatus Common Persimmon Diospyros virginiana Spring Blooming Witchhazel Hamamelis vernalis Sassafras albidum Sassafras

SHEPHERD OF THE HILLS
CONSERVATION NATURE CENTE

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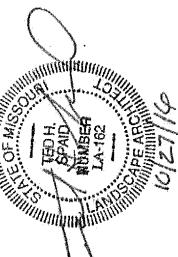
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AND/OR CONFLICTS IN THE DRAWINGS OR SPECIFICATIONS. THE CONTRACTOR IS NOT AUTHORIZED TO SCALE THE DRAWINGS. ALL QUESTIONS IN REFERENCE TO CONTRACT DOCUMENTS SHALL BE

NOTIFY OWNER IMMEDIATELY IN EVENTS OF DISCREPANCIES, OMISSIONS, IMMEDIATELY DIRECTED TO THE OWNER.

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MDC - SHEPHERD OF THE HILLS PLANT LEGEND COMMON NAME **BOTANICAL NAME** American Beautyberry Callicarpa americana Lindera benzoin Spicebush Fragrant Sumac Rhus aromatica Carolina Buckthorn Rhamnus caroliniana Smooth Sumac Rhus glabra Missouri Gooseberry Ribes missouriense Sambucus canadensis ORNAMENTAL GRASSES | BOTANICAL NAME COMMON NAME Broomsedge Bluestem Andropogon virginicus Bouteloua curtipendula Side Oats Grama Blue Grama Bouteloua gracilis Emory Sedge Carex emoryi Chasmanthium latifolium Wood Oats Whitetinge Sedge Carex albicans Horsetail Reed Grass Equisetum hyemale Dudley`s Rush Juncus dudleyi Pink Muhly Muhlenbergia capillaris Switch Grass Panicum virgatum Prairie Dropseed Sporobolus heterolepis PERENNIALS COMMON NAME BOTANICAL NAME Butterfly Milkweed Asclepias tuberosa Butterfly Milkweed | Asclepias tuberosa Eastern Bluestar Amsonia tabernaemontana Whorled Milkweed Asclepias verticillata Blue Wild Indigo Baptisia australis Lanceleaf Tickseed Coreopsis lanceolata Savannah Joe-Pye Weed Eupatorium purpureum Spotted Geranium Geranium maculatum Sneezeweed Helenium autumnale Woodland Sunflower Helianthus divaricatus Hypericum hypericoides hypericoides St. Andrew's Cross Spotted St. Johnswort Hypericum punctatum Rough Blazing Star Liatris aspera Lobelia siphilitica Great Lobelia Eastern Bee Balm | Monarda bradburiana Yellow Praire Coneflower Ratibida columnifera

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Black Eyed Susan

Soapweed

Call Before you DIG TOLL FREE 1-800-344-7483 MISSOURI ONE-CALL SYSTEM INC.


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Rudbeckia missouriensis Yucca glauca

IMMEDIATELY DIRECTED TO THE OWNER.



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Spicebush Lindera benzoin 19-HH---17-AC 32-ME 20-EP2 30-AV2/---Rhus aromatica Fragrant Sumac 57-RC— 34-ME-16-HH— 211-LA — 28-HH-Rhamnus caroliniana Carolina Buckthorn /10-ва — - 19-EP2---54-RC-48-HH-Smooth Sumac Rhus glabra 69-RM--38-CS ED RM2 Missouri Gooseberry Ribes missouriense 62-CL Sambucus canadensis Elderberry 28-AT2 21-CS 17-HH ORNAMENTAL GRASSES | BOTANICAL NAME COMMON NAME Broomsedge Bluestem Andropogon virginicus 22 EP2,-11-AT2-54-AV2 31-ME-6-MC-Side Oats Grama Bouteloua curtipendula ~ 81-AV2 16-BA --- 45-ME 36-RM-Bouteloua gracilis Blue Grama 22-EP2 ~43-LA -. 11-JD ₇ Emory Sedge Carex emoryi 6-RB— 50-AV2-13√MC— | Chasmanthium latifolium Wood Oats 54-ME 64-CE ---- 45-AV2/ CW Carex albicans Whitetinge Sedge - 26-EP2 32 MC Equisetum hyemale Horsetail Reed Grass 20-AT2---Juncus dudleyi Dudley`s Rush 12 RM2 Pink Muhly Muhlenbergia capillaris Panicum virgatum Switch Grass Sporobolus heterolepis Prairie Dropseed 28-AV2-16-CB-34-ME-PERENNIALS BOTANICAL NAME COMMON NAME Butterfly Milkweed Asclepias tuberosa 52-LA ----48÷CҢ – 3-RA ---17-AT2 AC2 Butterfly Milkweed Asclepias tuberosa 6-HH---- 38-LA 14-HH---- 57 **-** GM Eastern Bluestar Amsonia tabernaemontana 48-LA /80-LA-Whorled Milkweed Asclepias verticillata 4-RA 43-AV2--21-MC 25-AT2 58-GM,— Blue Wild Indigo |Baptisia australis 50-CE 8-RA 56-CE 25-CS 26-RM-Lanceleaf Tickseed Coreopsis lanceolata 59-CL 13-CS-45-ME Eupatorium purpureum Savannah Joe-Pye Weed 58-SH--20-SH_ 47-CÉ GM Geranium maculatum Spotted Geranium 45-ME Sneezeweed Helenium autumnale 79-CL/ Helianthus divaricatus Woodland Sunflower 66-LA -/51-AV2-/97-LA Hypericum hypericoides hypericoides St. Andrew`s Cross 2-RB-13-HH Hypericum punctatum Spotted St. Johnswort 38-CE 40-CL Rough Blazing Star Liatris aspera 10-RM2 71 - GM---Lobelia siphilitica Great Lobelia 28-RC 34-CE-27-MC -Eastern Bee Balm Monarda bradburiana 8-EP2 -MATCHLINE SEE SHEET L-155 Yellow Praire Coneflower Ratibida columnifera Rudbeckia missouriensis Black Eyed Susan

MATCHLINE SEE SHEET L-152

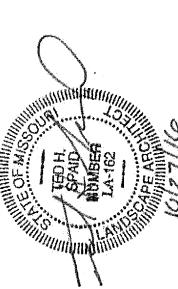MATCHLINE SEE SHEET L-154

UNDERSTORY PLANTING PLAN



Bid

2016

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NOTIFY OWNER IMMEDIATELY IN EVENTS OF DISCREPANCIES, OMISSIONS, AND/OR CONFLICTS IN THE DRAWINGS OR SPECIFICATIONS. THE CONTRACTOR IS NOT AUTHORIZED TO SCALE THE DRAWINGS. ALL QUESTIONS IN REFERENCE TO CONTRACT DOCUMENTS SHALL BE IMMEDIATELY DIRECTED TO THE OWNER.

Soapweed

Yucca glauca

MDC - SHEPHERD OF THE HILLS PLANT LEGEND

BOTANICAL NAME

Callicarpa americana

COMMON NAME

American Beautyberry

SHRUBS

TBD Issued: Revised: AS NOTED Scale: CS Drawn: Checked: KDR 14023

Plotted On: 10/27/2016

Soapweed Yucca glauca NOTIFY OWNER IMMEDIATELY IN EVENTS OF DISCREPANCIES, OMISSIONS, AND/OR CONFLICTS IN THE DRAWINGS OR SPECIFICATIONS. THE CONTRACTOR IS NOT AUTHORIZED TO SCALE THE DRAWINGS. ALL QUESTIONS IN REFERENCE TO CONTRACT DOCUMENTS SHALL BE IMMEDIATELY DIRECTED TO THE OWNER.

Hypericum hypericoides hypericoides St. Andrew's Cross

COMMON NAME

Fragrant Sumac

Smooth Sumac

Carolina Buckthorn

Missouri Gooseberry

COMMON NAME

Side Oats Grama

Whitetinge Sedge

Dudley`s Rush

Prairie Dropseed

COMMON NAME

Butterfly Milkweed

Butterfly Milkweed

Eastern Bluestar

Blue Wild Indigo

Whorled Milkweed

Lanceleaf Tickseed

Spotted Geranium

Woodland Sunflower

Spotted St. Johnswort

Rough Blazing Star

Eastern Bee Balm

Black Eyed Susan

Yellow Praire Coneflower

Great Lobelia

Savannah Joe-Pye Weed

Horsetail Reed Grass

American Beautyberry

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	508	MDC - SHEPHERD OF	THE HILLS PLANT L	EGEND
	2		ANICAL NAME	COMMON NAM
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$-\frac{1}{100} + \frac{1}{100} + 1$	+) - (+) +)		era benzoin	Spicebush
9-LB			s aromatica	Fragrant Suma
			mnus caroliniana	Carolina Buckt
			s glabra	Smooth Sumad
	1 1 1 1 1 1 1 1 1 1		es missouriense 	Elderberry
Add the state of t		Se		Liderberry
		ORNAMENTAL GRASSES BOTA	ANICAL NAME	COMMON NAI
			ropogon virginicus	Broomsedge B
	Z I		teloua curtipendula	Side Oats Gra
		BG Bout	teloua gracilis	Blue Grama
	5	CE Care	ex emoryi	Emory Sedge
		CS Chas	smanthium latifolium	Wood Oats
		CW Care	ex albicans	Whitetinge Sec
	5		isetum hyemale	Horsetail Reed
			cus dudleyi	Dudley`s Rush
			nlenbergia capillaris	Pink Muhly
			icum virgatum	Switch Grass Prairie Dropse
		SH	robolus heterolepis	Frame Dropse
		PERENNIALS BOT	ΓANICAL NAME	COMMON NA
			lepias tuberosa	Butterfly Milkw
			lepias tuberosa	Butterfly Milkw
		AT2 Ams	sonia tabernaemontana	Eastern Blues
		AV Ascl	lepias verticillata	Whorled Milkw
		BA Bap	otisia australis	Blue Wild Indig
		CL Core	eopsis lanceolata	Lanceleaf Tick
			atorium purpureum	Savannah Joe
			anium maculatum	Spotted Gerar
			enium autumnale	Sneezeweed
			ianthus divaricatus	Woodland Su
			pericum hypericoides hypericoides	Spotted St. Jo
			pericum punctatum ris aspera	Rough Blazing
			pelia siphilitica	Great Lobelia
	1		narda bradburiana	Eastern Bee E
A UNDERSTORY PLANTING PLAN 1" = 20'	Graphic Scale: 1" = 20'		ibida columnifera	Yellow Praire
1" = 20'	0' 10' 20' 40' 6		dbeckia missouriensis	Black Eyed S

Call Before you DIG TOLL FREE 1-800-344-7483 MISSOURI ONE-CALL SYSTEM INC.

2016

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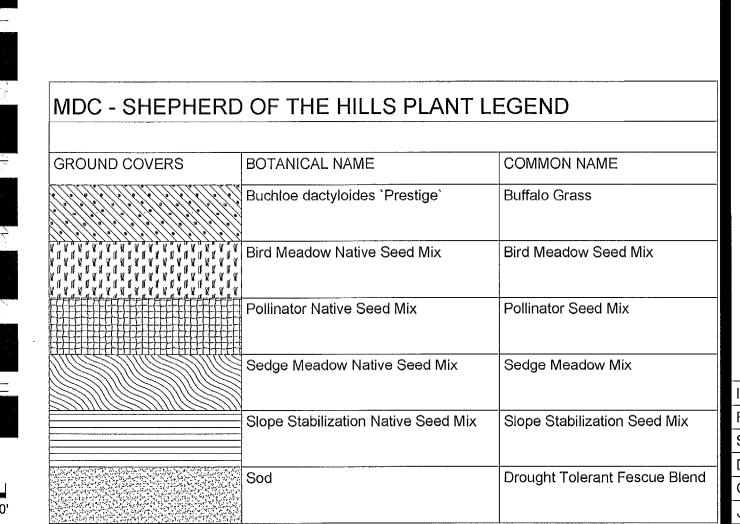


MDC - SHEPHERD OF THE HILLS PLANT LEGEND COMMON NAME BOTANICAL NAME American Beautyberry Callicarpa americana Spicebush Lindera benzoin Fragrant Sumac Rhus aromatica Rhamnus caroliniana Carolina Buckthorn Smooth Sumac Rhus glabra Missouri Gooseberry Ribes missouriense Elderberry Sambucus canadensis COMMON NAME ORNAMENTAL GRASSES | BOTANICAL NAME Broomsedge Bluestem Andropogon virginicus Side Oats Grama BC Bouteloua curtipendula Blue Grama BG Bouteloua gracilis Emory Sedge Carex emoryi Wood Oats Chasmanthium latifolium CW Whitetinge Sedge Carex albicans Horsetail Reed Grass Equisetum hyemale Dudley`s Rush Juncus dudleyi Pink Muhly Muhlenbergia capillaris Switch Grass Panicum virgatum Prairie Dropseed Sporobolus heterolepis COMMON NAME BOTANICAL NAME PERENNIALS Butterfly Milkweed Asclepias tuberosa Butterfly Milkweed Asclepias tuberosa Amsonia tabernaemontana Eastern Bluestar Whorled Milkweed Asclepias verticillata Blue Wild Indigo Baptisia australis Lanceleaf Tickseed Coreopsis lanceolata Savannah Joe-Pye Weed EP2 Eupatorium purpureum Spotted Geranium Geranium maculatum Sneezeweed Helenium autumnale Woodland Sunflower Helianthus divaricatus Hypericum hypericoides hypericoides | St. Andrew's Cross Spotted St. Johnswort Hypericum punctatum Rough Blazing Star Liatris aspera Great Lobelia Lobelia siphilitica Eastern Bee Balm Monarda bradburiana Ratibida columnifera Yellow Praire Coneflower Black Eyed Susan RM Rudbeckia missouriensis Soapweed

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NOTIFY OWNER IMMEDIATELY IN EVENTS OF DISCREPANCIES, OMISSIONS, AND/OR CONFLICTS IN THE DRAWINGS OR SPECIFICATIONS. THE CONTRACTOR IS NOT AUTHORIZED TO SCALE THE DRAWINGS. ALL QUESTIONS IN REFERENCE TO CONTRACT DOCUMENTS SHALL BE IMMEDIATELY DIRECTED TO THE OWNER.

Yucca glauca



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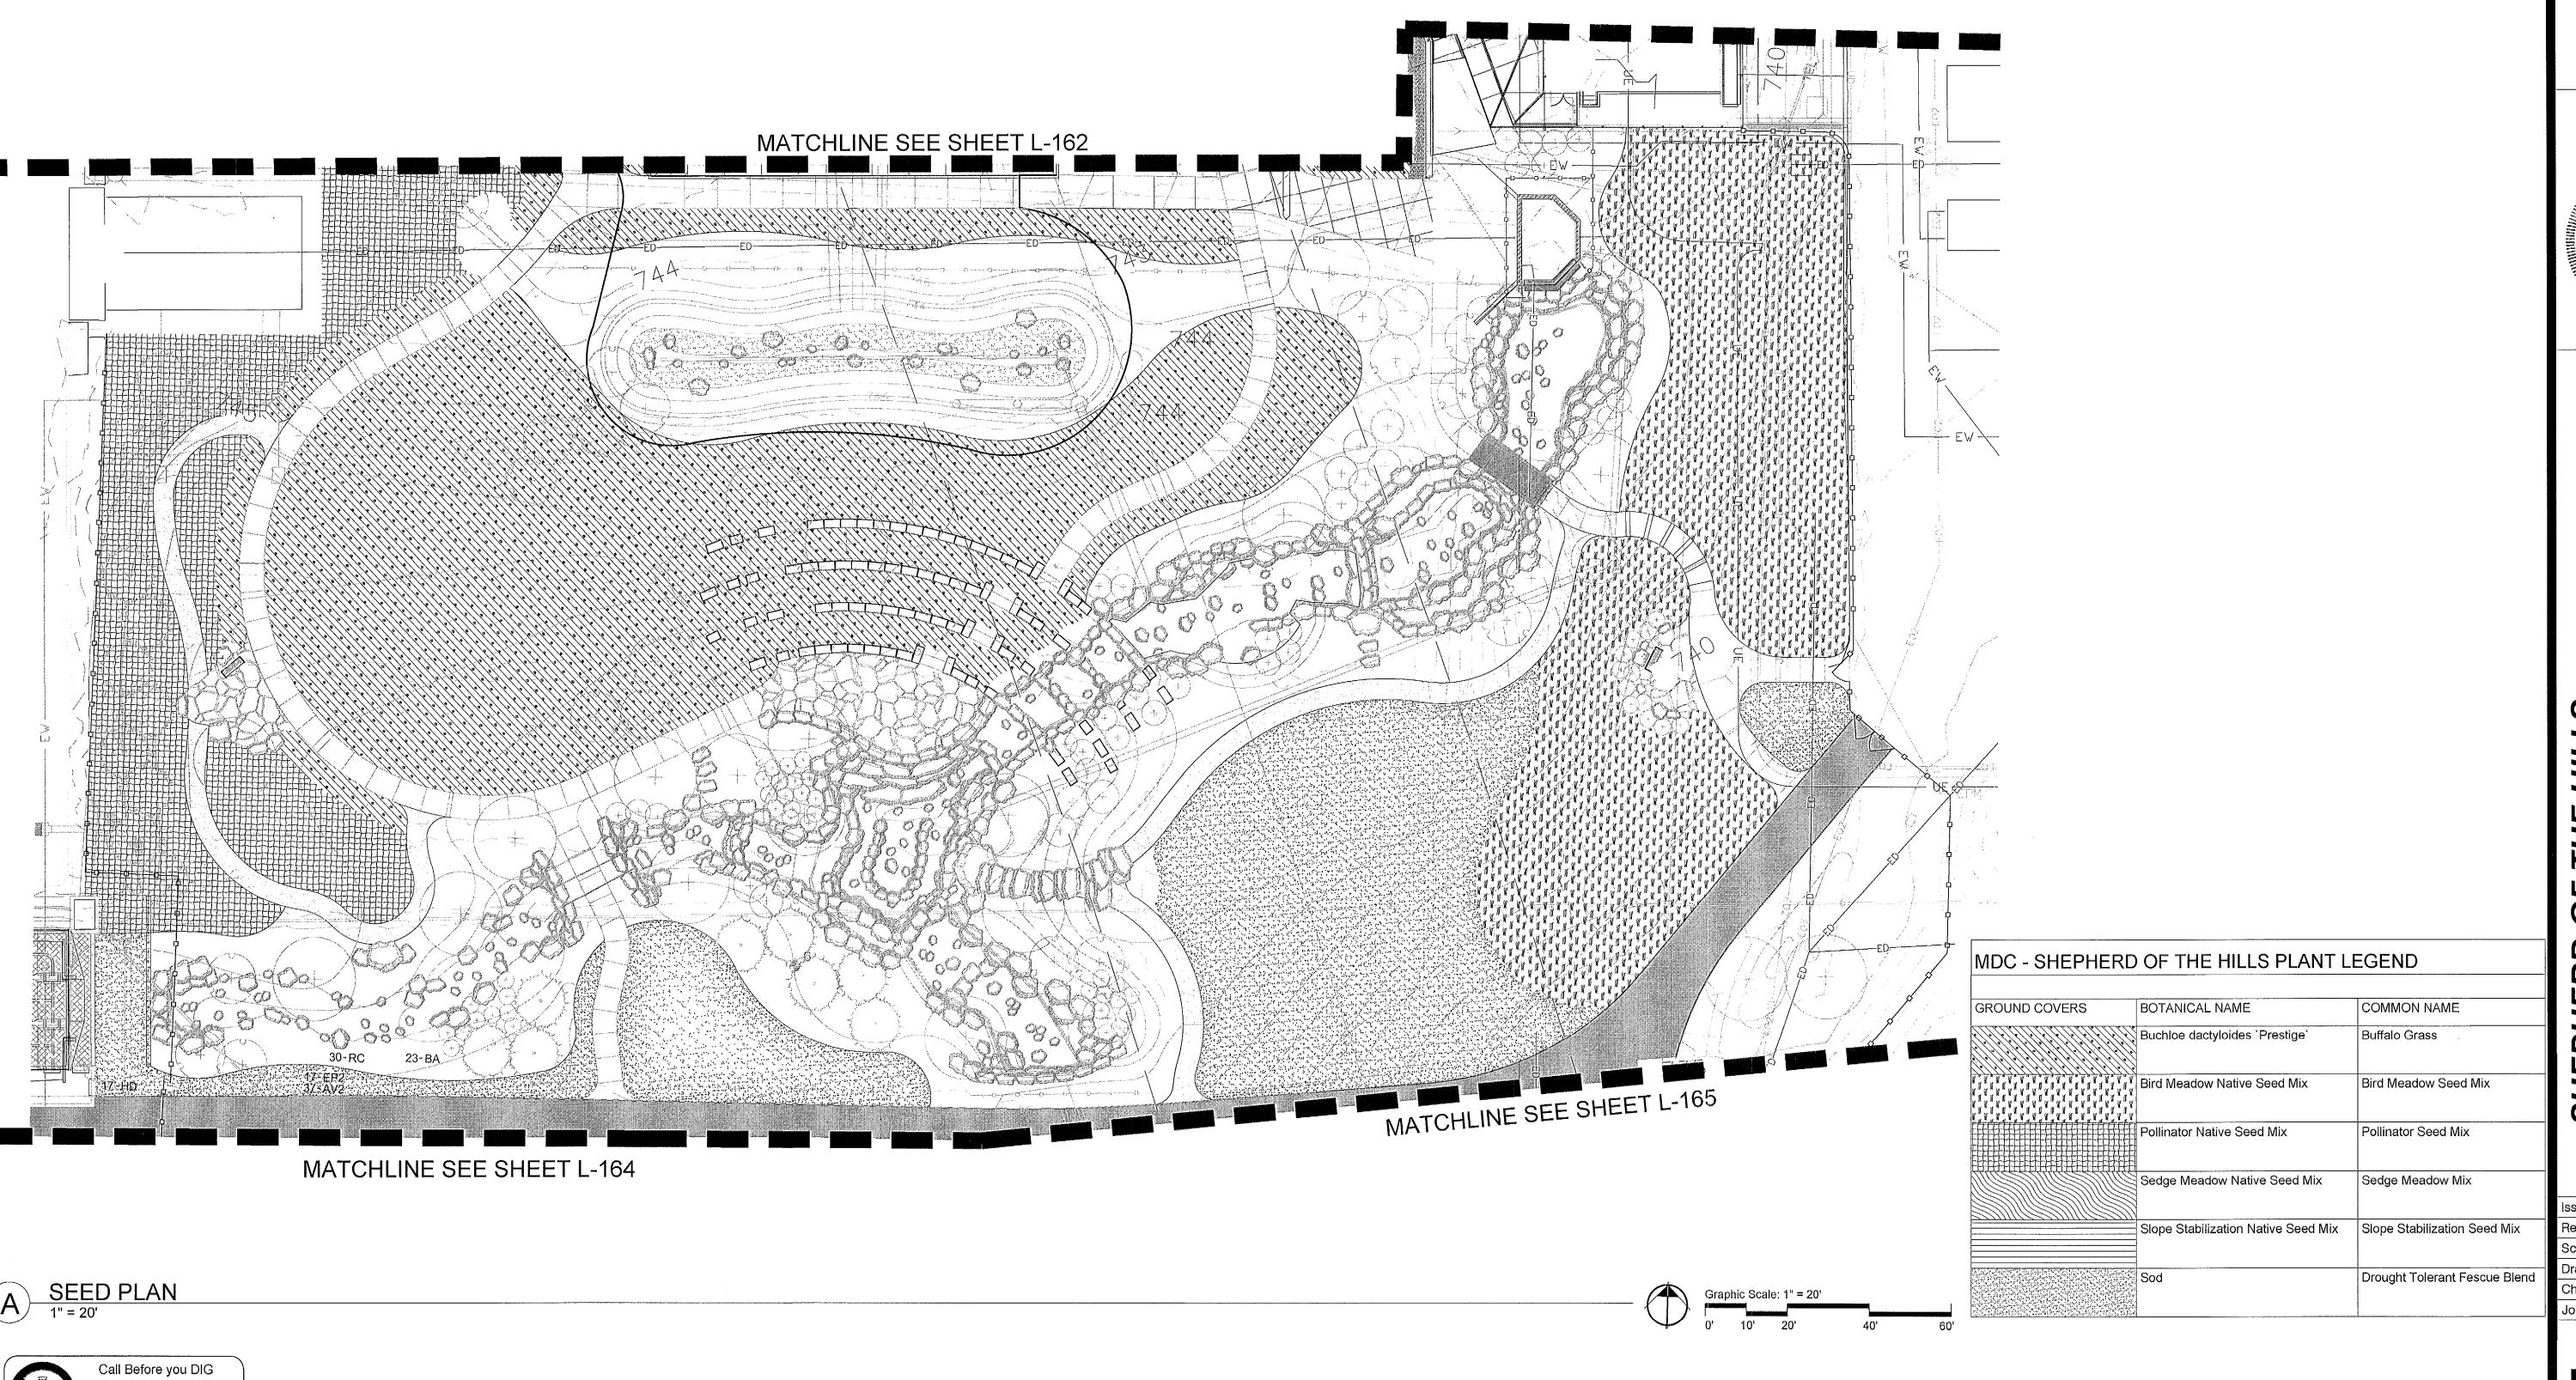
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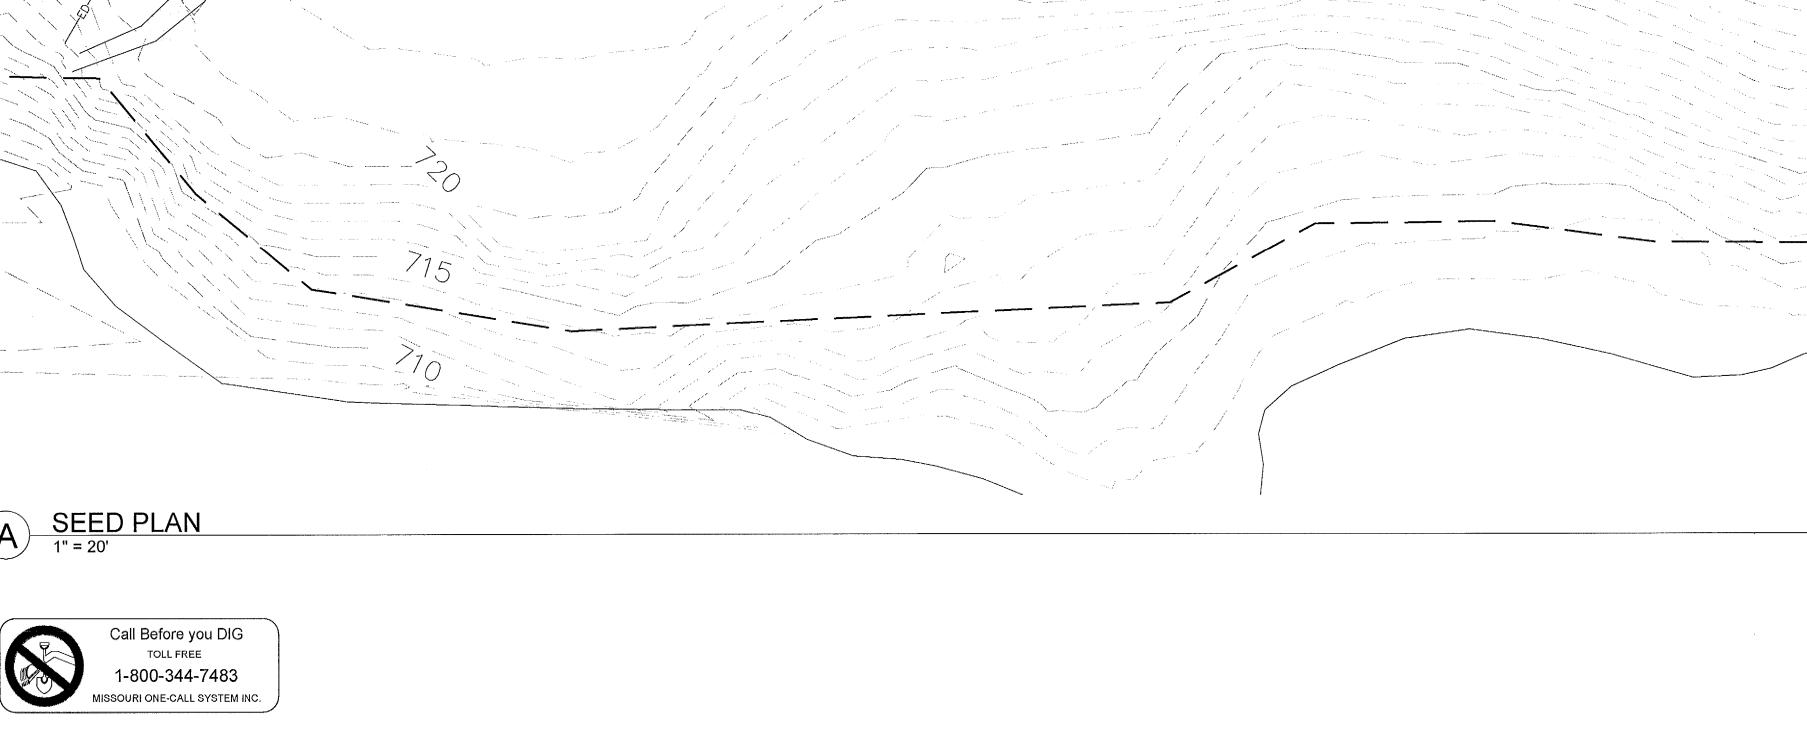


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DAKE | WELLS architecture



MDC - SHEPHERD OF THE HILLS PLANT LEGEND COMMON NAME BOTANICAL NAME GROUND COVERS Buffalo Grass 🕽 Buchloe dactyloides `Prestige` Bird Meadow Seed Mix Pollinator Seed Mix Pollinator Native Seed Mix Sedge Meadow Native Seed Mix Sedge Meadow Mix Slope Stabilization Native Seed Mix Slope Stabilization Seed Mix

Drought Tolerant Fescue Blend

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