




]	
	KEYNOTE LE	GEND	RARAGON
	05.521 EXTERIOR RAILING. SEE CIVIL. COORE SECTION 05.5213 PIPE AND TUBE RAIL	INGS.	R
	06.1000 ROUGH CARPENTRY.	RIZONTAL METAL PANEL. SEE SECTION	
	07.721 ROOF VENTS. TWO 5'X8' OPENINGS CE DIVISION 07.7200 ROOF ACCESSORIES 09.922 EXPOSED PEMB FRAME TO BE PAINTE		
	10.141 DEDICATION PLAQUE AND STAND.		
	10.142 DIMENSIONAL LETTERING ATTACHED SIGNAGE MANUFACTURER. SEE SECT		TA AND
	10.143 CANTILEVERED SIGN ATTACHED TO P ATTACHMENT BY SIGNAGE MANUFAC	RE-ENGINEERED METAL BUILDING. FURER. SEE SECTION 10.1400 SIGNAGE.	ACHITECTUR
	11.130 LOADING DOCK BUMPERS. SEE SECTI 13.350 PRE-ENGINEERED METAL BUILDING W		MISSOURI STATE CERTIFICATE OF AUTHORITY NUMBER A-2016000415
	METAL BUILDING SYSTEMS. 13.373 PRE-ENGINEERED METAL BUILDING 7 MANULEACTUREP'S STANDARD DETAIL	"X7" METAL GUTTER PER S. SEE SECTION 13.3419 METAL BUILDING	637 COLLEGE STREET SPRINGFIELD, MO 65806
	13.375 PRE-ENGINEERED METAL BUILDING 4"		PH: 417.885.0002
		S. SEE SECTION 13.3419 METAL BUILDING	www.paragonarchitecture.com
	13.385SNOW GUARDS. SEE ROOF PLAN FOR13.386PREFINISHED METAL FASCIA WITH DR	LOCATIONS. IP EDGE. PROVIDE MIN. 4" OVERLAP AT	STRUCTURAL ENGINEER
	ENDS WITH CONTINUOUS SEALANT A SYSTEMS.		RTM ENGINEERING CONSULTANTS 3045 S KANSAS EXPY
	13.389 C-METAL TRIM WITH POP RIVET AT 12' BUILDING SYSTEMS. 13.390 BASE JOGGLE CLEAT. SEE SECTION 1	O.C. MAX. SEE SECTION 13.3419 METAL	SPRINGFIELD, MO 65807 417-708-9315 MEP ENGINEER
	13.391 REVEAL FLASHING. SEE SECTION 13.3 13.392 Z-METAL TRIM. SEE SECTION 13.3419 I	419 METAL BUILDING SYSTEMS.	TTM ENGINEERING CONSULTANTS 3333 E BATTLEFIELD RD SUITE 1000
	13.393 METAL TRIM WITH POP RIVET AT 12" C BUILDING SYSTEMS.		SPRINGFIELD, MO 65804 417-881-0020 CIVIL ENGINEER
	METAL BUILDING SYSTEMS.	ET AT 12" O.C. MAX. SEE SECTION 13.3419	OLSSON 550 E ST. LOUIS ST
	13.395 PRE-ENGINEERED METAL BUILDING W MORE INFORMATION. SEE SECTION 13	3.3419 METAL BUILDING SYSTEMS.	SPRINGFIELD, MO 65806 417-890-8802 CONSTRUCTION MANAGER
	SEE SECTION 13.3416 METAL BUILDING		RE SMITH CONSTRUCTION COMPANY 1036 W 2ND ST
	22.001 PLUMBING. SEE MEP. SEE DIVISION 22 23.310 PAINTED METAL DUCTS. SEE MEP. SE COORDINATE COLOR WITH ARCHITEC	E DIVISION 23.0000 SPECIFICATIONS.	JOPLIN, MO 64801 417-623-4545
		NT WITH CURB. SEE MEP. SEE DIVISION	NINNINNINNIN
	ARCHITECT. 23.800 NATURAL GAS METER. SEE MEP. SEE	DIVISION 23.0000 SPECIFICATIONS.	
	26.000ELECTRICAL EQUIPMENT. SEE MEP. S26.001PAINT PER ARCH.		
	26.241SECURITY DEVICES. SEE MEP. SEE DI26.600EXTERIOR LIGHTING. SEE MEP. SEE DI	VISION 26.0000 SPECIFICATIONS.	* YOUNGLOVE * NUMBER A-2017019282
	32.171BOLLARDS. SEE CIVIL. SEE DIVISION 332.320SEGMENTAL RETAINING WALLS. SEE 0		A-2017019282
	SPECIFICATIONS.		San Children Children S.17.23
			JARED A. YOUNGLOVE, ARCHITECT MO #: A-2017019282
DM <u>EAVE</u> 8' - 1 1/2"	the second state and the state of the state	to the state of the state of the state of the	MO #: A-2017019282 COPYRIGHT 2023©
8' - 1 1/2" 🏹			THESE PROPERTY OF PARAGON ARCHITECTURE, LLC AND SHALL BE USED ONLY FOR THE PROJECT REFERENCE BELOW
			REVISION SCHEDULE
<u>SROOMS</u> 94' - 0"			
	13.397	13.391	
		13.390	
	-	13.308	
	METAL PANE		
	6 TRANSITION	UEIAIL	
	SCALE 11/2" = 1'-0"		S
			L~
			PERFORMING ARTS
			\geq
		13.392	Ц
			U L
		13.394	Ĭ
		13.350	Щ
		06.115	₅₃
		13.397	
			T Š
			Щ
	-		
	METAL PANE		ECT DESCRIPTION: ASSVILLE HS: I ENTER STATE HWY Y, CASSVILLE, MO 65625
			ECT DESCRIPTION ASSVII ENTEP STATE HWY Y, O
	F TRANSITION	DETAIL	
	SCALE 11/2" = 1'-0"		
			PROJECT ARCHITECT: JAY
	EXTERIOR WALL		
	MB.01 PRE-ENGINEERED METAL BUILDING M WITH INTERIOR 3 5/8" STUD FRAMING. MANUFACTURER. PROVIDE R-13 FIBER	ETAL WALL PANEL SIDING OVER 8" GIRTS GIRTS ENGINEERED BY METAL BUILDING RGLASS INSULATION AND VAPOR	PROJECT ARCHITECT: JAY DRAWN BY: TW, TD, KW CHECKED BY: KW, JS, JAY
	EXTERIOR WALL MB.01 PRE-ENGINEERED METAL BUILDING M WITH INTERIOR 3 5/8" STUD FRAMING.	ETAL WALL PANEL SIDING OVER 8" GIRTS GIRTS ENGINEERED BY METAL BUILDING RGLASS INSULATION AND VAPOR	PROJECT ARCHITECT: JAY DRAWN BY: TW, TD, KW CHECKED BY: KW, JS, JAY PROJECT NUMBER:
	EXTERIOR WALL MB.01 PRE-ENGINEERED METAL BUILDING M WITH INTERIOR 3 5/8" STUD FRAMING, MANUFACTURER. PROVIDE R-13 FIBEI RETARDER. SEE A3 SERIES SHEETS F ORIENTATION.	ETAL WALL PANEL SIDING OVER 8" GIRTS GIRTS ENGINEERED BY METAL BUILDING RGLASS INSULATION AND VAPOR OR INFORMATION ON METAL PANEL	PROJECT ARCHITECT: JAY DRAWN BY: TW, TD, KW CHECKED BY: KW, JS, JAY PROJECT NUMBER: 21-620
	MB.01 PRE-ENGINEERED METAL BUILDING M WITH INTERIOR 3 5/8" STUD FRAMING. MANUFACTURER. PROVIDE R-13 FIBEI RETARDER. SEE A3 SERIES SHEETS F	ETAL WALL PANEL SIDING OVER 8" GIRTS GIRTS ENGINEERED BY METAL BUILDING RGLASS INSULATION AND VAPOR OR INFORMATION ON METAL PANEL	PROJECT ARCHITECT: JAY DRAWN BY: TW, TD, KW CHECKED BY: KW, JS, JAY PROJECT NUMBER: 21-620 DATE:
	EXTERIOR WALL MB.01 PRE-ENGINEERED METAL BUILDING M WITH INTERIOR 3 5/8" STUD FRAMING. MANUFACTURER. PROVIDE R-13 FIBEI RETARDER. SEE A3 SERIES SHEETS F ORIENTATION. METAL PANEL TY VERTICAL METAL PANEL - INSTAL	ETAL WALL PANEL SIDING OVER 8" GIRTS GIRTS ENGINEERED BY METAL BUILDING RGLASS INSULATION AND VAPOR OR INFORMATION ON METAL PANEL	PROJECT ARCHITECT: JAY DRAWN BY: TW, TD, KW CHECKED BY: KW, JS, JAY PROJECT NUMBER: 21-620
	EXTERIOR WALL MB.01 PRE-ENGINEERED METAL BUILDING M WITH INTERIOR 3 5/8" STUD FRAMING. MANUFACTURER. PROVIDE R-13 FIBEI RETARDER. SEE A3 SERIES SHEETS F ORIENTATION. METAL PANEL TY VERTICAL METAL PANEL - INSTAL BASIS OF DESIGN: SBS, SBS-369 M	ETAL WALL PANEL SIDING OVER 8" GIRTS GIRTS ENGINEERED BY METAL BUILDING RGLASS INSULATION AND VAPOR OR INFORMATION ON METAL PANEL PELEGEND LED OVER 5/8" PLYWOOD SHEATHING. IETAL PANELS. COLOR: LIGHT STONE.	PROJECT ARCHITECT: JAY DRAWN BY: TW, TD, KW CHECKED BY: KW, JS, JAY PROJECT NUMBER: 21-620 DATE:
	EXTERIOR WALL MB.01 PRE-ENGINEERED METAL BUILDING M WITH INTERIOR 3 5/8" STUD FRAMING. MANUFACTURER. PROVIDE R-13 FIBEI RETARDER. SEE A3 SERIES SHEETS F ORIENTATION. METAL PANEL TY VERTICAL METAL PANEL - INSTAL BASIS OF DESIGN: SBS, SBS-369 M	ETAL WALL PANEL SIDING OVER 8" GIRTS GIRTS ENGINEERED BY METAL BUILDING RGLASS INSULATION AND VAPOR OR INFORMATION ON METAL PANEL PE LEGEND LED OVER 5/8" PLYWOOD SHEATHING.	PROJECT ARCHITECT: JAY DRAWN BY: TW, TD, KW CHECKED BY: KW, JS, JAY PROJECT NUMBER: 21-620 DATE: 2023.05.17
	EXTERIOR WALL MB.01 PRE-ENGINEERED METAL BUILDING M WITH INTERIOR 3 5/8" STUD FRAMING. MANUFACTURER. PROVIDE R-13 FIBEI RETARDER. SEE A3 SERIES SHEETS F ORIENTATION. METTAL PANEL TY VERTICAL METAL PANEL - INSTAL BASIS OF DESIGN: SBS, SBS-369 N HORIZONTAL METAL PANEL 1 - BA PANELS. COLOR: DESERT SAND.	ETAL WALL PANEL SIDING OVER 8" GIRTS GIRTS ENGINEERED BY METAL BUILDING RGLASS INSULATION AND VAPOR OR INFORMATION ON METAL PANEL DED OVER 5/8" PLYWOOD SHEATHING. IETAL PANELS. COLOR: LIGHT STONE. ASIS OF DESIGN: SBS, SBS-369 METAL	PROJECT ARCHITECT: JAY DRAWN BY: TW, TD, KW CHECKED BY: KW, JS, JAY PROJECT NUMBER: 21-620 DATE: 2023.05.17 EXTERIOR
	EXTERIOR WALL MB.01 PRE-ENGINEERED METAL BUILDING M WITH INTERIOR 3 5/8" STUD FRAMING. MANUFACTURER. PROVIDE R-13 FIBEI RETARDER. SEE A3 SERIES SHEETS F ORIENTATION. METTAL PANEL TY VERTICAL METAL PANEL - INSTAL BASIS OF DESIGN: SBS, SBS-369 N HORIZONTAL METAL PANEL 1 - BA PANELS. COLOR: DESERT SAND.	ETAL WALL PANEL SIDING OVER 8" GIRTS GIRTS ENGINEERED BY METAL BUILDING RGLASS INSULATION AND VAPOR OR INFORMATION ON METAL PANEL PELEGEND LED OVER 5/8" PLYWOOD SHEATHING. IETAL PANELS. COLOR: LIGHT STONE.	PROJECT ARCHITECT: JAY DRAWN BY: TW, TD, KW CHECKED BY: KW, JS, JAY PROJECT NUMBER: 21-620 DATE: 2023.05.17 EXTERIOR ELEVATIONS
	EXTERIOR WALL MB.01 PRE-ENGINEERED METAL BUILDING M WITH INTERIOR 3 5/8" STUD FRAMING. MANUFACTURER. PROVIDE R-13 FIBEL RETARDER. SEE A3 SERIES SHEETS F ORIENTATION. METTICAL METAL PANEL TY VERTICAL METAL PANEL - INSTAL BASIS OF DESIGN: SBS, SBS-369 M HORIZONTAL METAL PANEL 1 - BASIS. COLOR: DESERT SAND. HORIZONTAL METAL PANEL 2 - BASIS. COLOR: DESERT SAND.	ETAL WALL PANEL SIDING OVER 8" GIRTS GIRTS ENGINEERED BY METAL BUILDING RGLASS INSULATION AND VAPOR OR INFORMATION ON METAL PANEL DED OVER 5/8" PLYWOOD SHEATHING. IETAL PANELS. COLOR: LIGHT STONE. ASIS OF DESIGN: SBS, SBS-369 METAL ASIS OF DESIGN: SBS, SBS-369 METAL	RET NUMBER:
	EXTERIOR WALL MB.01 PRE-ENGINEERED METAL BUILDING M WITH INTERIOR 3 5/8" STUD FRAMING. MANUFACTURER. PROVIDE R-13 FIBEL RETARDER. SEE A3 SERIES SHEETS F ORIENTATION. METARDER. SEE A3 SERIES SHEETS F ORIENTATION. WERTICAL METAL PANEL TY VERTICAL METAL PANEL - INSTAL BASIS OF DESIGN: SBS, SBS-369 M HORIZONTAL METAL PANEL 1 - BA PANELS. COLOR: DESERT SAND. HORIZONTAL METAL PANEL 2 - BA PANEL. COLOR: POLAR WHITE. MORIZONTAL METAL PANEL 2 - BA	ETAL WALL PANEL SIDING OVER 8" GIRTS GIRTS ENGINEERED BY METAL BUILDING RGLASS INSULATION AND VAPOR OR INFORMATION ON METAL PANEL DED OVER 5/8" PLYWOOD SHEATHING. IETAL PANELS. COLOR: LIGHT STONE. ASIS OF DESIGN: SBS, SBS-369 METAL	RET NUMBER:
	EXTERIOR WALL MB.01 PRE-ENGINEERED METAL BUILDING M WITH INTERIOR 3 5/8" STUD FRAMING. MANUFACTURER. PROVIDE R-13 FIBEL RETARDER. SEE A3 SERIES SHEETS F ORIENTATION. METARDER. SEE A3 SERIES SHEETS F ORIENTATION. WERTICAL METAL PANEL TY VERTICAL METAL PANEL - INSTAL BASIS OF DESIGN: SBS, SBS-369 M HORIZONTAL METAL PANEL 1 - BA PANELS. COLOR: DESERT SAND. HORIZONTAL METAL PANEL 2 - BA PANEL. COLOR: POLAR WHITE. ANGLED METAL PANEL - INSTALLE PLYWOOD SHEATHING. BASIS OF	ETAL WALL PANEL SIDING OVER 8" GIRTS GIRTS ENGINEERED BY METAL BUILDING RGLASS INSULATION AND VAPOR OR INFORMATION ON METAL PANEL DECOMPATION ON METAL PANEL LED OVER 5/8" PLYWOOD SHEATHING. METAL PANELS. COLOR: LIGHT STONE. ASIS OF DESIGN: SBS, SBS-369 METAL ASIS OF DESIGN: SBS, SBS-369 METAL ED AT A 70 DEGREE ANGLE OVER 5/8" DESIGN: SBS, SBS-369 METAL PANEL.	PROJECT ARCHITECT: JAY DRAWN BY: TW, TD, KW CHECKED BY: KW, JS, JAY PROJECT NUMBER: 21-620 DATE: 2023.05.17 EXTERIOR ELEVATIONS

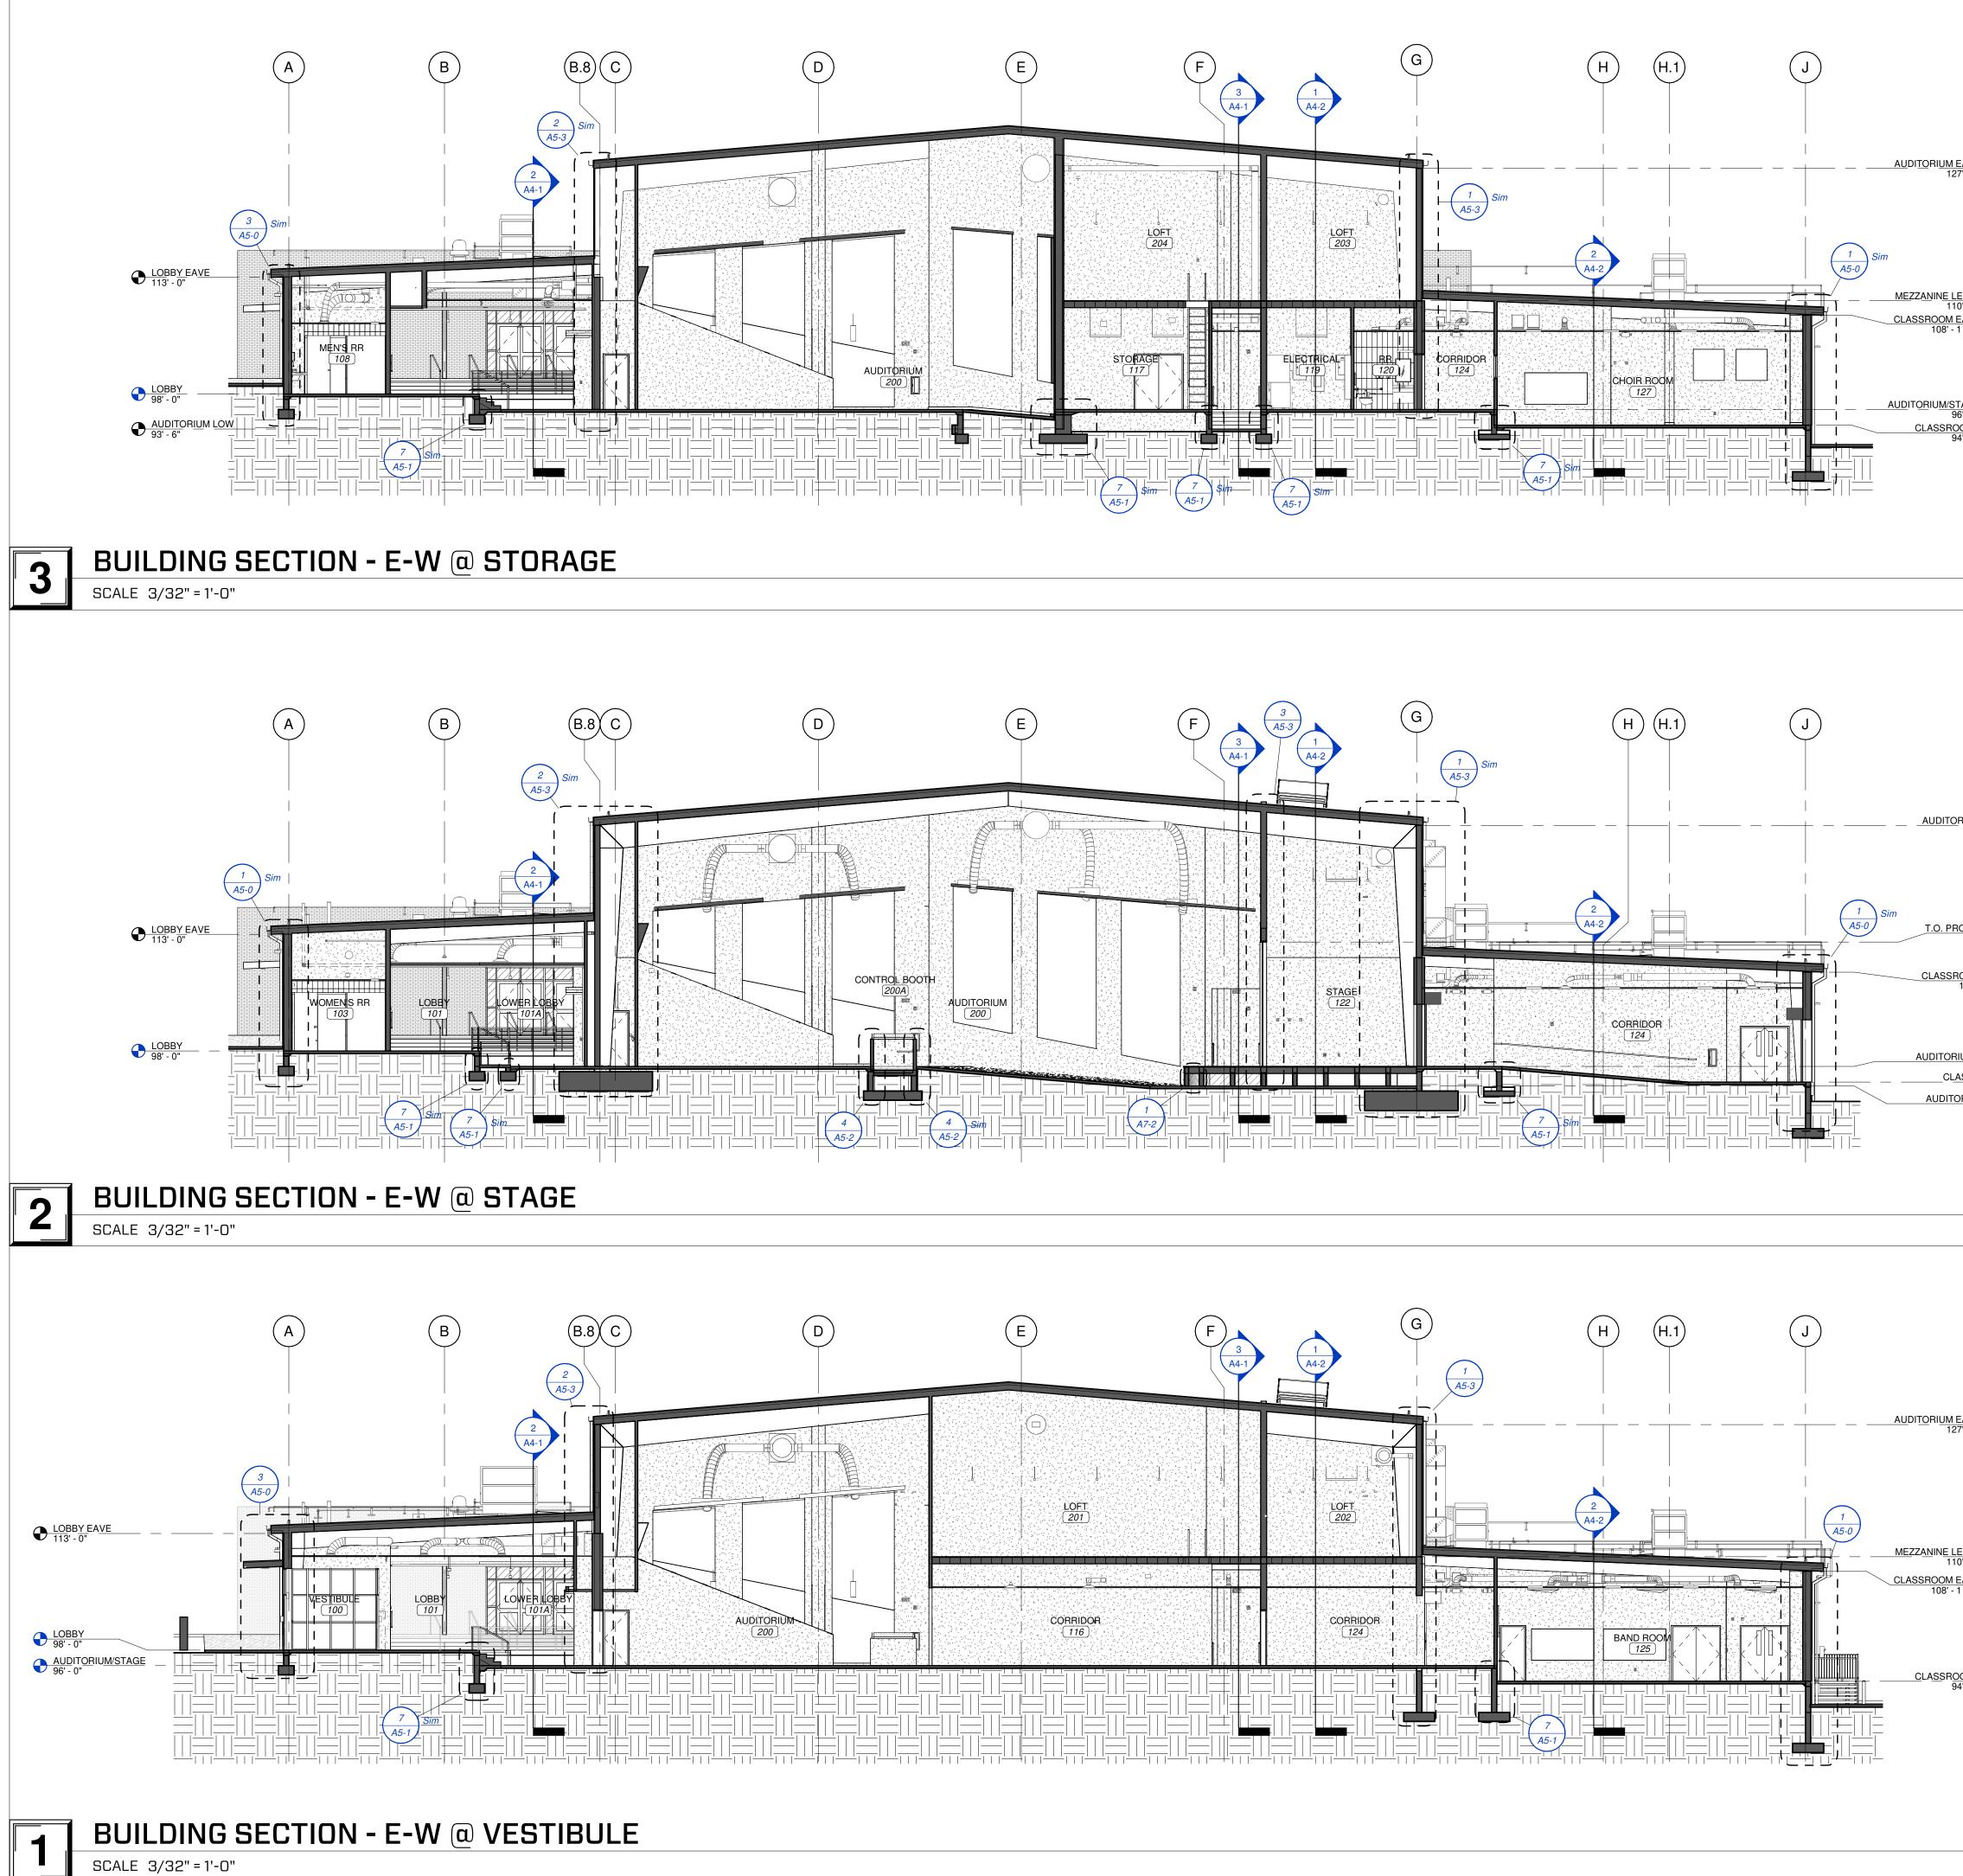



	GINEER GINEERING CONSULTANTS BATTLEFIELD RD SUITE 1000 FIELD, MO 65804 -0020 VGINEER N T. LOUIS ST FIELD, MO 65806
BUILDING SECTION - E-W @ STORAGE	JARED A. YOUNGLOVE NUMBER A-2017019282
$\begin{array}{c ccccccccccccccccccccccccccccccccccc$	5.17.23 ED A. YOUNGLOVE, ARCHITECT MOY # A-2017019282 COPYRIGHT 2023 COPYRIGHT 2023 THESE PRINTS ARE THE PROPERTY OF PARAGON CHIEGTURE, LIC AND SHALL BE USED ONLY FOR THE PROJECT REFERENCE BELOW
BUILDING SECTION - E-W @ STAGE	
	ECT ARCHITECT: JAY NBY: TW, TD, KW KED BY: KW, JS, JAY
	TNUMBER:

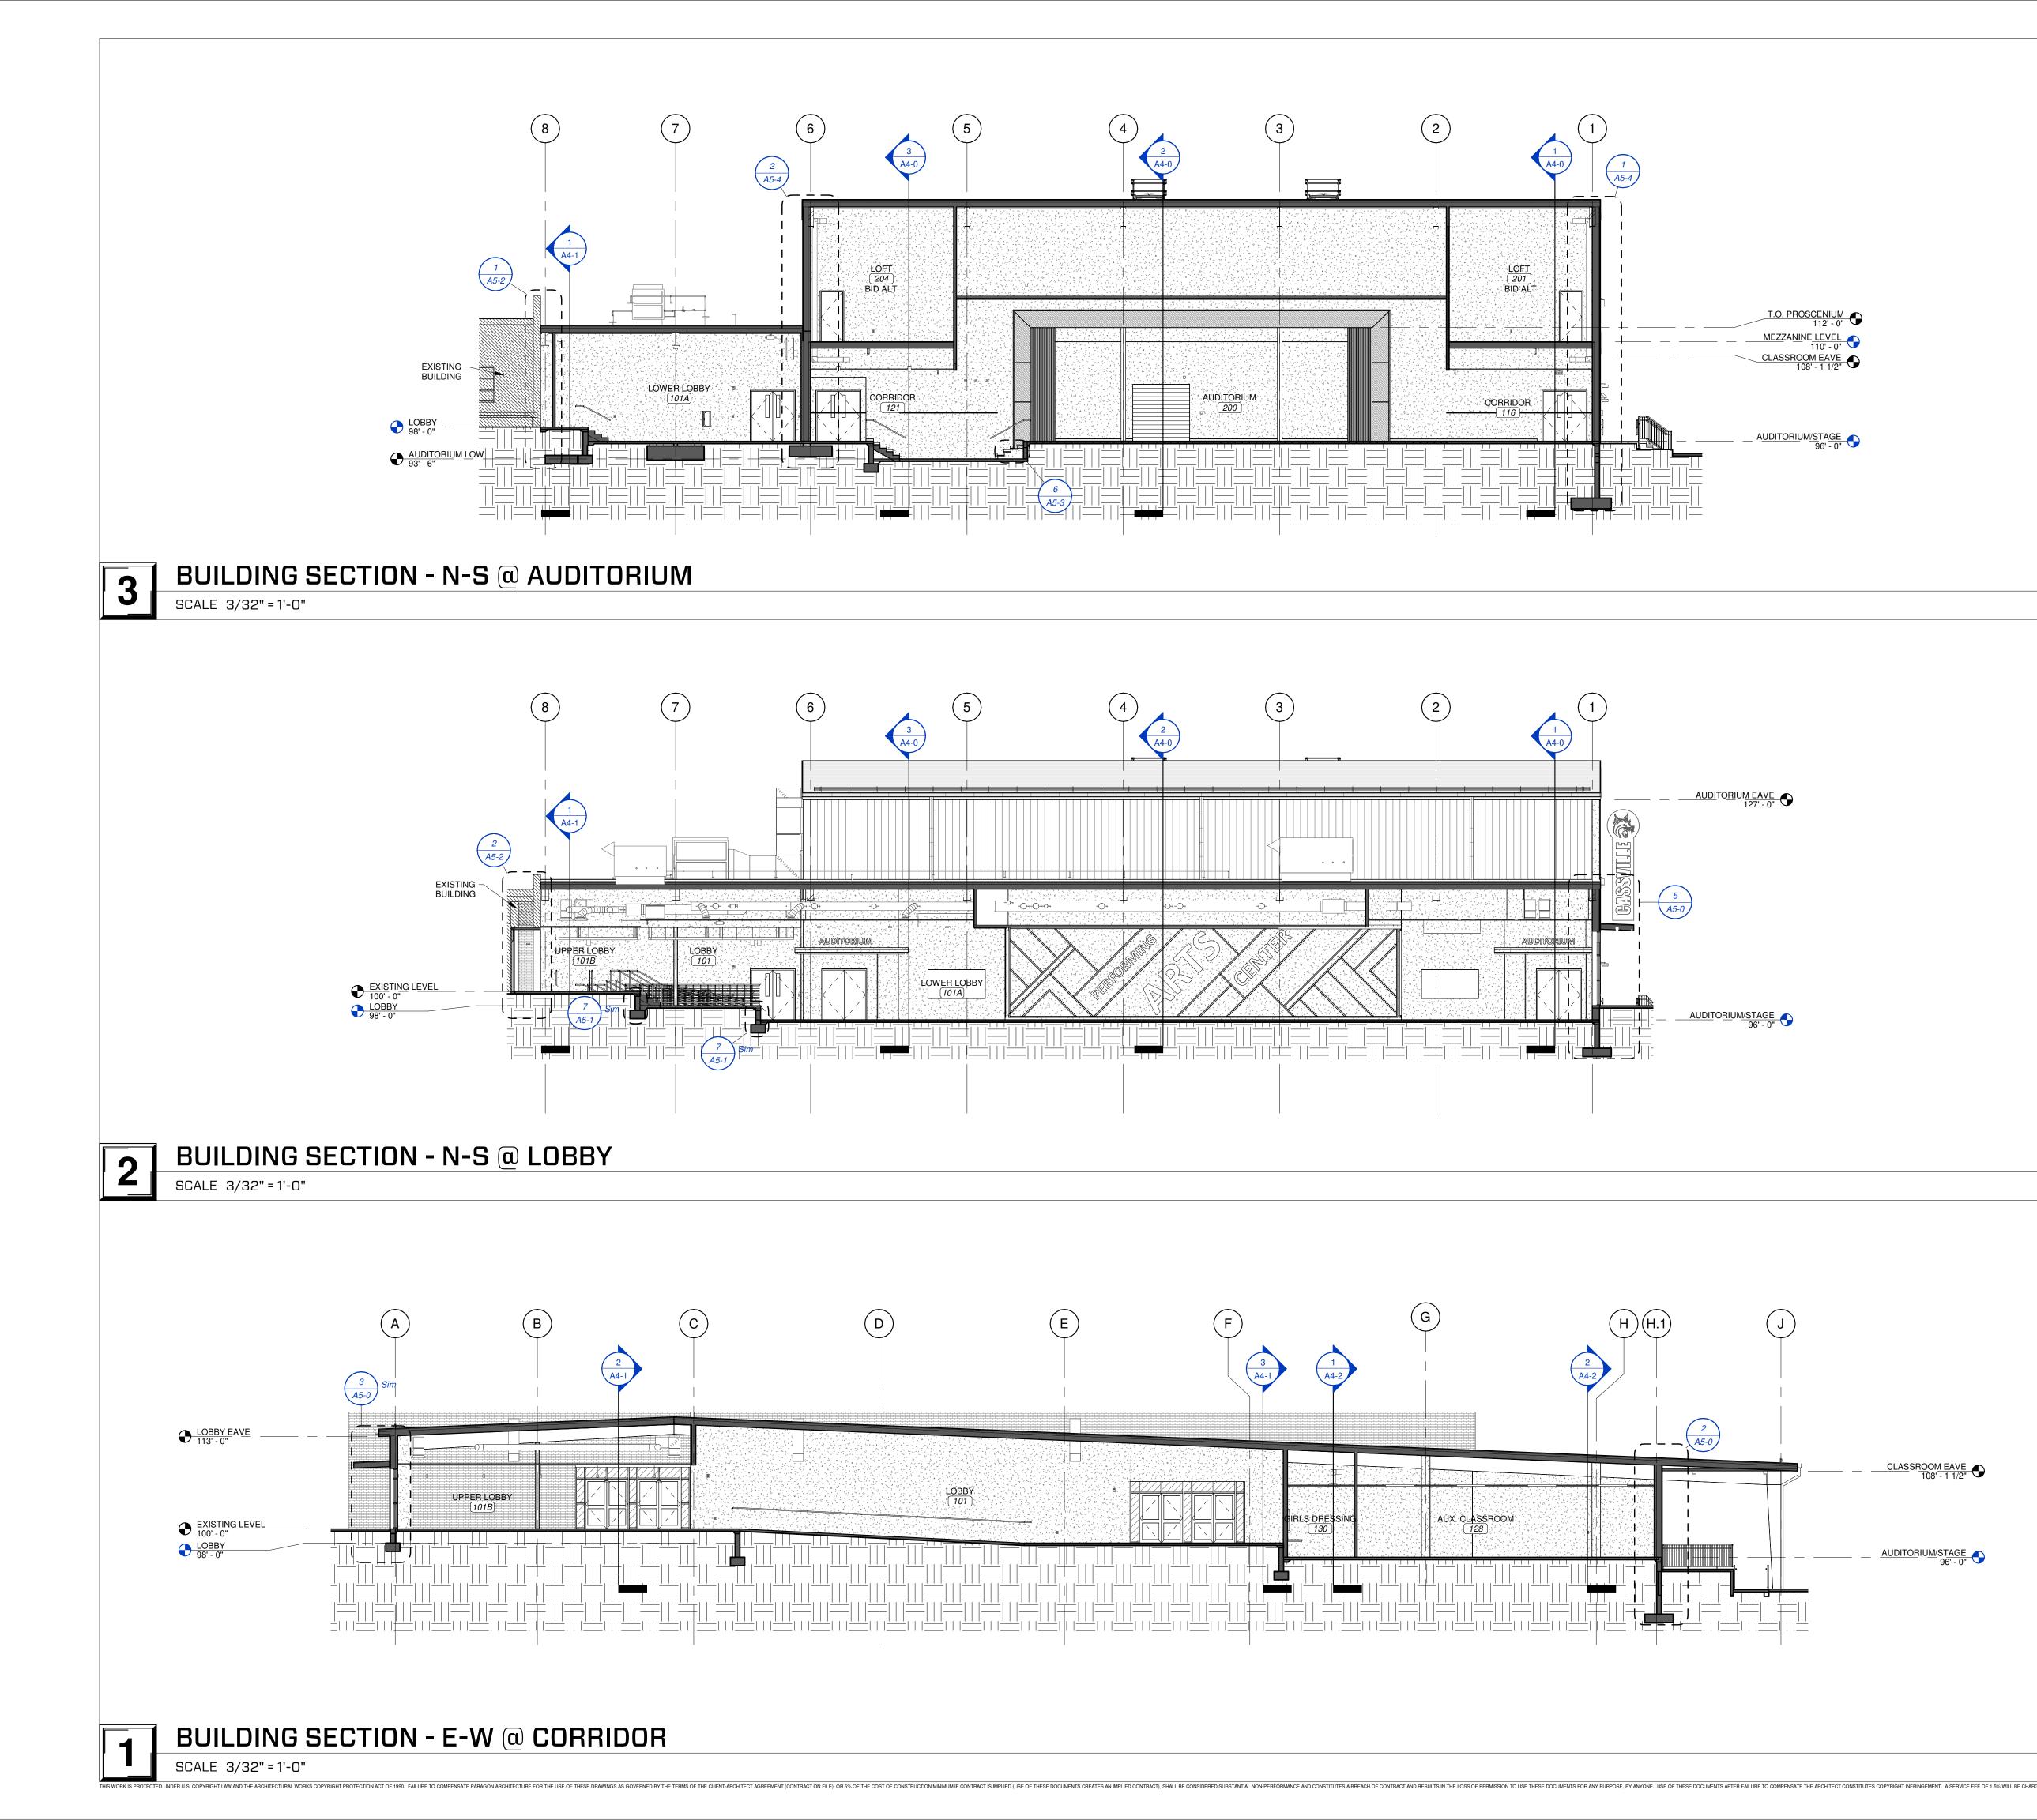



		<image/> <image/> <image/> <text><text><text><text><section-header><section-header><section-header><section-header><section-header><section-header><section-header><section-header><text><text><text><text><text><text><text><text><text></text></text></text></text></text></text></text></text></text></section-header></section-header></section-header></section-header></section-header></section-header></section-header></section-header></text></text></text></text>
		RFORMING ARTS
		PROFECT DESCRIPTION CASSVILLE HS: PERFORMING ARTS CENTER CENTER 1825 STATE HWV Y, CASSVILLE, MO 66625 1825 STATE HWV Y, CASSVILLE, MO 66625
		DRAWN BY: TW, TD, KW CHECKED BY: KW, JS, JAY PROJECT NUMBER: 21-620
		DATE: 2023.05.17 BUILDING
		SECTIONS
GED PER MONTH	ON THE UNPAID BALANCE. THE USER OF THESE DRAWINGS SHALL PAY ALL COSTS OF COLLECTION, INCLUDING ATTORNEY'S FEES.	SHEET NUMBER:

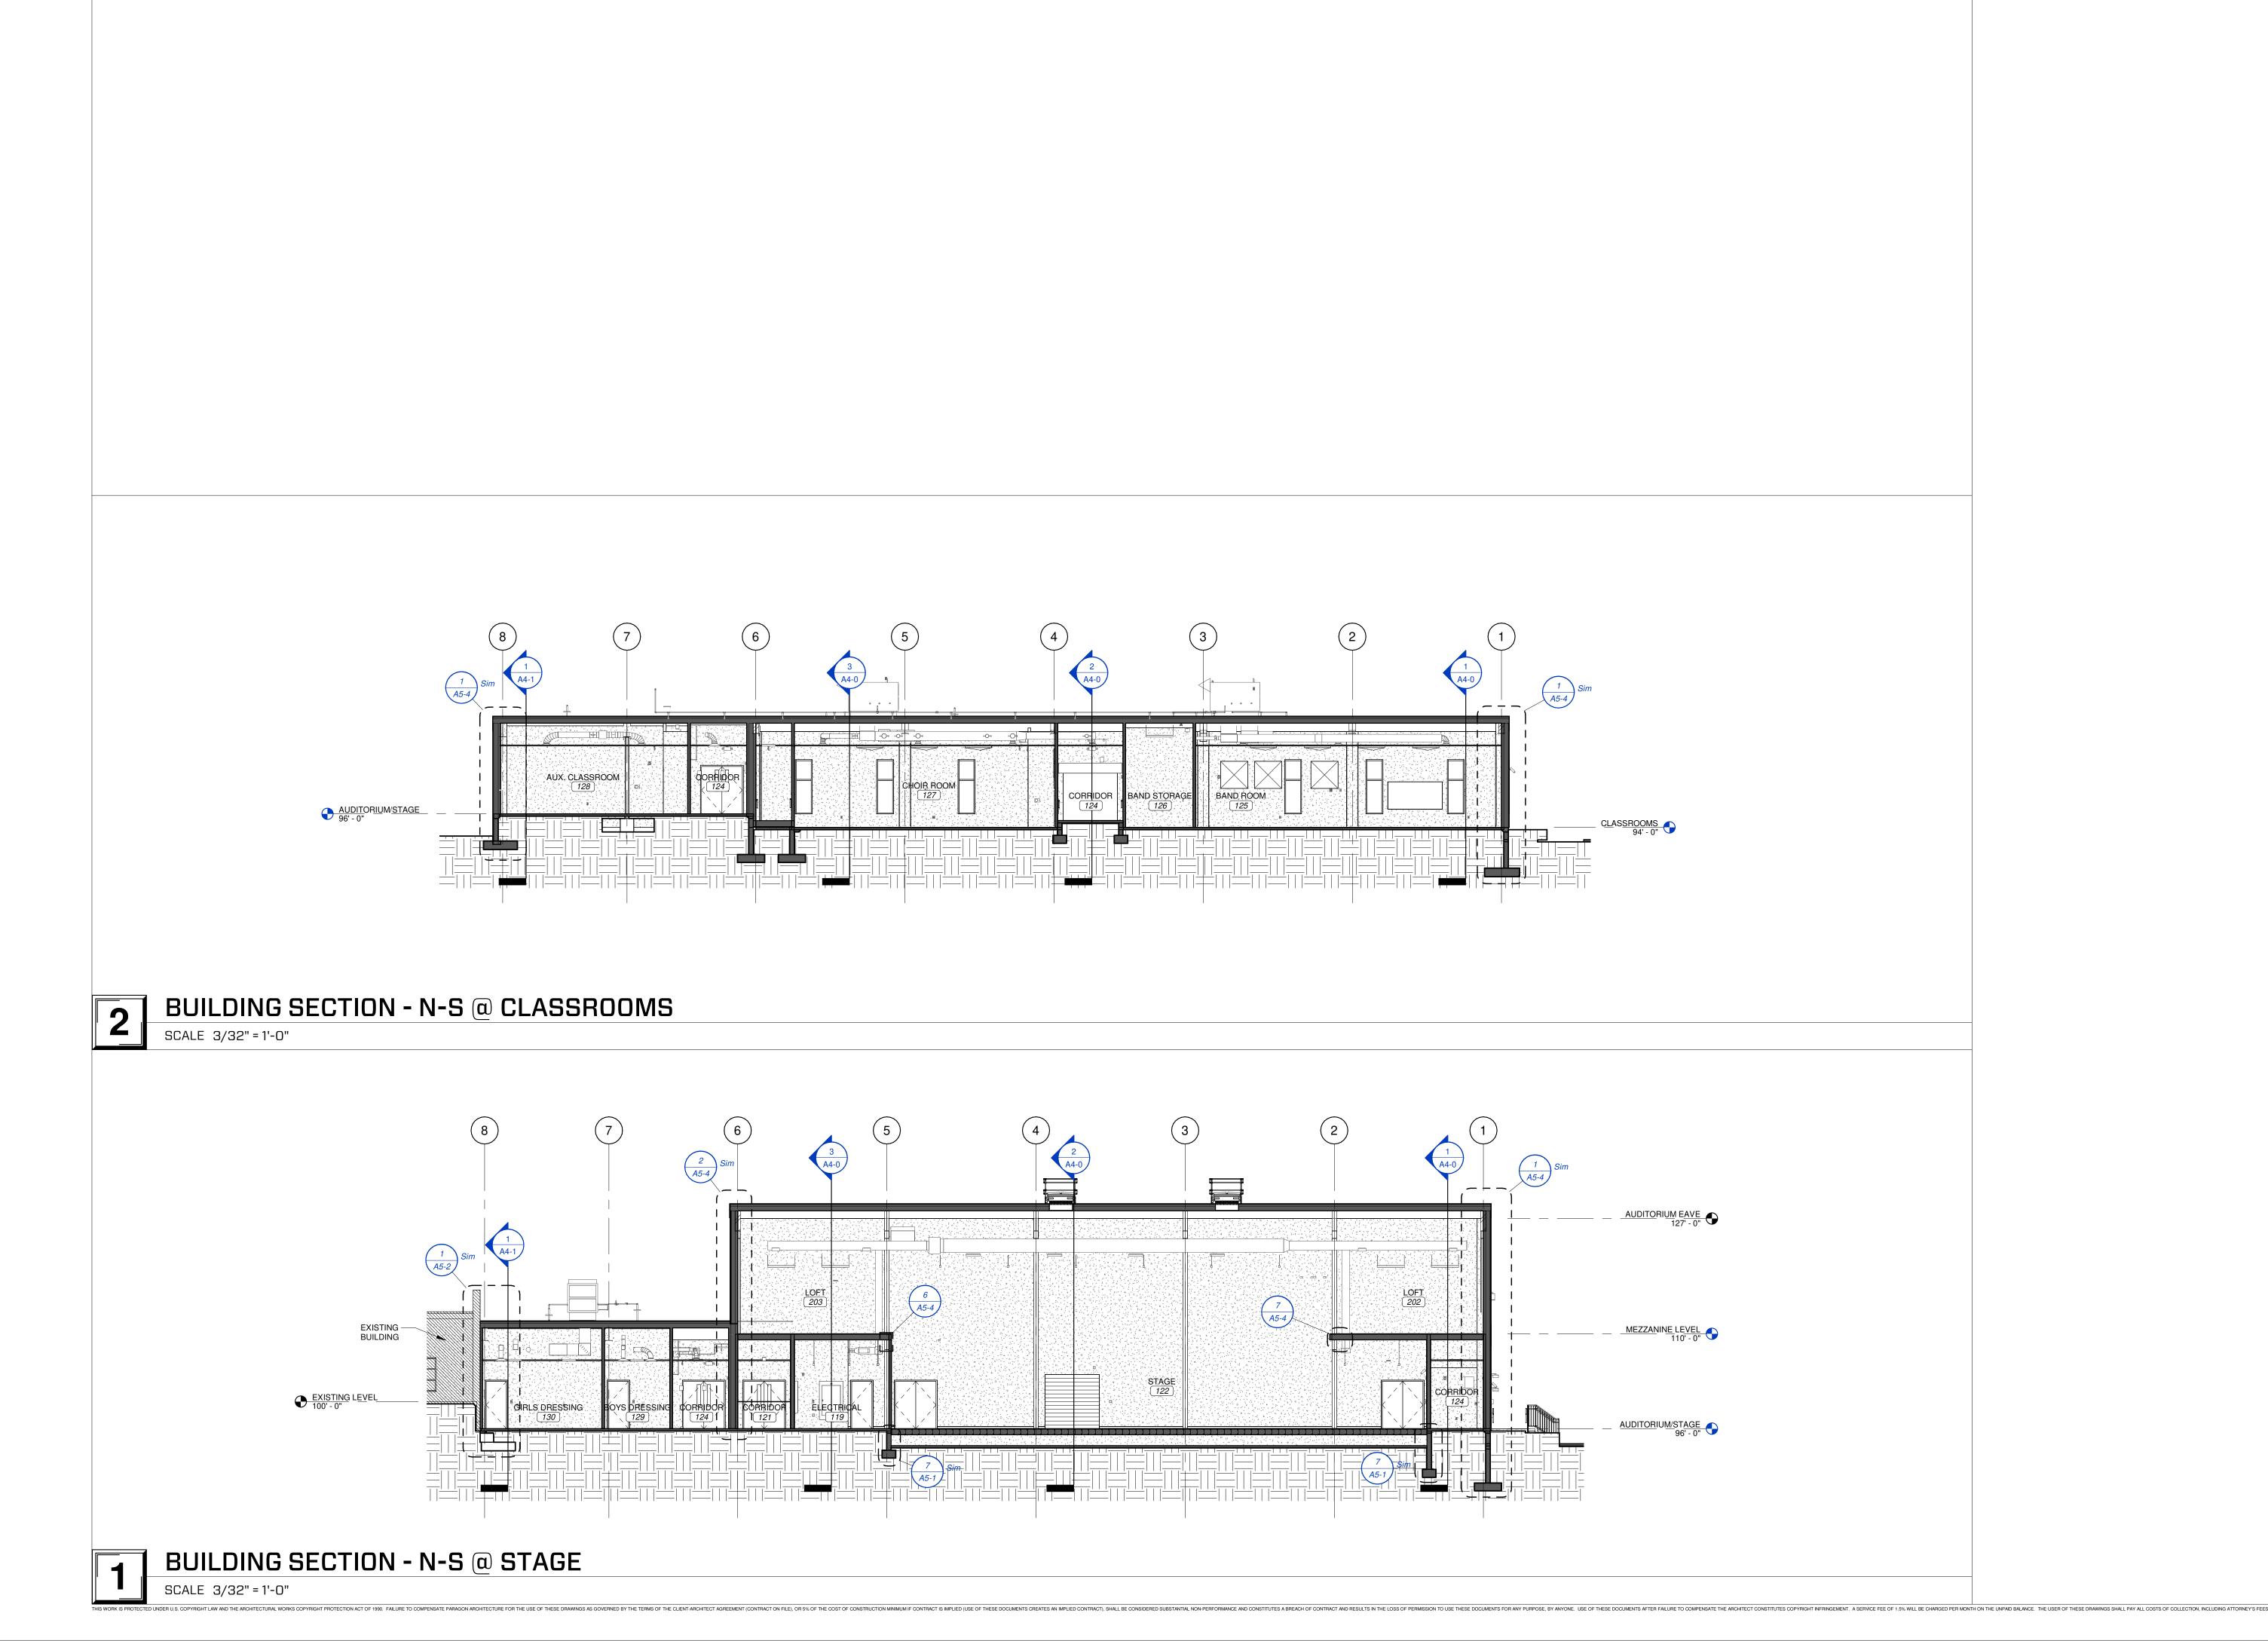

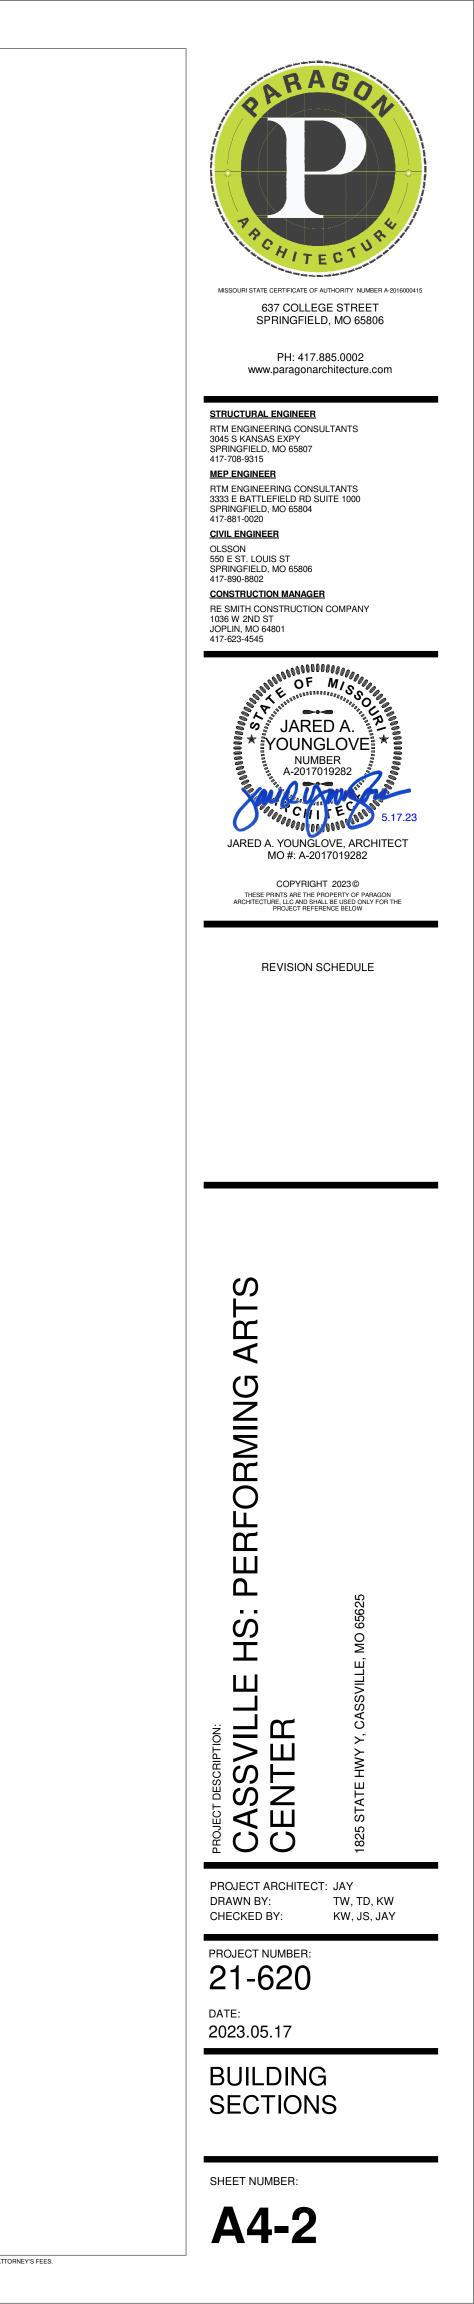


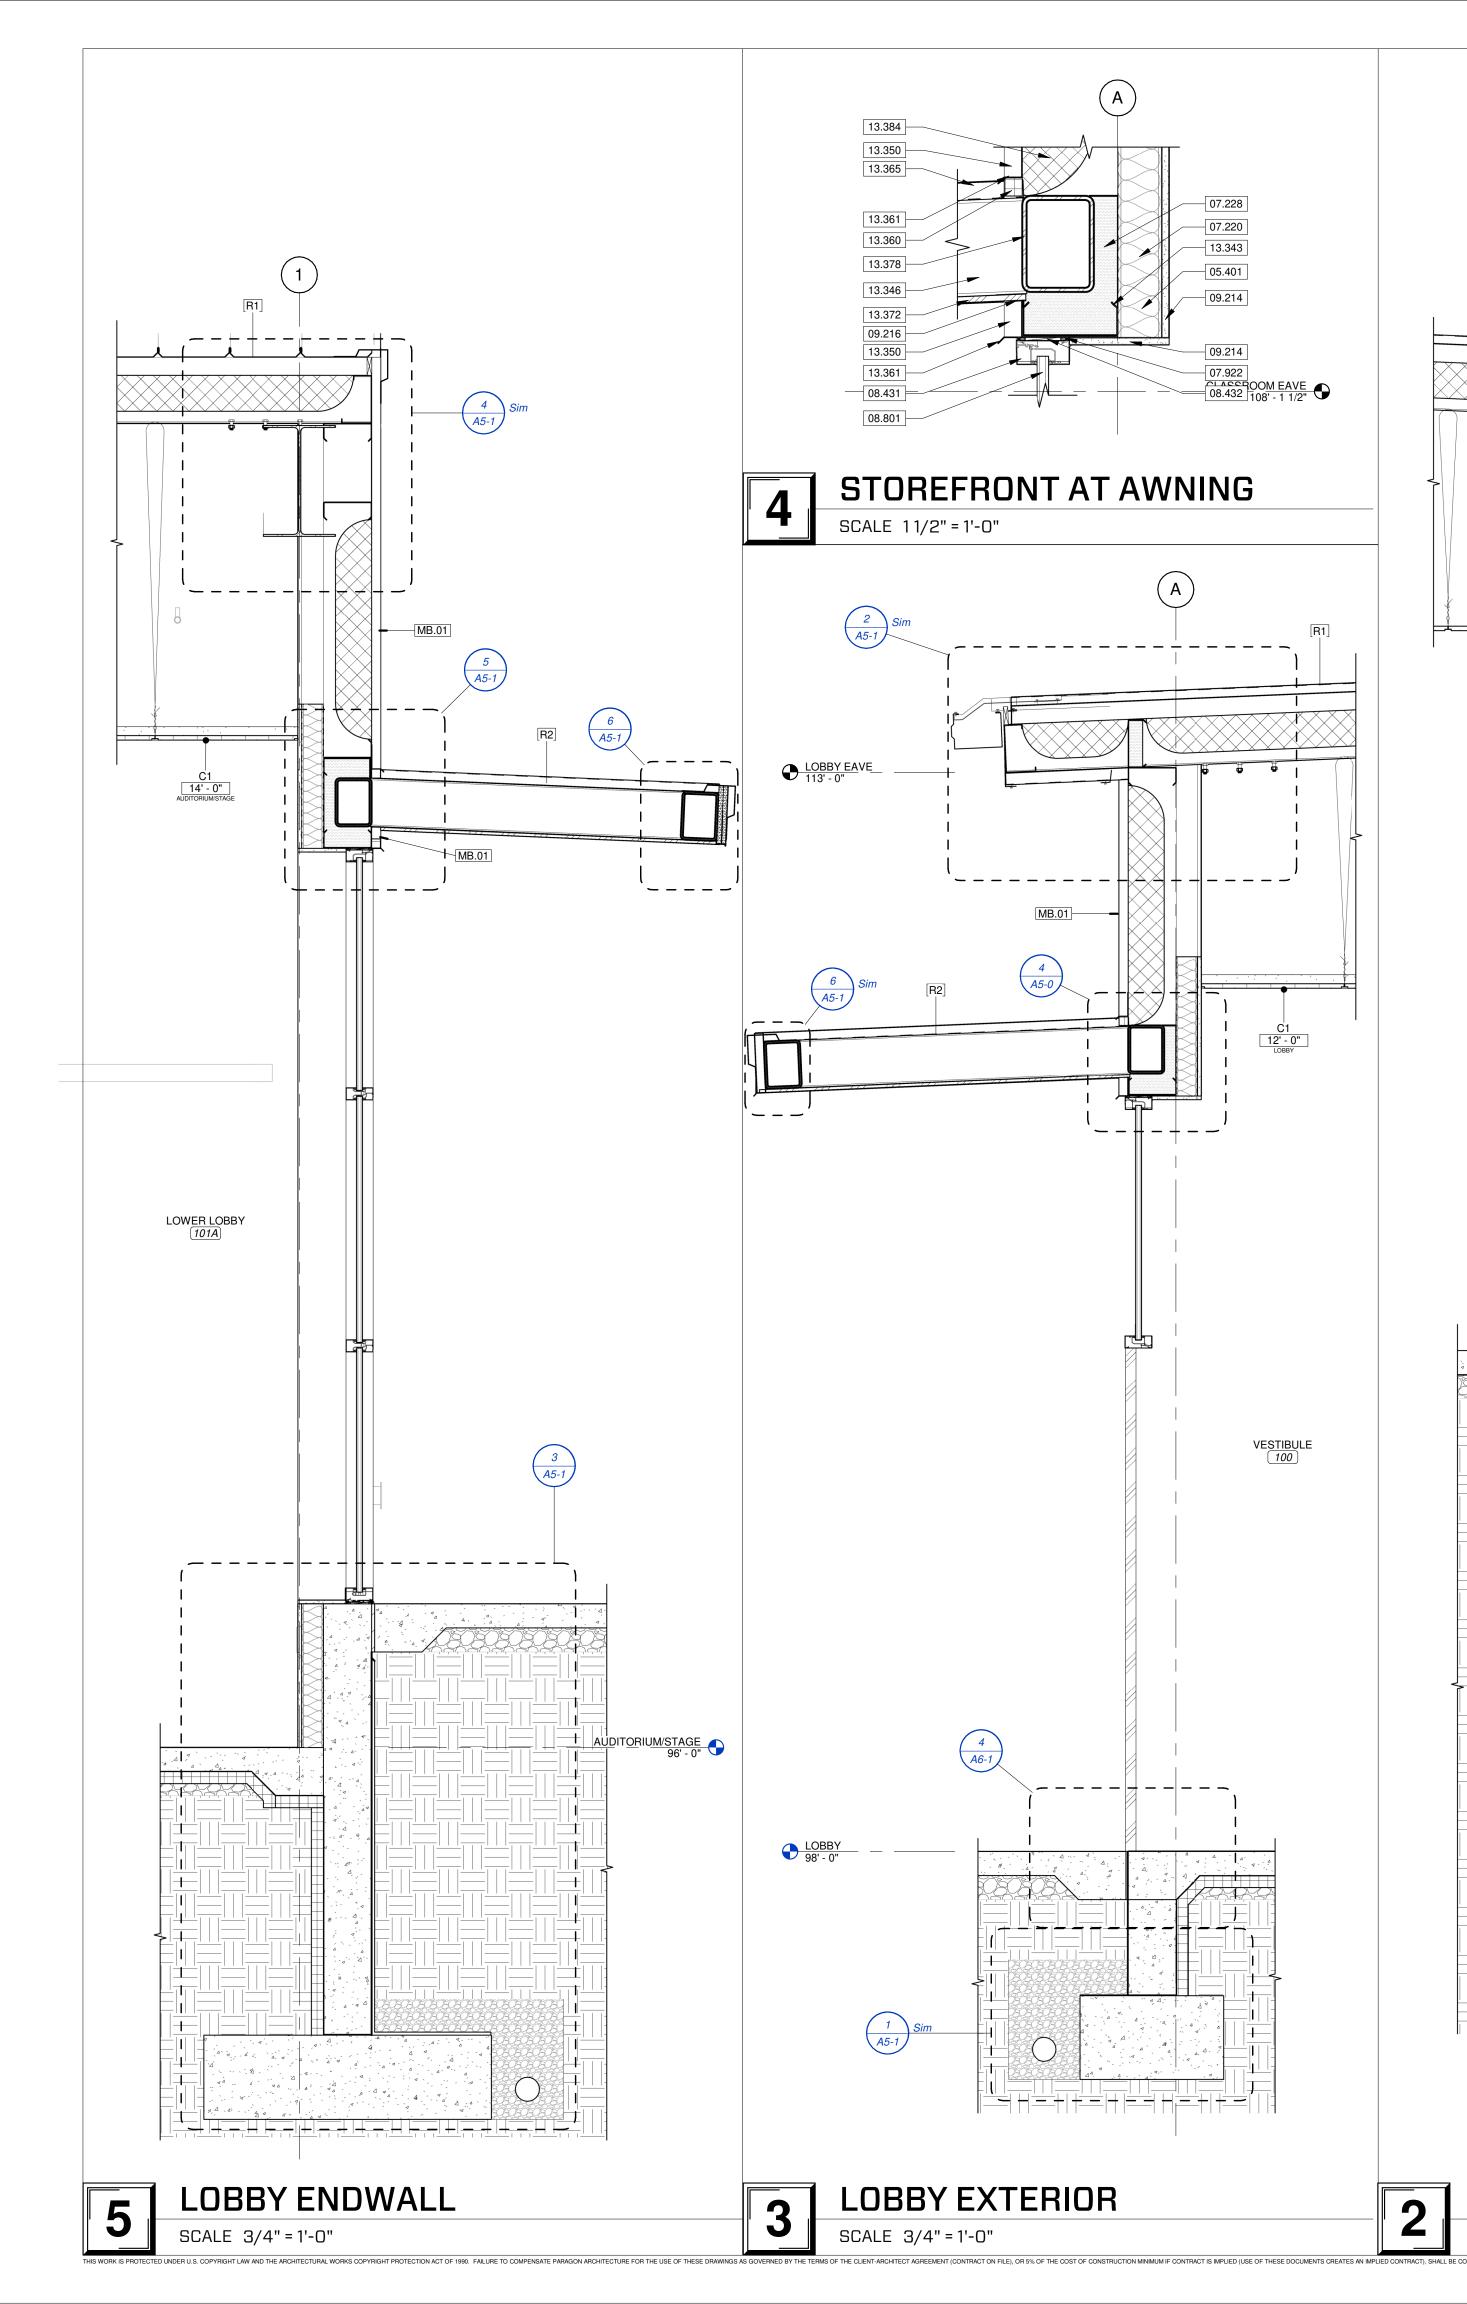

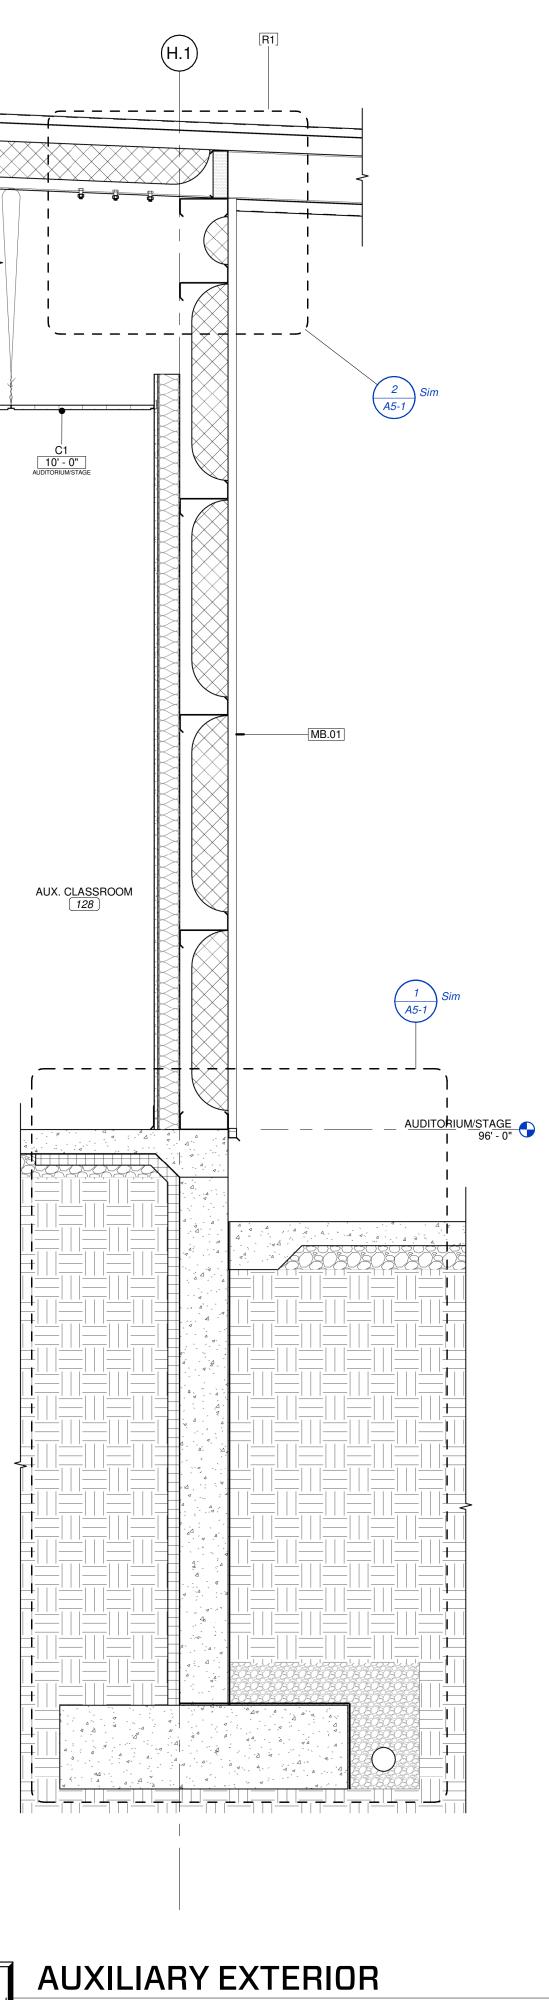

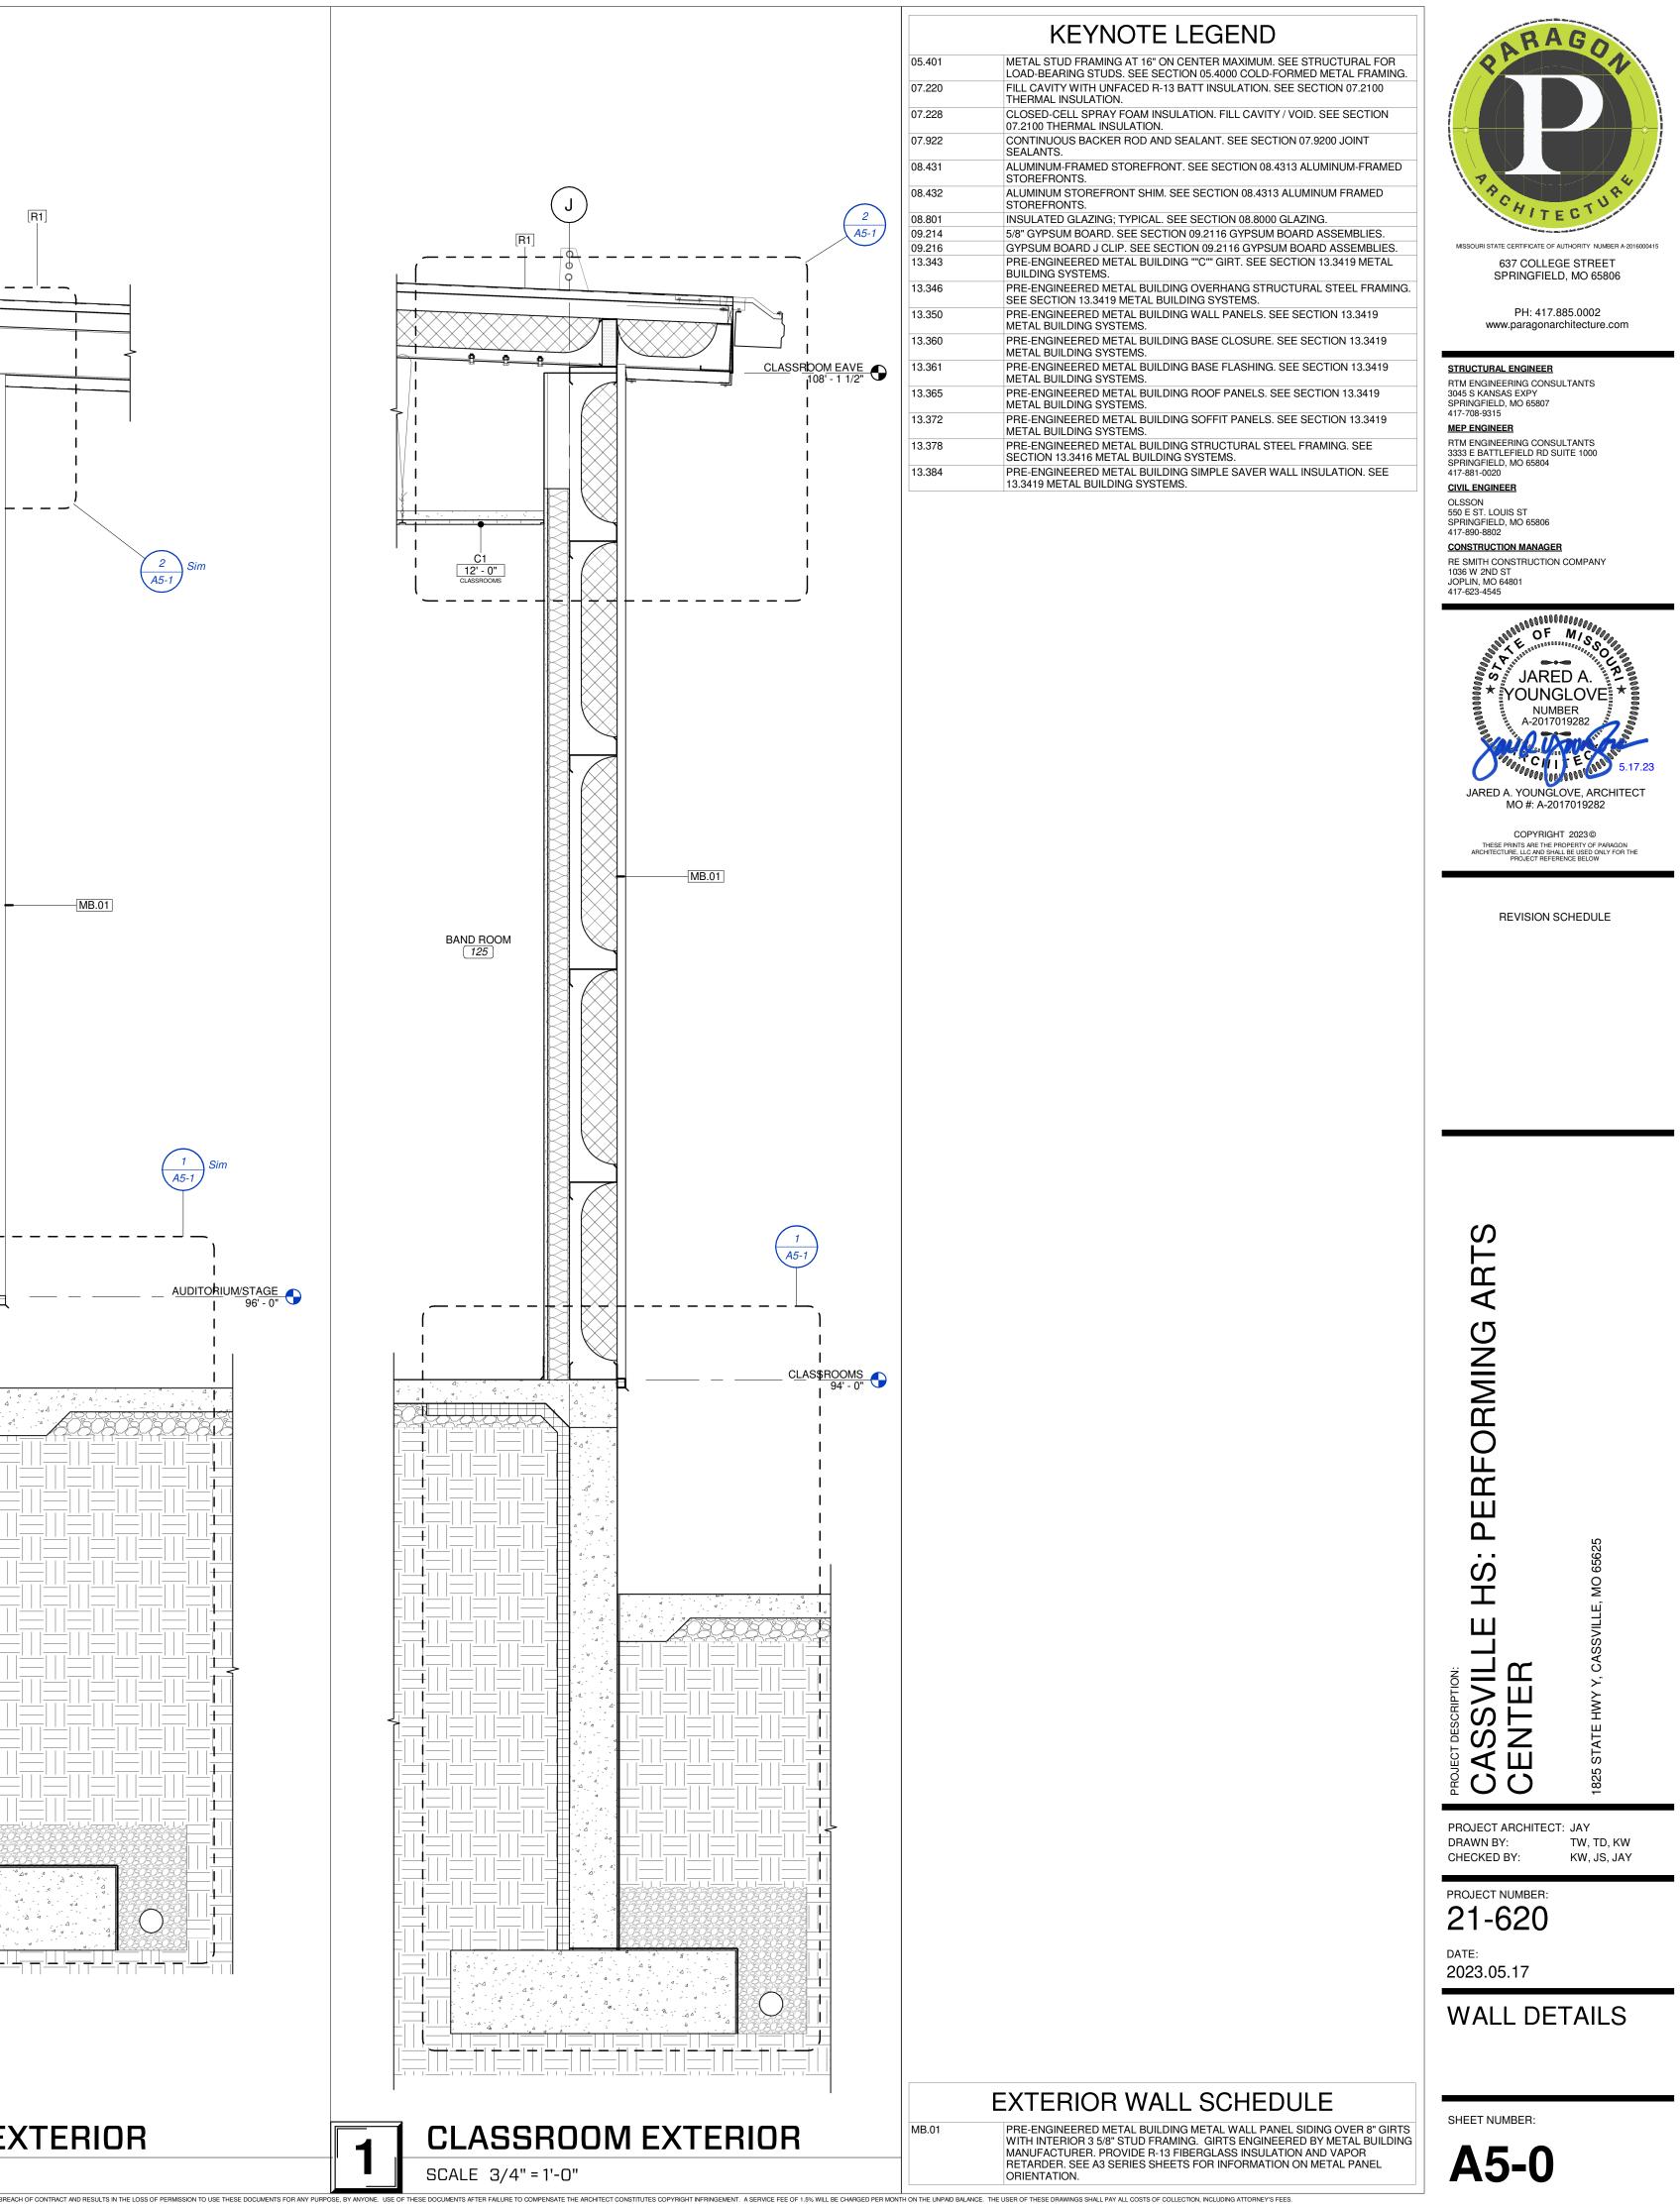

SCALE 3/4" = 1'-0"

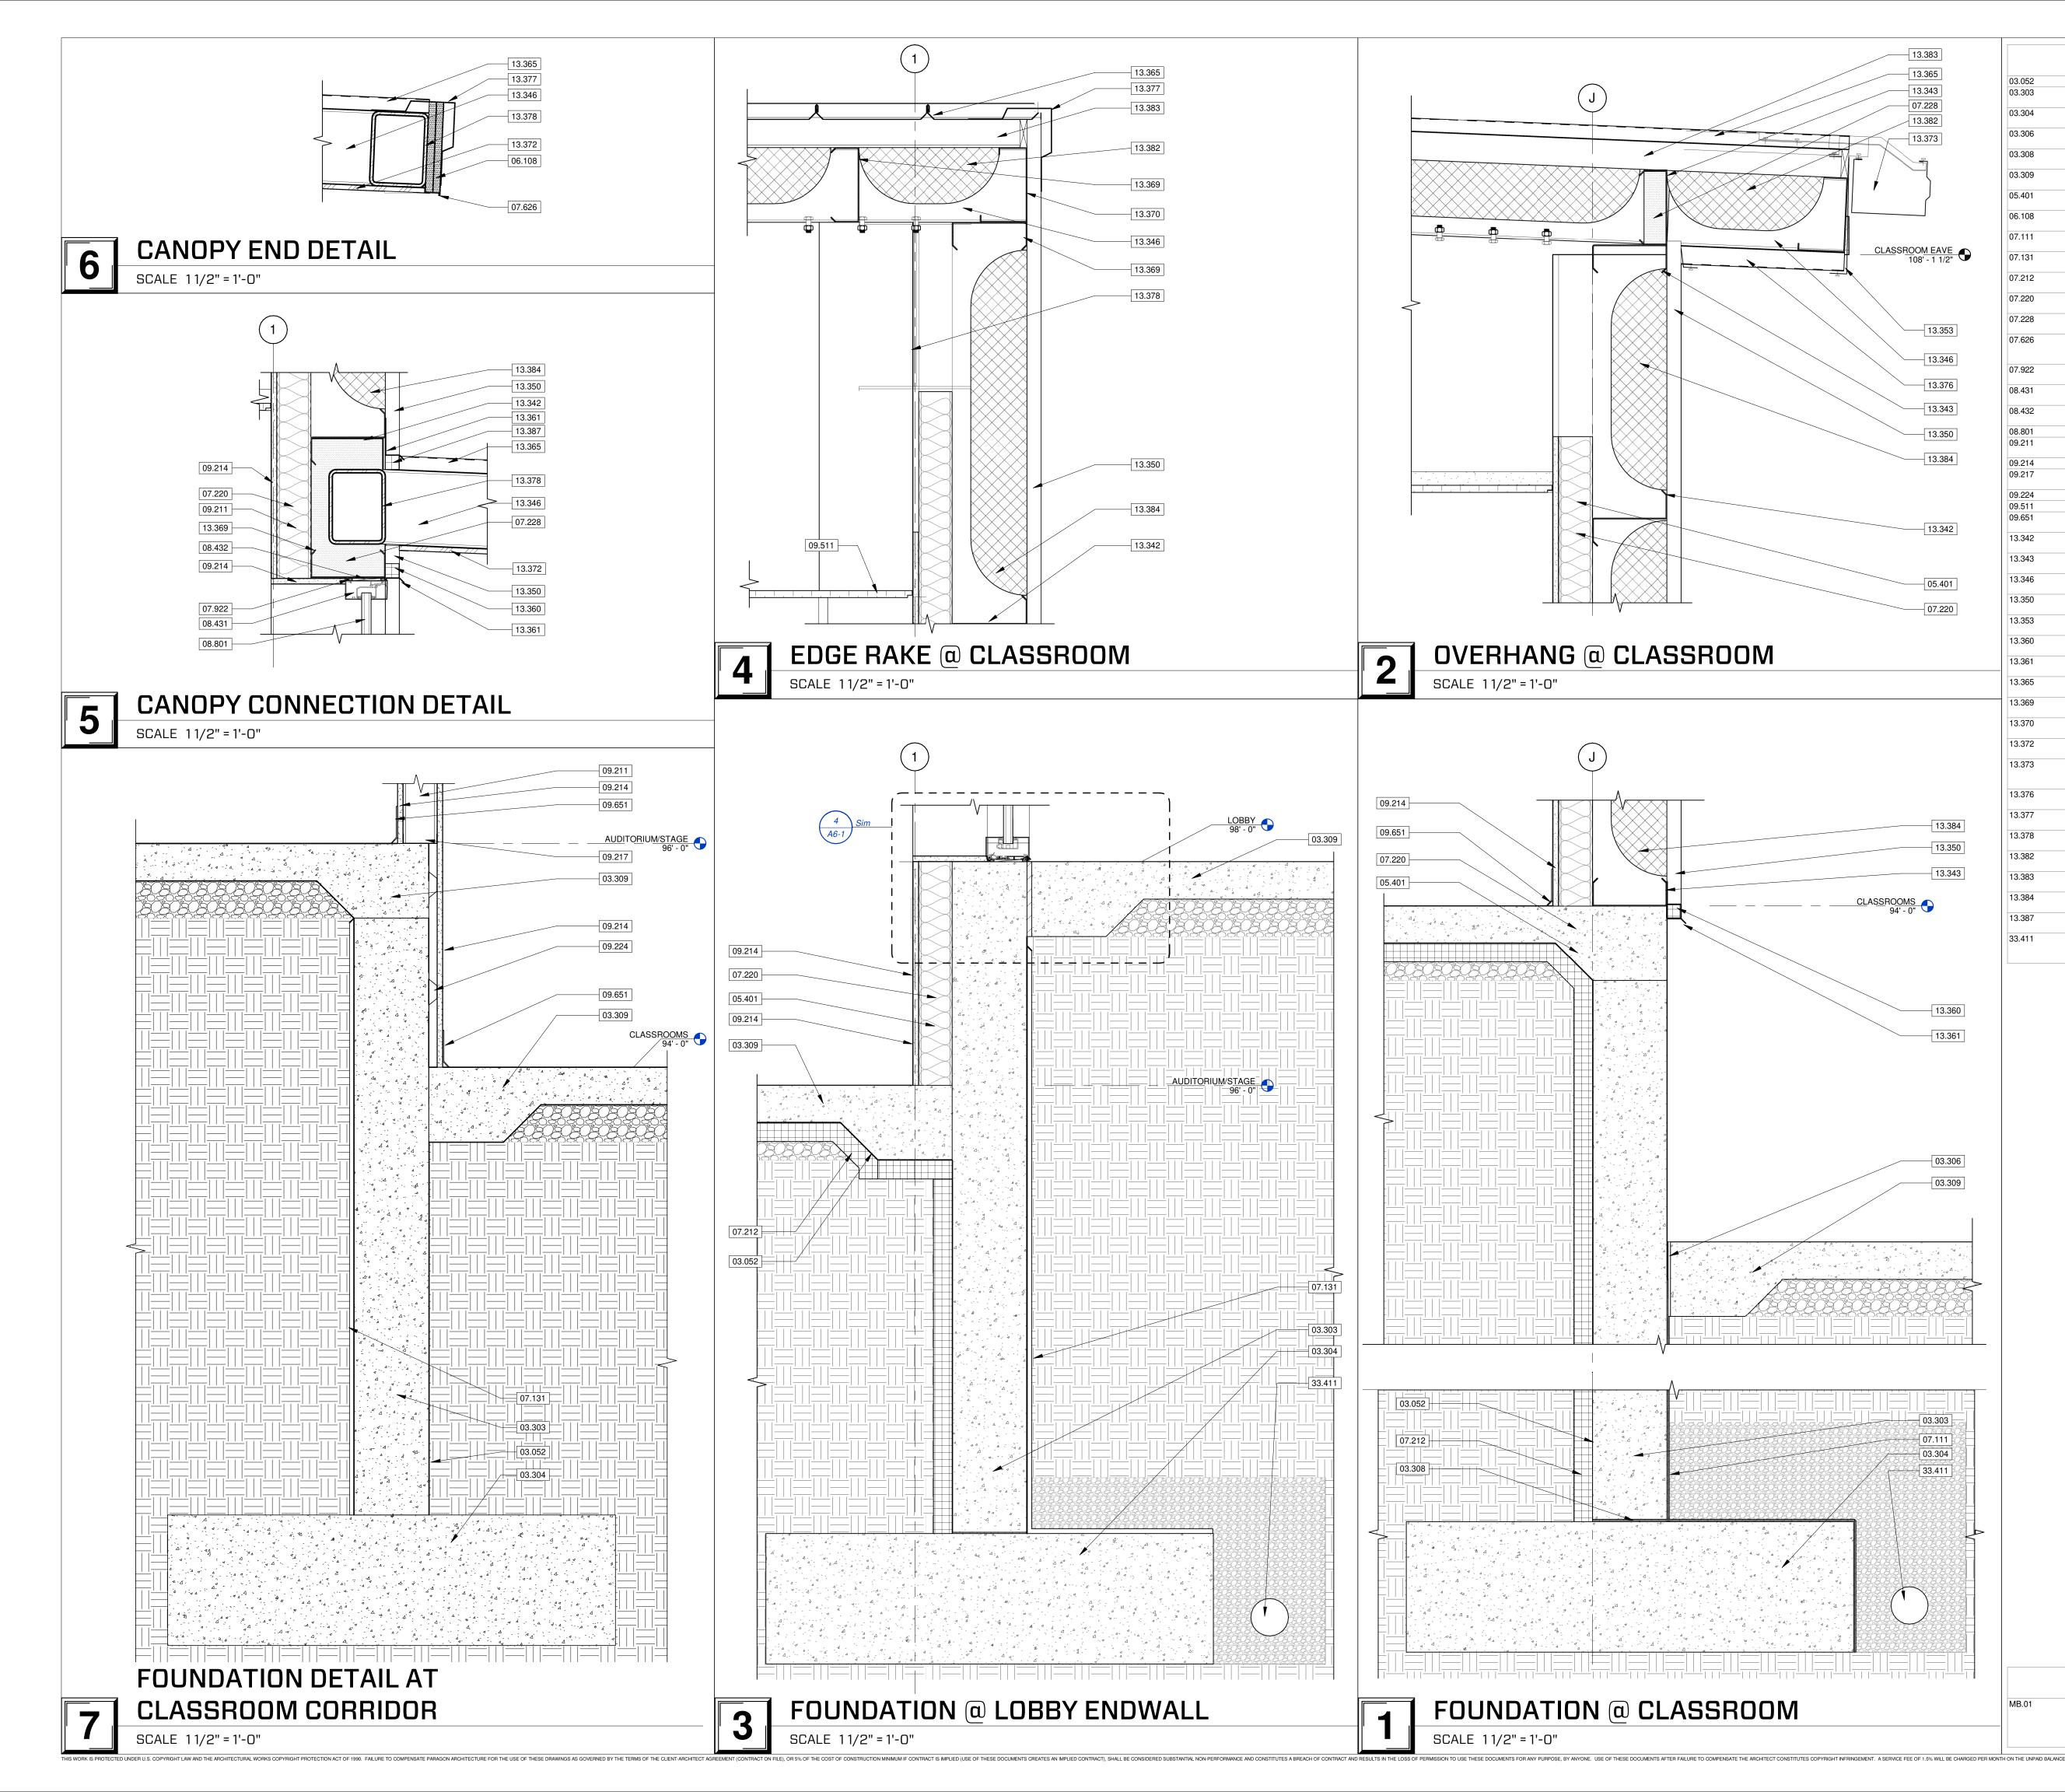

KEYNOTE LEGEND

15 MIL. VAPOR BARRIER. SEE SECTION 03.0516 UNDER SLAB VAPOR BARRIER. CAST-IN-PLACE CONCRETE FOUNDATION WALL. SEE STRUCTURAL. SEE SECTION 03.300 CAST-IN-PLACE CONCRETE. CAST-IN-PLACE CONCRETE FOOTING. SEE STRUCTURAL. SEE SECTION 03.300 CAST-IN-PLACE CONCRETE. 1/2" CONCRETE EXPANSION JOINT FILLER MATERIAL. SEE SECTION 03.300 CAST-IN-PLACE CONCRETE. PROVIDE DAMPPROOFING OR CAPILLARY BREAK OVER FOOTING. SEE SECTION 03.300 CAST-IN-PLACE CONCRETE. CAST-IN-PLACE CONCRETE SIDEWALK. SEE CIVIL. SEE SECTION 03.3000 CAST-IN-PLACE CONCRETE METAL STUD FRAMING AT 16" ON CENTER MAXIMUM. SEE STRUCTURAL FOR LOAD-BEARING STUDS. SEE SECTION 05.4000 COLD-FORMED METAL FRAMING. FIRE RETARDANT PLYWOOD SHEATHING. SEE STRUCTURAL. SEE SECTION 06.1000 ROUGH CARPENTRY. BITUMINOUS DAMPPROOFING AND MOLDED DRAINAGE PANELS. SEE SECTION 07.1113 BITUMINOUS DAMPPROOFING. SELF-ADHERED SHEET WATERPROOFING AND MOLDED SHEET DRAINAGE PANELS. SEE SECTION 07.1300 SHEET WATERPROOFING. 2" RIGID INSULATION AT BUILDING PERIMETER. RETURN MINIMUM 24" UNDER CONCRETE SLAB. SEE SECTION 07.2100 THERMAL INSULATION. FILL CAVITY WITH UNFACED R-13 BATT INSULATION. SEE SECTION 07.2100 THERMAL INSULATION. CLOSED-CELL SPRAY FOAM INSULATION. FILL CAVITY / VOID. SEE SECTION 07.2100 THERMAL INSULATION. PREFINISHED METAL FASCIA WITH DRIP EDGE. PROVIDE MIN. 4" OVERLAP AT ENDS WITH CONTINUOUS SEALANT AT LAPS. SEE SECTION 07.6200 SHEET METAL FLASHING AND TRIM. CONTINUOUS BACKER ROD AND SEALANT. SEE SECTION 07.9200 JOINT SEALANTS. ALUMINUM-FRAMED STOREFRONT. SEE SECTION 08.4313 ALUMINUM-FRAMED STOREFRONTS. ALUMINUM STOREFRONT SHIM. SEE SECTION 08.4313 ALUMINUM FRAMED STOREFRONTS. INSULATED GLAZING; TYPICAL. SEE SECTION 08.8000 GLAZING. 3-5/8" METAL STUD FRAMING AT 16" ON CENTER MAXIMUM. SEE SECTION 09.2116 GYPSUM BOARD ASSEMBLIES. 5/8" GYPSUM BOARD. SEE SECTION 09.2116 GYPSUM BOARD ASSEMBLIES. METAL STUD RUNNER CHANNEL. SEE SECTION 09.2116 GYPSUM BOARD ASSEMBLIES. 7/8" HAT CHANNEL. SEE SECTION 09.2116 GYPSUM BOARD ASSEMBLES. ACOUSTICAL TILE CEILING. SEE SECTION 09.5100 ACOUSTICAL CEILINGS. RESILIENT VINYL BASE. SEE FINISH SCHEDULE AND FINISH PLANS FOR MORE INFORMATION. SEE SECTION 09.6500 RESILIENT FLOORING. PRE-ENGINEERED METAL BUILDING Z-GIRT. SEE SECTION 13.3419 METAL BUILDING SYSTEMS. PRE-ENGINEERED METAL BUILDING ""C"" GIRT. SEE SECTION 13.3419 METAL BUILDING SYSTEMS. PRE-ENGINEERED METAL BUILDING OVERHANG STRUCTURAL STEEL FRAMING. SEE SECTION 13.3419 METAL BUILDING SYSTEMS. PRE-ENGINEERED METAL BUILDING WALL PANELS. SEE SECTION 13.3419 METAL BUILDING SYSTEMS PRE-ENGINEERED METAL BUILDING SOFFIT PANEL TRIM. SEE SECTION 13.3419 METAL BUILDING SYSTEMS PRE-ENGINEERED METAL BUILDING BASE CLOSURE. SEE SECTION 13.3419 METAL BUILDING SYSTEMS PRE-ENGINEERED METAL BUILDING BASE FLASHING. SEE SECTION 13.3419 METAL BUILDING SYSTEMS PRE-ENGINEERED METAL BUILDING ROOF PANELS. SEE SECTION 13.3419 METAL BUILDING SYSTEMS PRE-ENGINEERED METAL BUILDING EAVE TRIM. SEE SECTION 13.3419 METAL BUILDING SYSTEMS. PRE-ENGINEERED METAL BUILDING EAVE STRUT. SEE SECTION 13.3419 METAL BUILDING SYSTEMS PRE-ENGINEERED METAL BUILDING SOFFIT PANELS. SEE SECTION 13.3419 METAL BUILDING SYSTEMS. PRE-ENGINEERED METAL BUILDING 7"X7" METAL GUTTER PER MANUFACTURER'S STANDARD DETAILS. SEE SECTION 13.3419 METAL BUILDING SYSTEMS PRE-ENGINEERED METAL BUILDING SOFFIT PANELS. SEE SECTION 13.3419 METAL BUILDING SYSTEMS. PRE-ENGINEERED METAL BUILDING RAKE TRIM. SEE SECTION 13.3419 METAL BUILDING SYSTEMS. PRE-ENGINEERED METAL BUILDING STRUCTURAL STEEL FRAMING. SEE SECTION 13.3416 METAL BUILDING SYSTEMS. PRE-ENGINEERED METAL BUILDING SIMPLE SAVER LOWER LAYER ROOF INSULATION. SEE 13.3419 METAL BUILDING SYSTEMS. PRE-ENGINEERED METAL BUILDING SIMPLE SAVER UPPER LAYER ROOF INSULATION. SEE 13.3419 METAL BUILDING SYSTEMS. PRE-ENGINEERED METAL BUILDING SIMPLE SAVER WALL INSULATION. SEE 13.3419 METAL BUILDING SYSTEMS. PRE-ENGINEERED METAL BUILDING METAL WALL PANEL CLOSURE. SEE SECTION 13.3419 METAL BUILDING SYSTEMS. 4" DIAMETER PERFORATED FOUNDATION SUBDRAINAGE. ENCASE IN GRANULAR FILL AND WRAP IN GEOTEXTILE FABRIC. COORDINATE WITH CIVIL

ENGINEERING DRAWINGS. SEE SECTION 33.4100 SUBDRAINAGE.



MISSOURI STATE CERTIFICATE OF AUTHORITY NUMBER A-2016000 637 COLLEGE STREET SPRINGFIELD, MO 65806

> PH: 417.885.0002 www.paragonarchitecture.com

STRUCTURAL ENGINEER RTM ENGINEERING CONSULTANTS 3045 S KANSAS EXPY SPRINGFIELD, MO 65807 417-708-9315 MEP ENGINEER RTM ENGINEERING CONSULTANTS 3333 E BATTLEFIELD RD SUITE 1000 SPRINGFIELD, MO 65804 417-881-0020 CIVIL ENGINEER OLSSON 550 E ST. LOUIS ST SPRINGFIELD, MO 65806 417-890-8802 CONSTRUCTION MANAGER RE SMITH CONSTRUCTION COMPANY 1036 W 2ND ST JOPLIN, MO 64801 417-623-4545



COPYRIGHT 2023© HESE PRINTS ARE THE PROPERTY OF PARAGON HTECTURE, LLC AND SHALL BE USED ONLY FOR THE PROJECT REFERENCE BELOW

REVISION SCHEDULE

ARTS

ORMING

Е

<u>с</u>

НS

Ш

CASSVILLE CENTER

PROJECT ARCHITECT: JAY

WALL DETAILS

TW, TD, KW

KW, JS, JAY

DRAWN BY:

DATE:

CHECKED BY:


PROJECT NUMBER: 21-620

2023.05.17




PRE-ENGINEERED METAL BUILDING METAL WALL PANEL SIDING OVER 8" GIRTS WITH INTERIOR 3 5/8" STUD FRAMING. GIRTS ENGINEERED BY METAL BUILDING MANUFACTURER. PROVIDE R-13 FIBERGLASS INSULATION AND VAPOR RETARDER. SEE A3 SERIES SHEETS FOR INFORMATION ON METAL PANEL ORIENTATION. SHEET NUMBER


A5-1

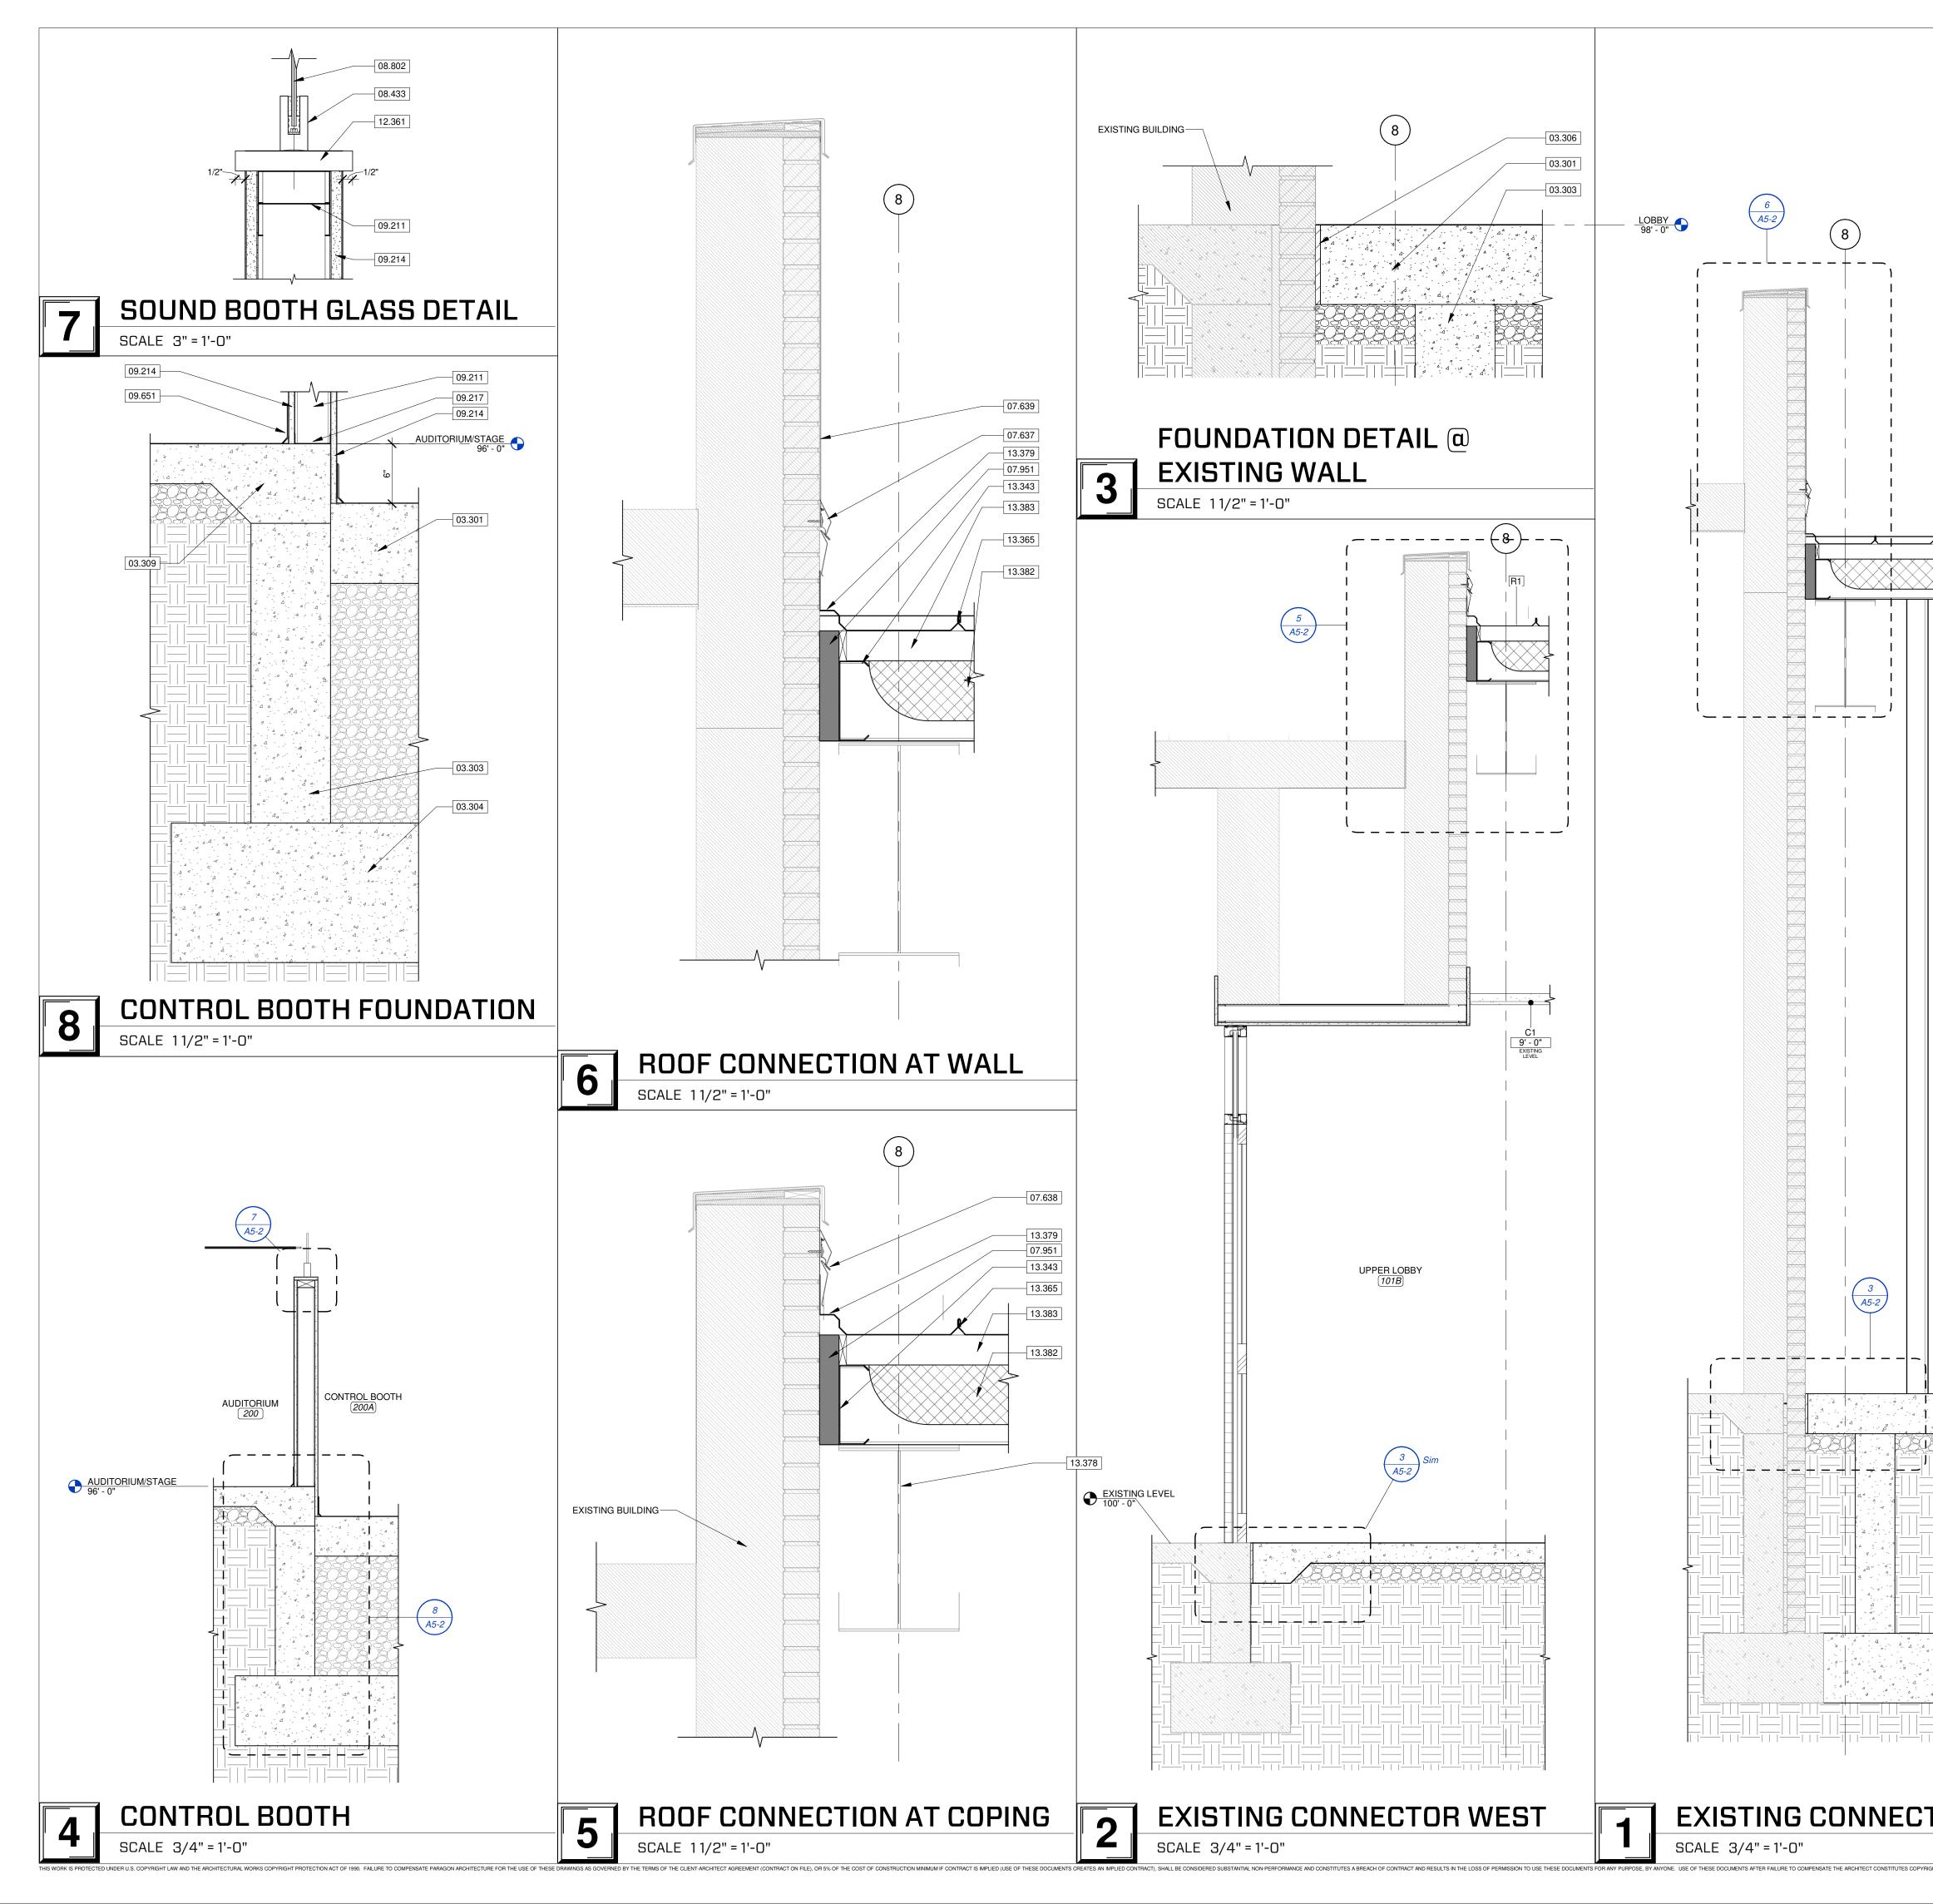

			STAR SUMPORE SUBJECT ARCHITECT: DRAWN BY: CHECKED BY: PROJECT ARCHITECT: DRAWN BY: CHECKED BY: PROJECT NUMBER: 21-6200 DATE: 2023.05.17	TW, TD, KW KW, JS, JAY
03.301 03.303 03.304 03.306 03.309 07.637 07.637 07.639 07.951 08.433 08.802 09.211 09.214 09.217 09.651 12.361 13.343 13.378 13.379 13.382 13.383	KEEYNOTE LEG REINFORCED CONCRETE SLAB. SEE STRUC CAST-IN-PLACE CONCRETE FOUNDATION VI SECTION 03.300 CAST-IN-PLACE CONCRETE CAST-IN-PLACE CONCRETE FOUNDATION VI SECTION 03.300 CAST-IN-PLACE CONCRETE I/2" CONCRETE EXPANSION JOINT FILLER N CAST-IN-PLACE CONCRETE. METAL REGLET AND COUNTER FLASHING. SE FLASHING AND TRIM PRE-FINISHED METAL FLASHING. SEE SECT FLASHING AND TRIM PRE-FINISHED METAL FLASHING. SEE SECTION 07.6200 SHEET 2" EXPANSION JOINT. SEE SECTION 07.6200 SHEET 2" EXPANSION JOINT. SEE SECTION 07.6200 SHEET 2" EXPANSION JOINT. SEE SECTION 07.6200 SHEET 3-56" METAL STUD FRAMING AT 16" ON CEN 09.2116 GYPSUM BOARD ASSEMBLIES. 5.8" GYPSUM BOARD. SEE SECTION 09.2116 METAL STUD RUNNER CHANNEL. SEE SECT ASSEMBLIES. RESILENT VINYL BASE. SEE FINISH SCHEDI INFORMATION. SEE SECTION 09.6500 RESIL QUARTZ COUNTERTOP. SEE FINISH SCHEDI INFORMATION. SEE SECTION 09.6500 RESIL QUARTZ COUNTERTOP. SEE FINISH SCHEDI INFORMATION. SEE SECTION 09.6500 RESIL QUARTZ COUNTERTOP. SEE FINISH LEGEN COUNTERTOPS. PRE-ENGINEERED METAL BUILDING "C"" GI BUILDING SYSTEMS. PRE-ENGINEERED METAL BUILDING SYSTEM PRE-ENGINEERED METAL BU	ALL. SEE SECTION 03.300 ALL. SEE STRUCTURAL. SEE STRUCTURAL. SEE SECTION 03.300 ATERIAL. SEE SECTION 03.300 CIVIL. SEE SECTION 03.3000 SEE SECTION 07.6200 SHEET METAL ION 07.6200 SHEET METAL ION 07.6200 SHEET METAL IN UNDER EXISTING COPING CAP METAL FLASHING AND TRIM. EXPANSION JOINT COVER RED BASE SHOW WITH CRL M-FRAMED STOREFRONTS. GTION 08.8000 GLAZING. ITER MAXIMUM. SEE SECTION GYPSUM BOARD ASSEMBLIES. ION 09.2116 GYPSUM BOARD JLE AND FINISH PLANS FOR MORE IENT FLOORING. D AND SECTION 12.3600 RT. SEE SECTION 13.3419 METAL PANELS. SEE SECTION 13.3419 TURAL STEEL FRAMING. SEE S. ASSE FLASHING WITH RIVET. SEE S. SAVER LOWER LAYER ROOF SYSTEMS. SAVER UPPER LAYER ROOF	<image/> <image/> <text><text><text><text><text><text><text><text><text></text></text></text></text></text></text></text></text></text>	THORITY NUMBER A-2016000415 E STREET 9, MO 65806 B5.0002 chitecture.com LTANTS LTANTS LTANTS COMPANY

I IGHT INFRINGEMENT. A SERVICE FEE OF 1.5% WILL BE CHARGED PER MONTH ON THE UNPAID BALANCE. THE USER OF THESE DRAWINGS SHALL PAY ALL COSTS OF COLLECTION, INCLUDING ATTORNEY'S FEE

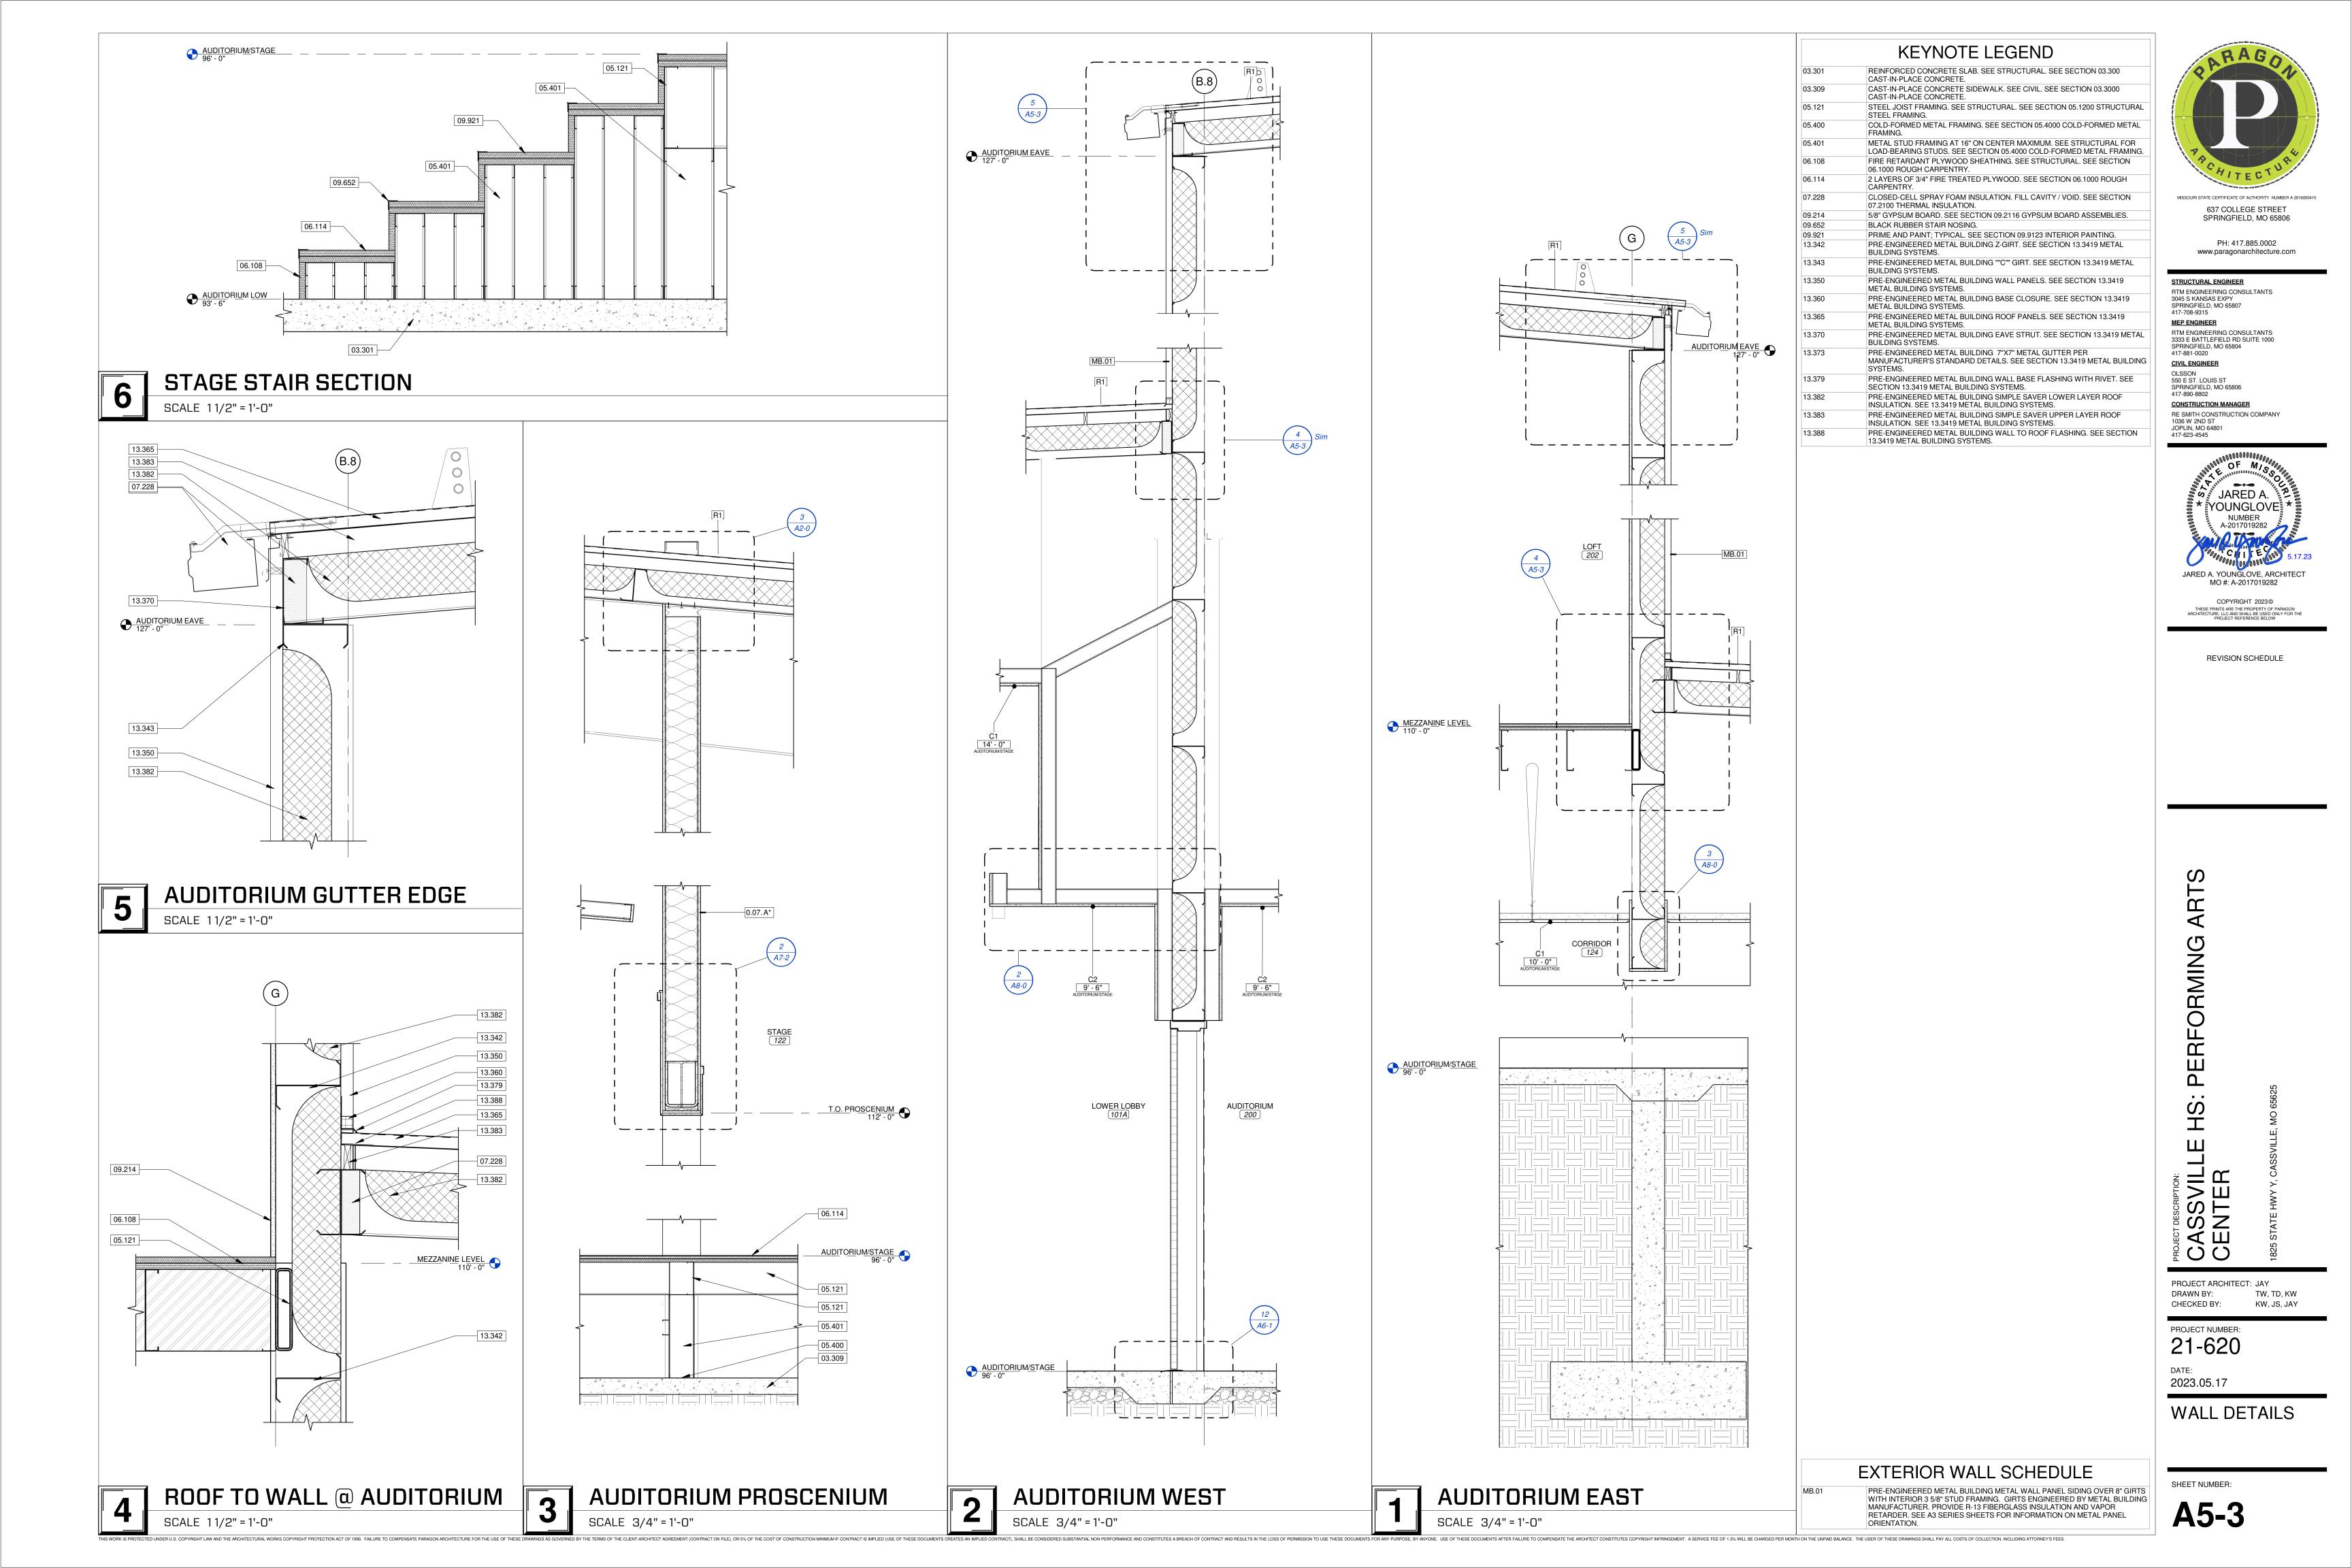

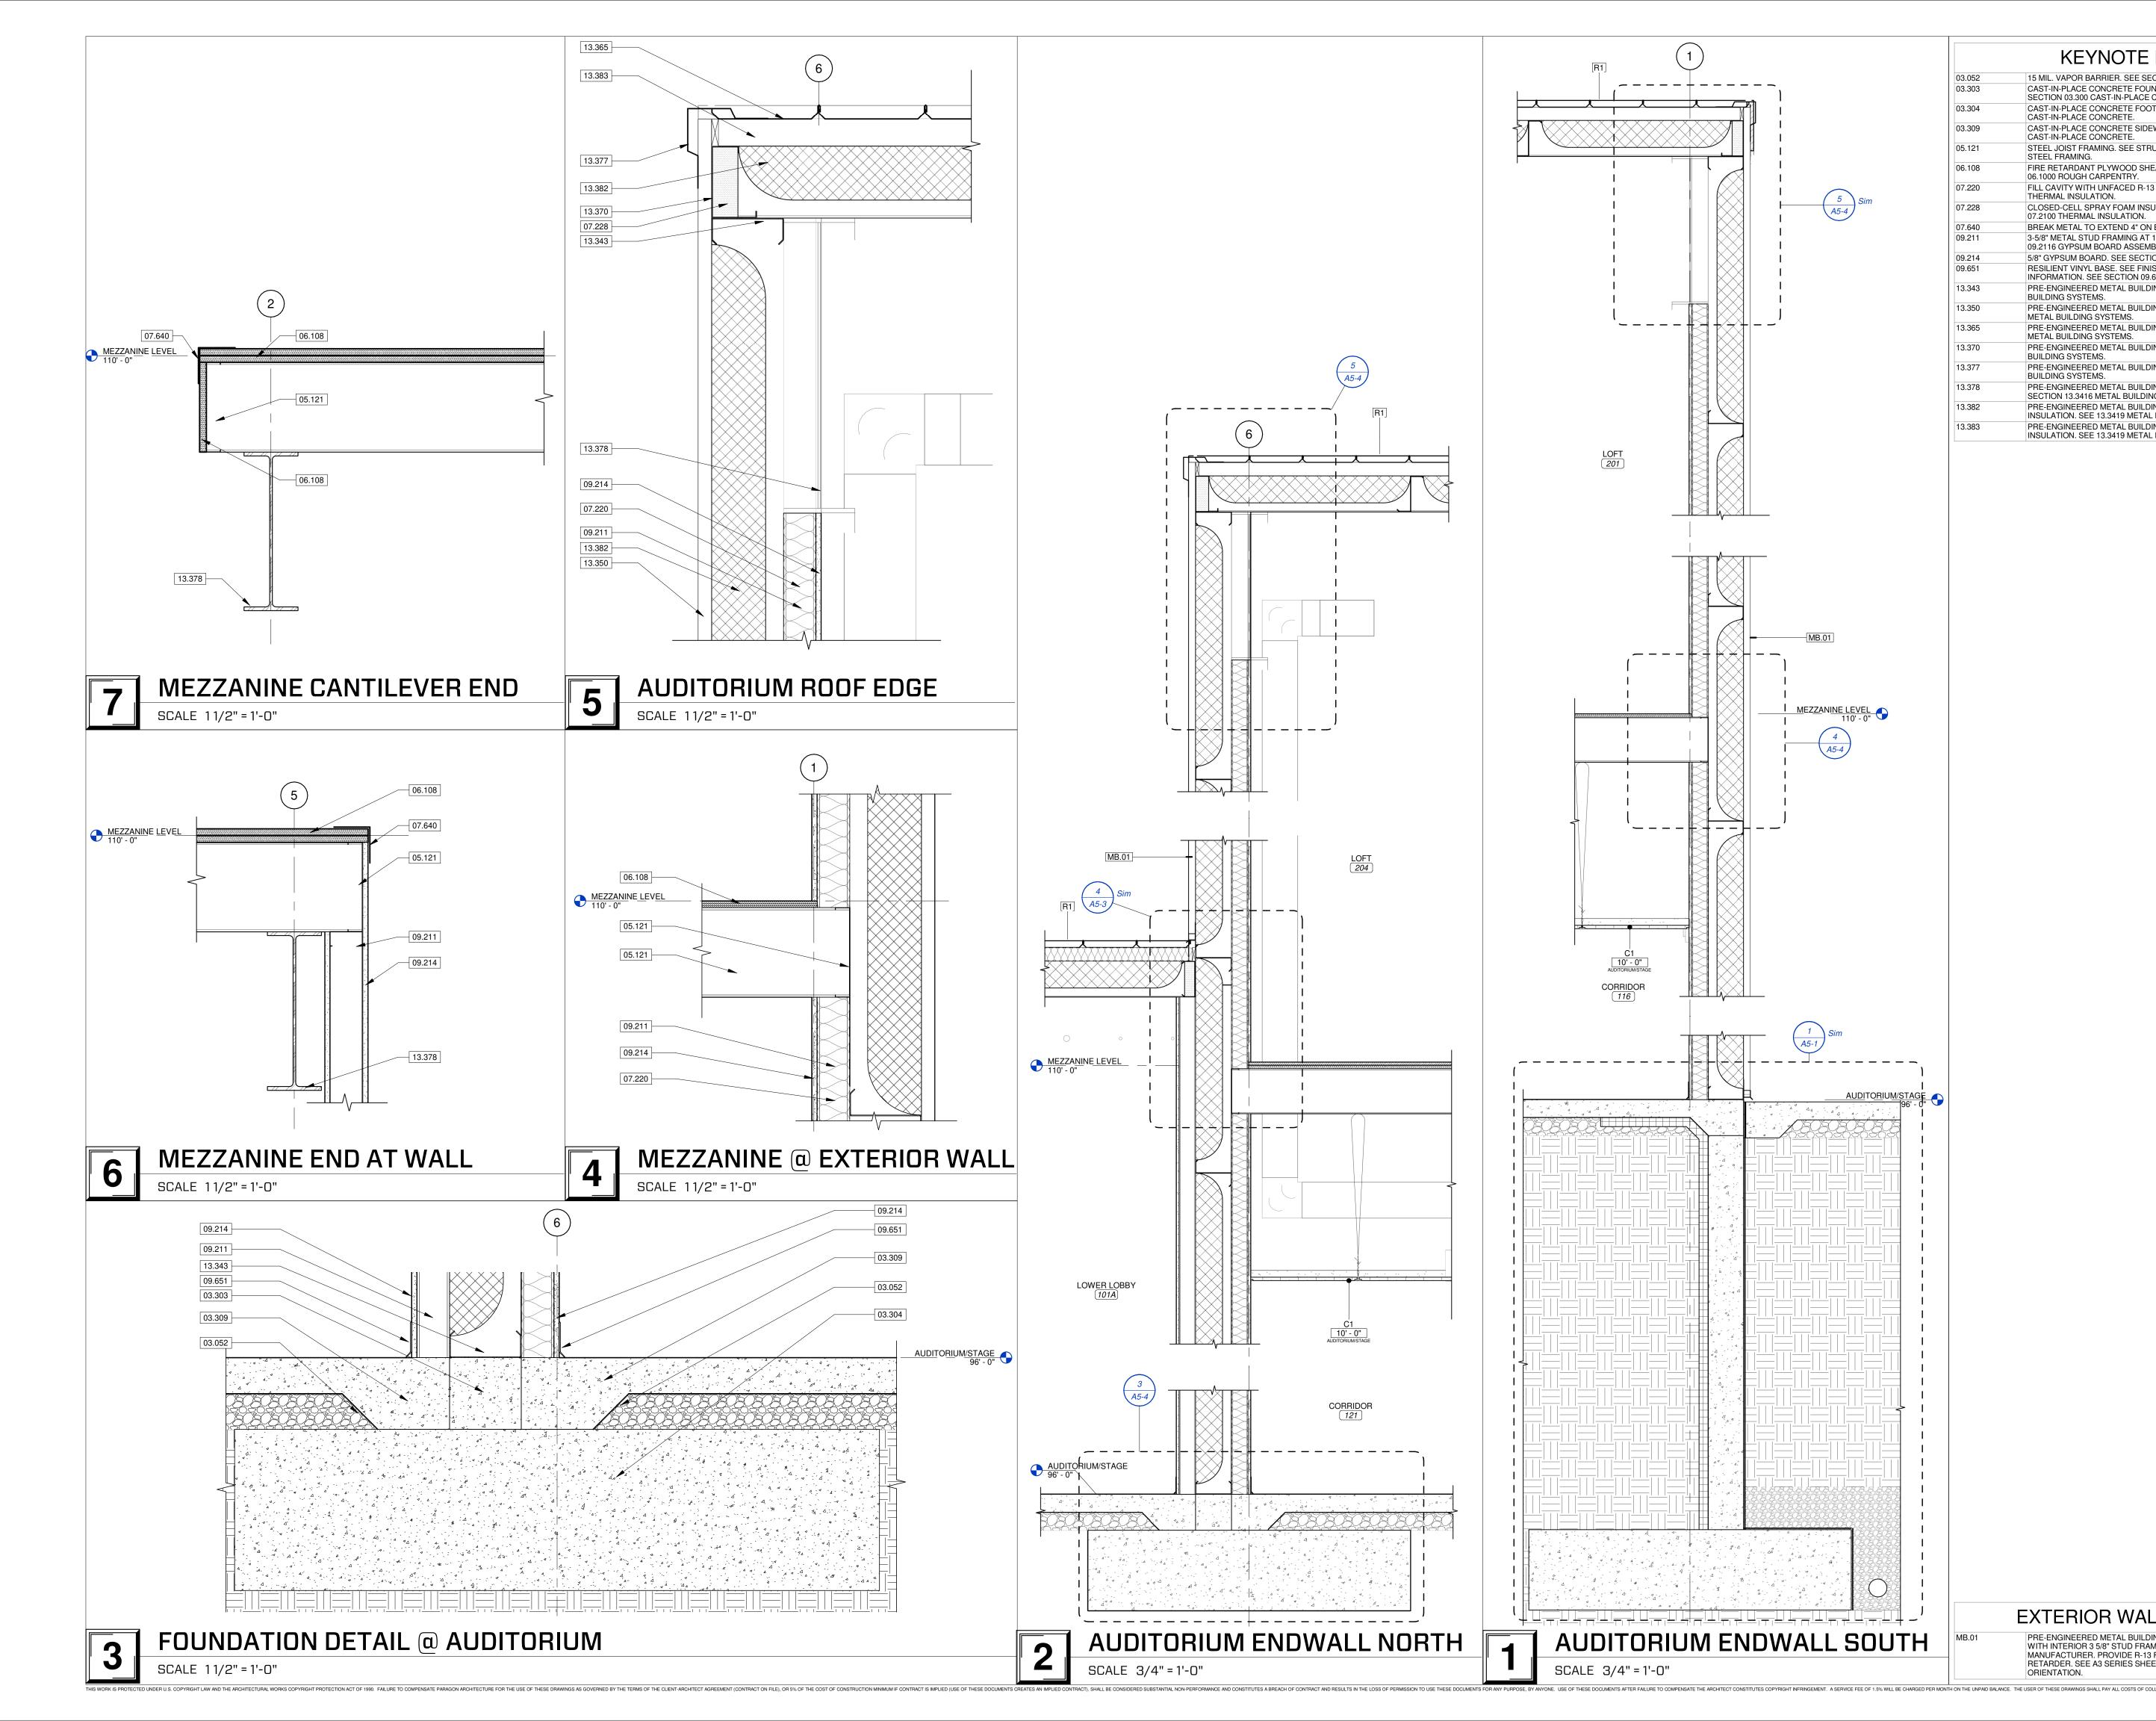

KEYNOTE LEGEND

3.052	15 MIL. VAPOR BARRIER. SEE SECTION 03.0516 UNDER SLAB VAPOR BARRIER.
3.303	CAST-IN-PLACE CONCRETE FOUNDATION WALL. SEE STRUCTURAL. SEE SECTION 03.300 CAST-IN-PLACE CONCRETE.
3.304	CAST-IN-PLACE CONCRETE FOOTING. SEE STRUCTURAL. SEE SECTION 03.300 CAST-IN-PLACE CONCRETE.
3.309	CAST-IN-PLACE CONCRETE SIDEWALK. SEE CIVIL. SEE SECTION 03.3000 CAST-IN-PLACE CONCRETE.
5.121	STEEL JOIST FRAMING. SEE STRUCTURAL. SEE SECTION 05.1200 STRUCTURAL STEEL FRAMING.
6.108	FIRE RETARDANT PLYWOOD SHEATHING. SEE STRUCTURAL. SEE SECTION 06.1000 ROUGH CARPENTRY.
7.220	FILL CAVITY WITH UNFACED R-13 BATT INSULATION. SEE SECTION 07.2100 THERMAL INSULATION.
7.228	CLOSED-CELL SPRAY FOAM INSULATION. FILL CAVITY / VOID. SEE SECTION 07.2100 THERMAL INSULATION.
7.640	BREAK METAL TO EXTEND 4" ON EACH FACE. SEE SECTION 07.6200.
9.211	3-5/8" METAL STUD FRAMING AT 16" ON CENTER MAXIMUM. SEE SECTION 09.2116 GYPSUM BOARD ASSEMBLIES.
9.214	5/8" GYPSUM BOARD. SEE SECTION 09.2116 GYPSUM BOARD ASSEMBLIES.
9.651	RESILIENT VINYL BASE. SEE FINISH SCHEDULE AND FINISH PLANS FOR MORE INFORMATION. SEE SECTION 09.6500 RESILIENT FLOORING.
3.343	PRE-ENGINEERED METAL BUILDING ""C"" GIRT. SEE SECTION 13.3419 METAL BUILDING SYSTEMS.
3.350	PRE-ENGINEERED METAL BUILDING WALL PANELS. SEE SECTION 13.3419 METAL BUILDING SYSTEMS.
3.365	PRE-ENGINEERED METAL BUILDING ROOF PANELS. SEE SECTION 13.3419 METAL BUILDING SYSTEMS.
3.370	PRE-ENGINEERED METAL BUILDING EAVE STRUT. SEE SECTION 13.3419 METAL BUILDING SYSTEMS.
3.377	PRE-ENGINEERED METAL BUILDING RAKE TRIM. SEE SECTION 13.3419 METAL BUILDING SYSTEMS.
3.378	PRE-ENGINEERED METAL BUILDING STRUCTURAL STEEL FRAMING. SEE SECTION 13.3416 METAL BUILDING SYSTEMS.
3.382	PRE-ENGINEERED METAL BUILDING SIMPLE SAVER LOWER LAYER ROOF INSULATION. SEE 13.3419 METAL BUILDING SYSTEMS.
3.383	PRE-ENGINEERED METAL BUILDING SIMPLE SAVER UPPER LAYER ROOF INSULATION. SEE 13.3419 METAL BUILDING SYSTEMS.



637 COLLEGE STREET SPRINGFIELD, MO 65806

PH: 417.885.0002 www.paragonarchitecture.com

STRUCTURAL ENGINEER RTM ENGINEERING CONSULTANTS 3045 S KANSAS EXPY SPRINGFIELD, MO 65807 417-708-9315 MEP ENGINEER RTM ENGINEERING CONSULTANTS 3333 E BATTLEFIELD RD SUITE 1000 SPRINGFIELD, MO 65804 417-881-0020 CIVIL ENGINEER OLSSON 550 E ST. LOUIS ST SPRINGFIELD, MO 65806 417-890-8802 CONSTRUCTION MANAGER RE SMITH CONSTRUCTION COMPANY 1036 W 2ND ST JOPLIN, MO 64801 417-623-4545



COPYRIGHT 2023© THESE PRINTS ARE THE PROPERTY OF PARAGON ARCHITECTURE, LLC AND SHALL BE USED ONLY FOR THE PROJECT REFERENCE BELOW

REVISION SCHEDULE





WALL DETAILS

SHEET NUMBER: **A5-4**

EXTERIOR WALL SCHEDULE PRE-ENGINEERED METAL BUILDING METAL WALL PANEL SIDING OVER 8" GIRTS WITH INTERIOR 3 5/8" STUD FRAMING. GIRTS ENGINEERED BY METAL BUILDING MANUFACTURER. PROVIDE R-13 FIBERGLASS INSULATION AND VAPOR RETARDER. SEE A3 SERIES SHEETS FOR INFORMATION ON METAL PANEL


ORIENTATION.

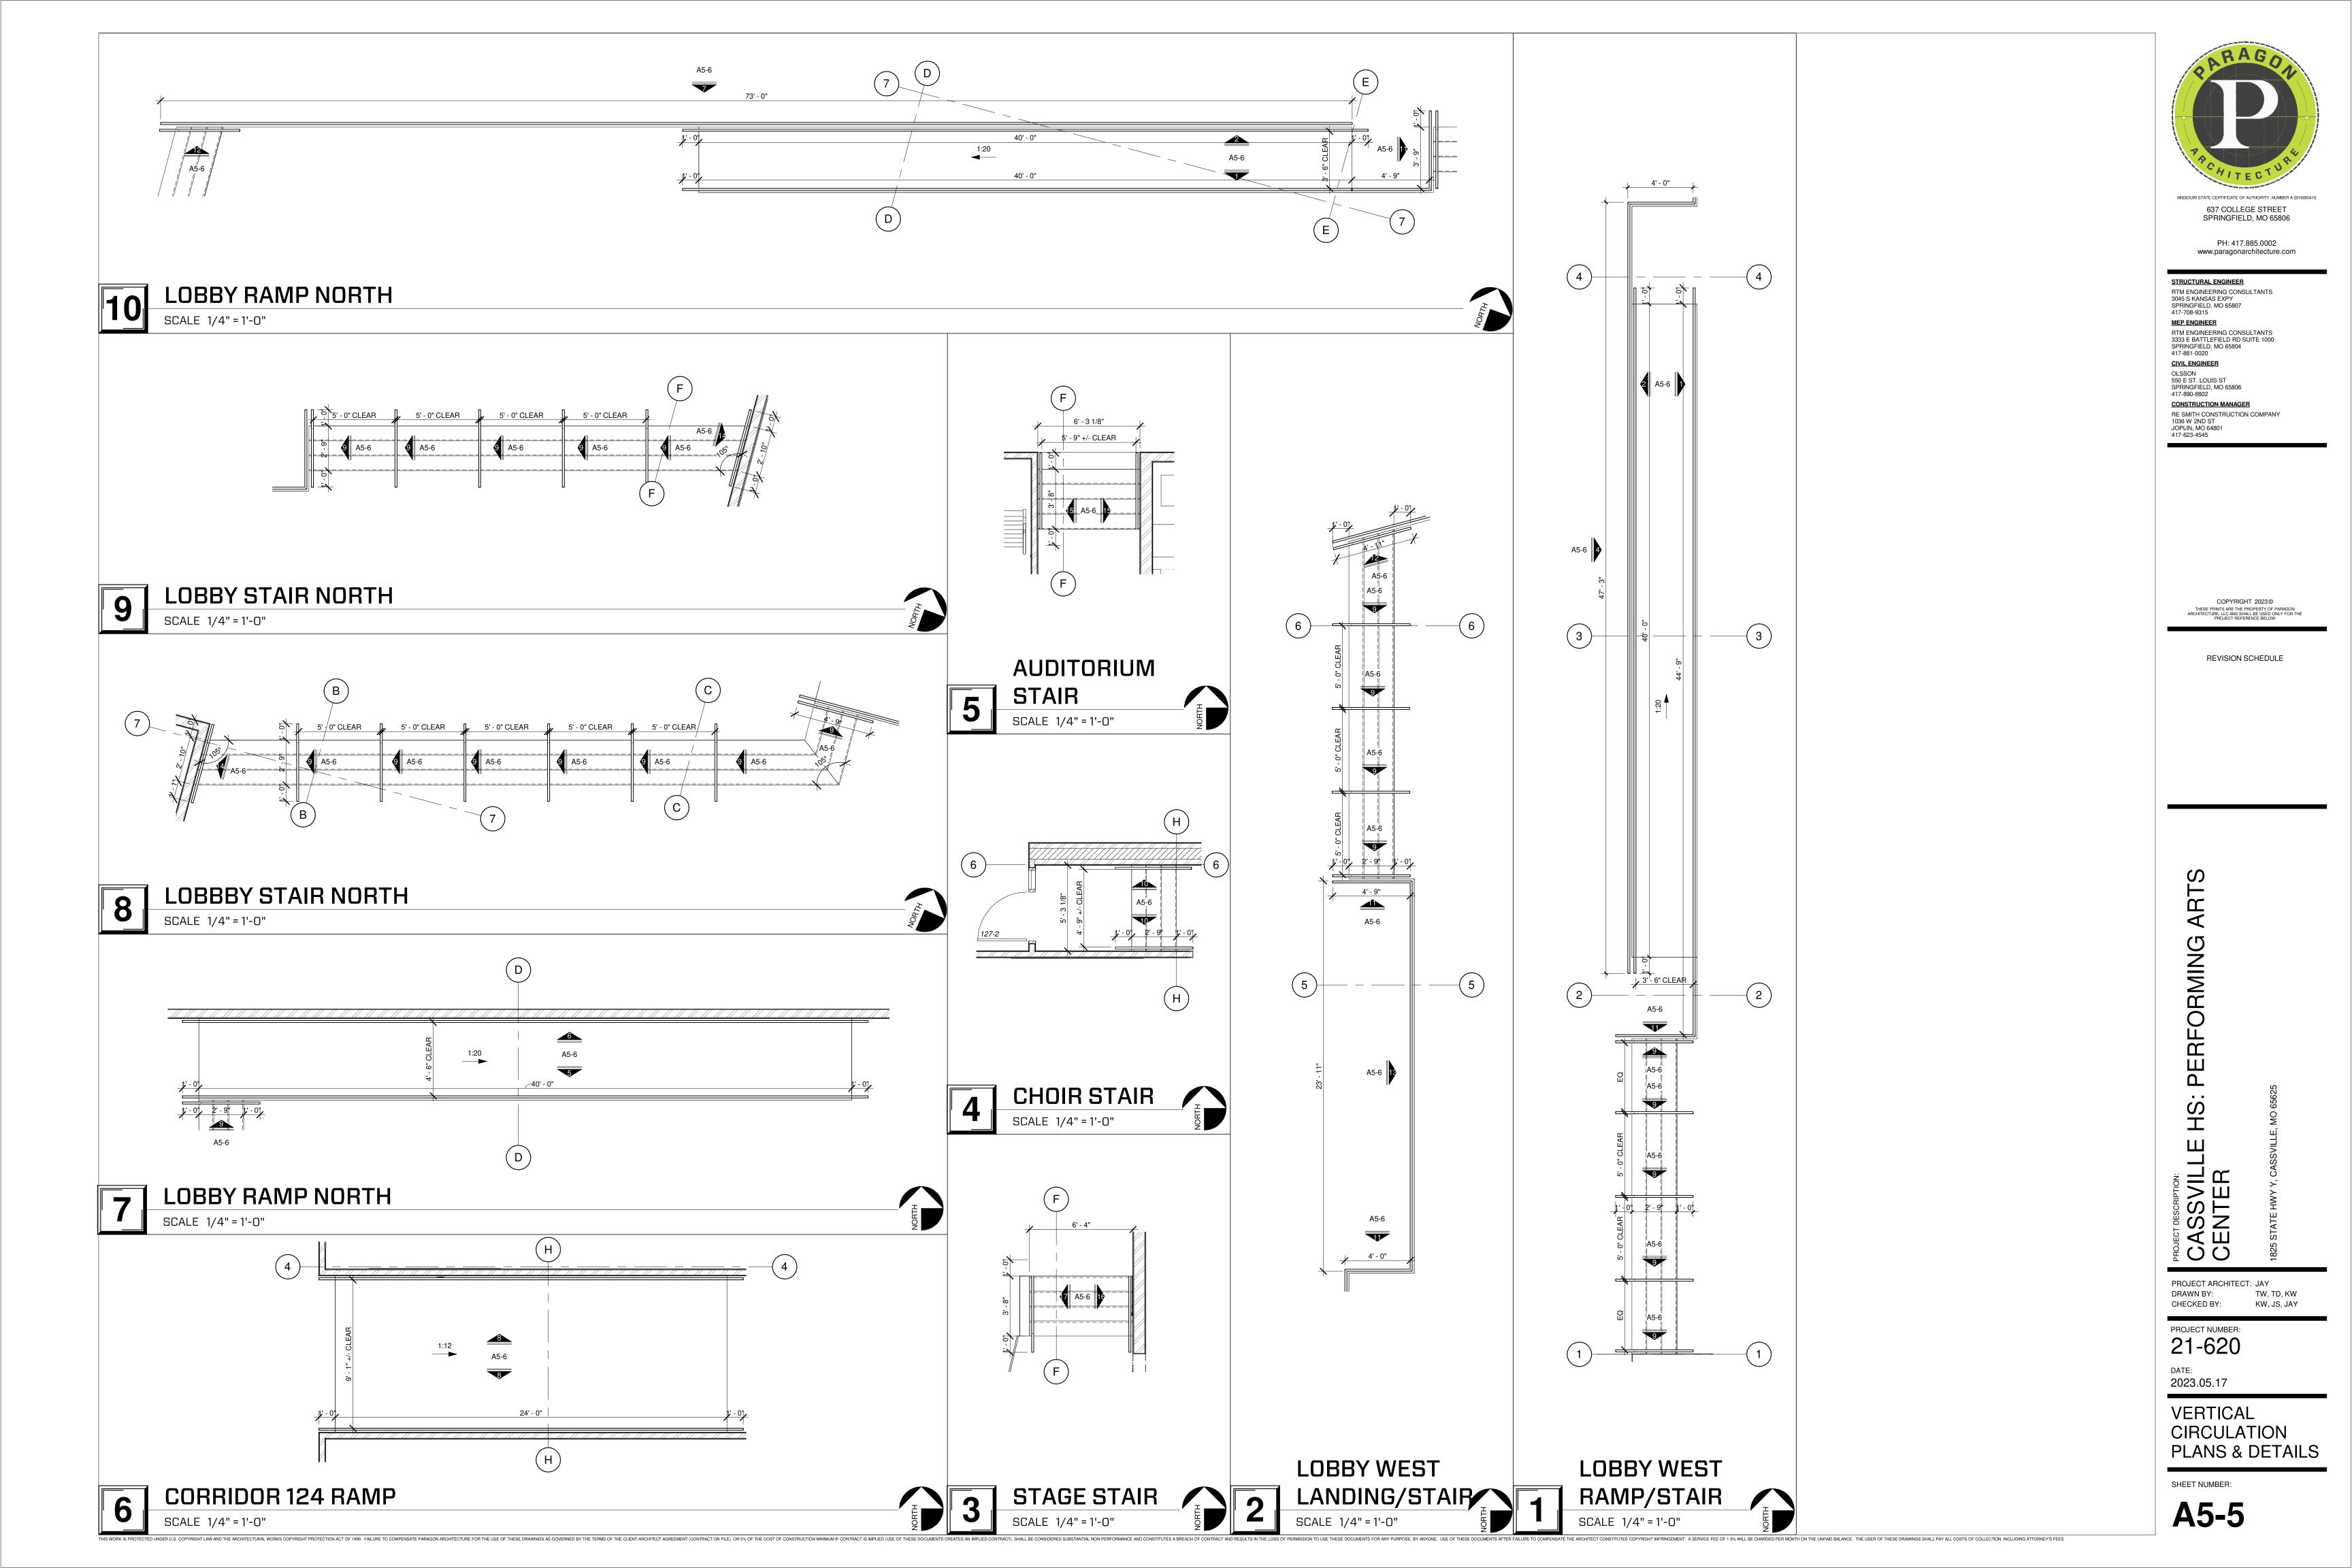

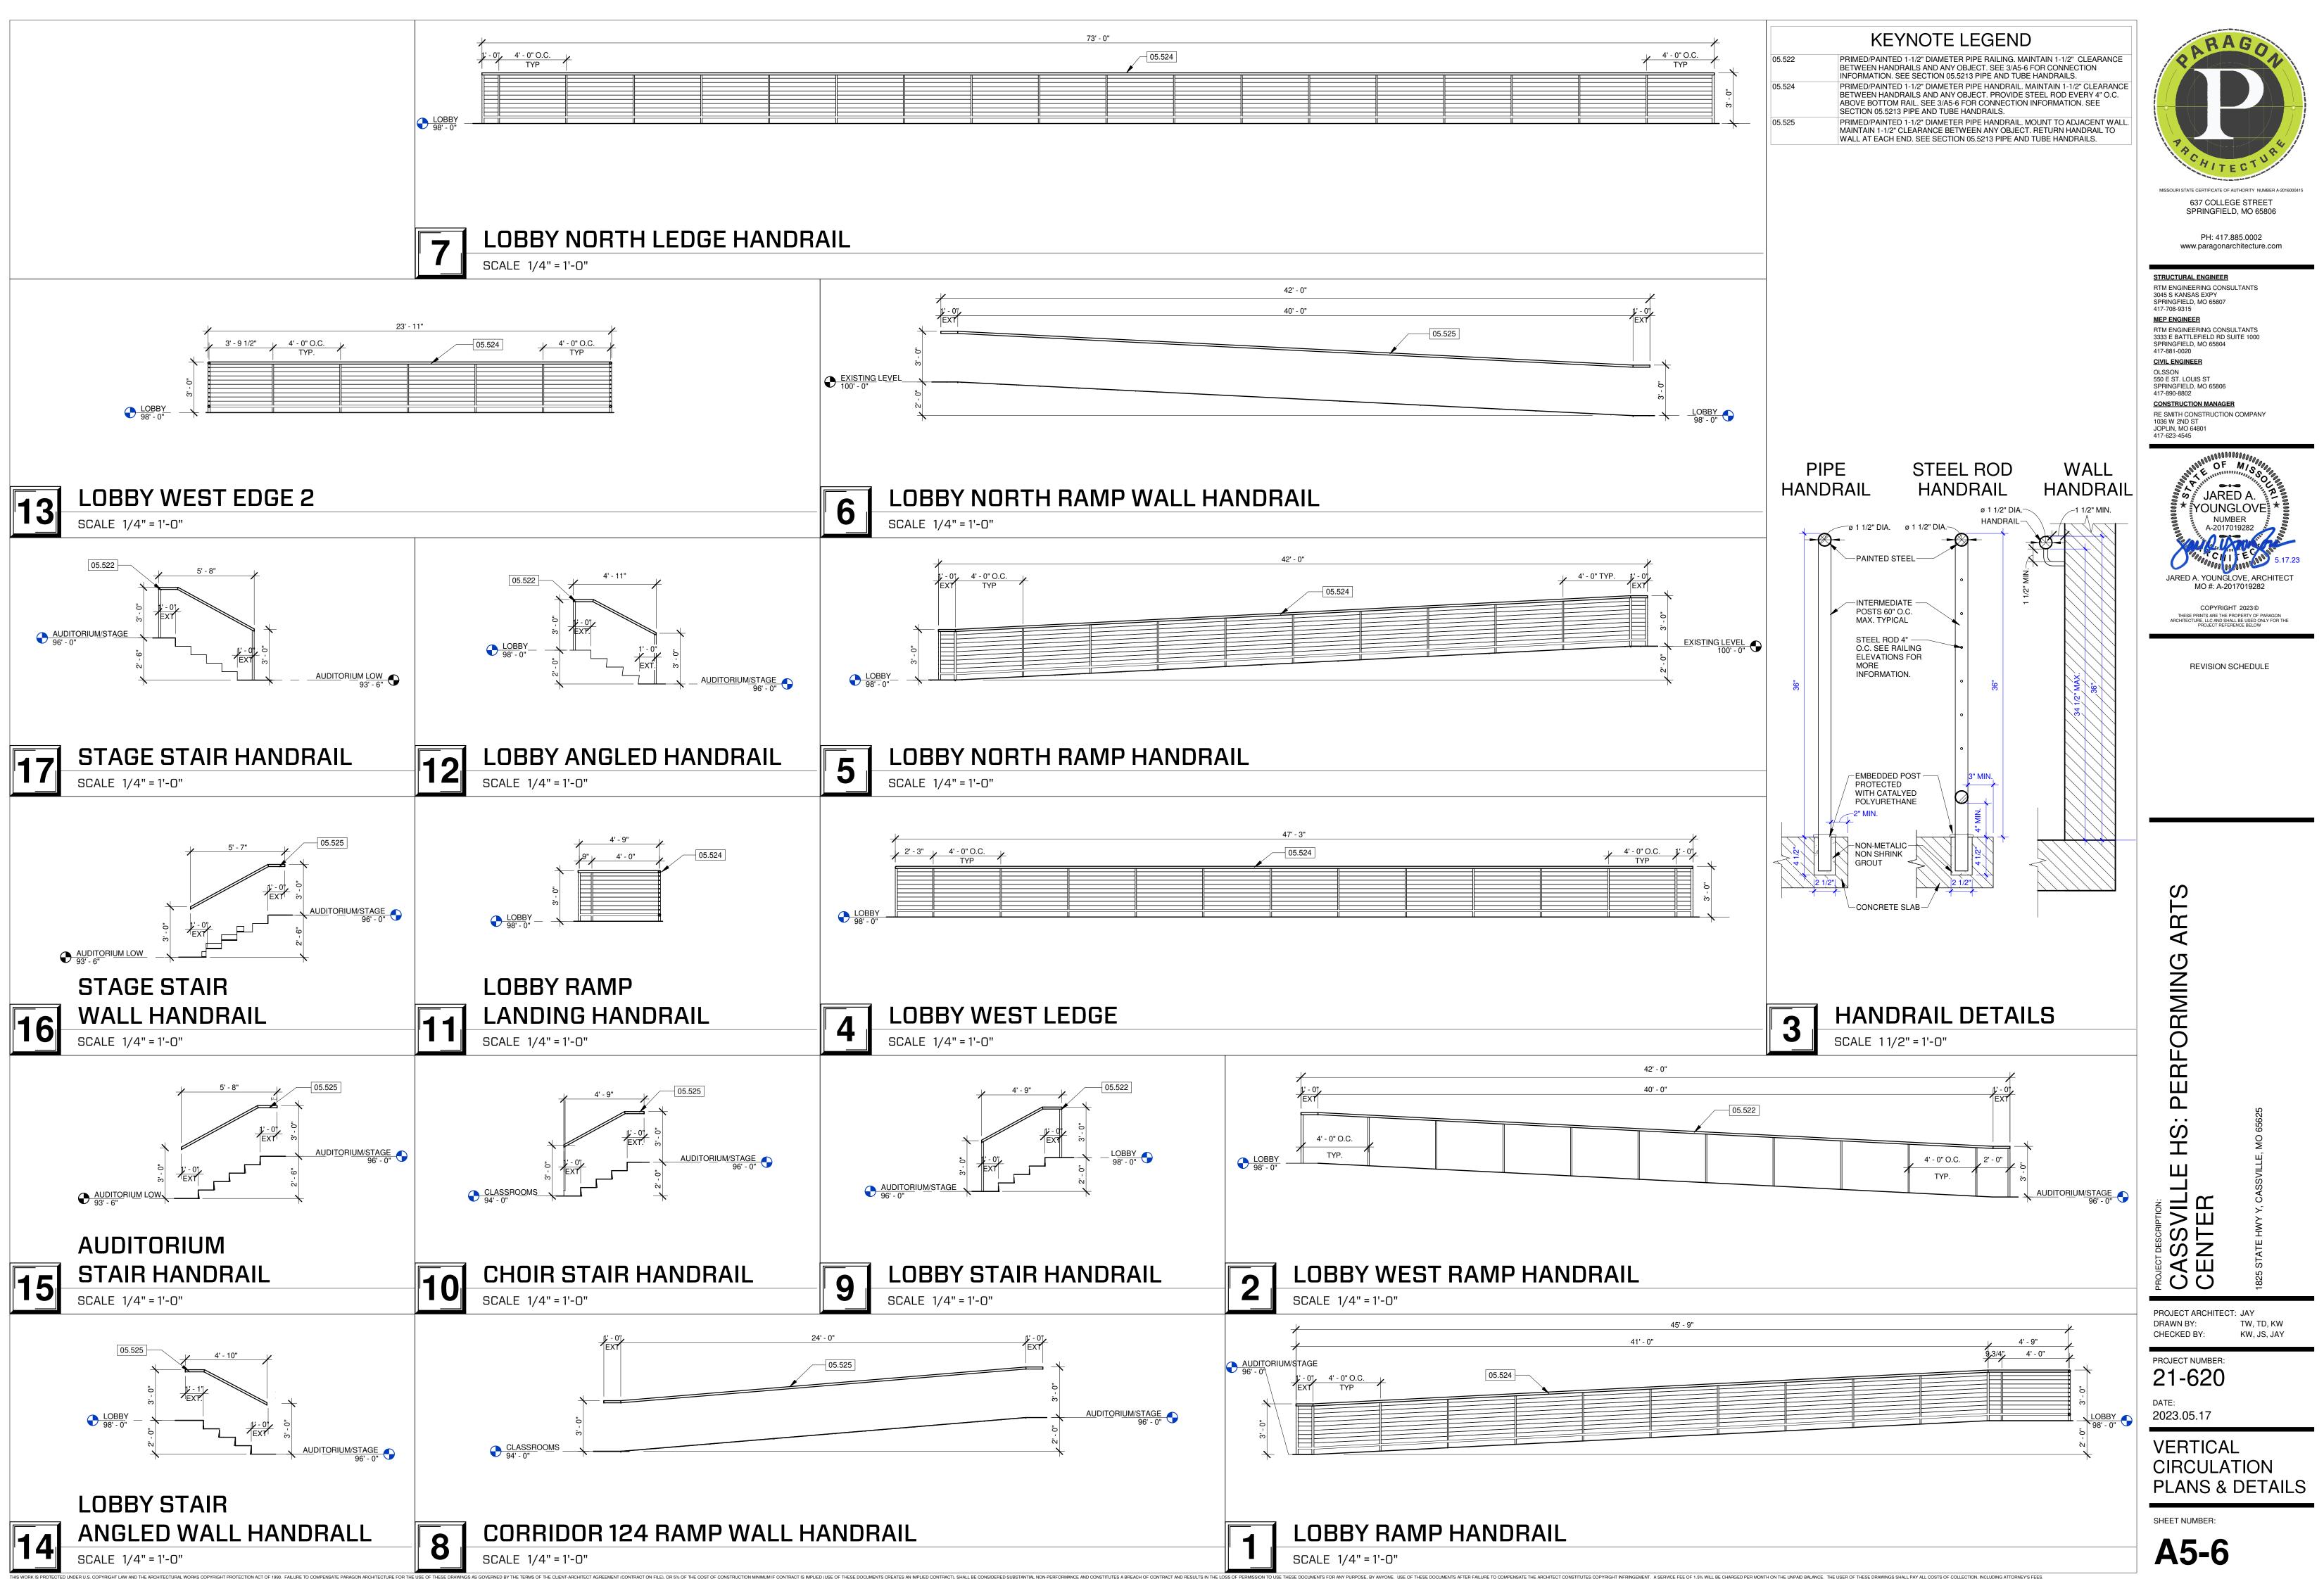


3' -	0"		


			<u> </u>				
							L

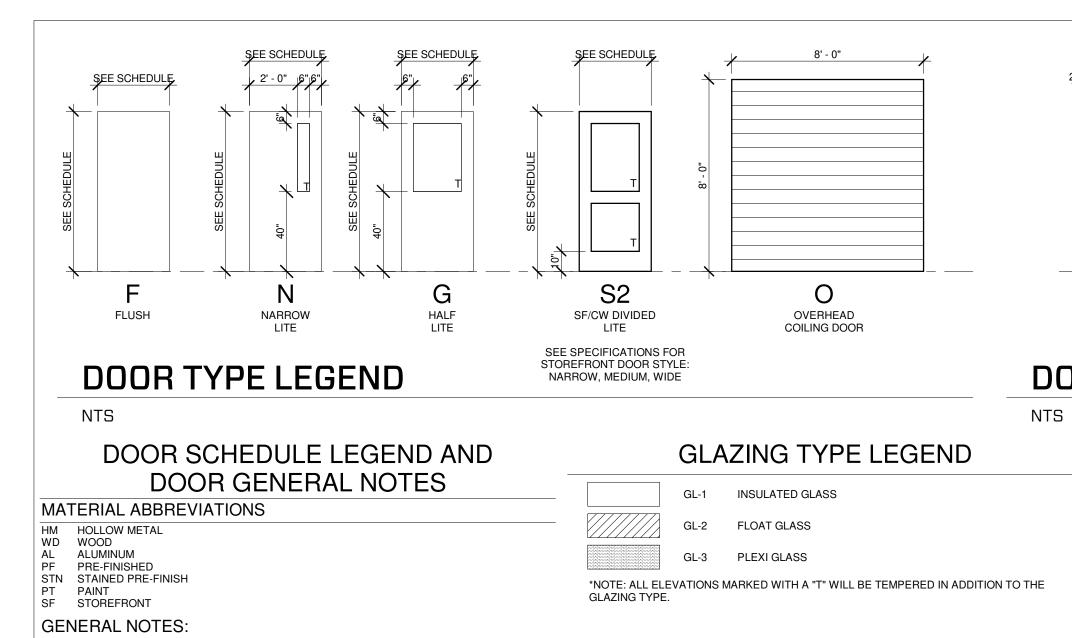

- GLAZING IN DOORS AND WINDOWS TAGGED WITH A "T" ARE TO BE TEMPERED GLASS.
 ALL GLASS IN DOORS, ADJACENT, OR WITHIN 12" OF DOORS HORIZONTALLY, OR WITHIN 36"
- OF STAIRS, OR CLOSER THAN 18" TO FLOOR TO BE TEMPERED PER THE APPLICABLE VERSION OF INTERNATIONAL BUILDING CODE.
- 3. REFER TO A6 SHEETS FOR HEAD, JAMB, AND SILL DETAILS UNLESS NOTED OTHERWISE. 4. REFER TO ELECTRICAL WIRING DIAGRAMS OF POWERED OPENINGS AND POWERED
- HARDWARE FOR ADDITIONAL INFORMATION.

						D	DOR A	ND FR/	AME SO	CHEDU	LE		
				DOC	DR					FRAME			
	OPE	NING			PAN	EL							
DOOR NO.	WIDTH	HEIGHT	CONFIG	PANEL WIDTH	THICK	TYPE	MATL	FINISH	TYPE	MATL	FINISH	RATING	
100-1	6' - 0"	7' - 0"	PAIR	3' - 0"	1 3/4"	S2	AL	PF	SF.2	AL	PF		
100-2	6' - 0"	7' - 0"	PAIR	3' - 0"	1 3/4"	S2	AL	PF	SF.2	AL	PF		
100-3	6' - 0"	7' - 0"	PAIR	3' - 0"	1 3/4"	S2	AL	PF	SF.3	AL	PF		
100-4	6' - 0"	7' - 0"	PAIR	3' - 0"	1 3/4"	S2	AL	PF	SF.3	AL	PF		
100-5	6' - 0"	7' - 0"	PAIR	3' - 0"	1 3/4"	S2	AL	PF	SF.5	AL	PF		
100-6	6' - 0"	7' - 0"	PAIR	3' - 0"	1 3/4"	S2	AL	PF	SF.11	AL	PF		
100-7	6' - 0"	7' - 0"	PAIR	3' - 0"	1 3/4"	S2	AL	PF	SF.11	AL	PF		
100-8	6' - 0"	7' - 0"	PAIR	3' - 0"	1 3/4"	S2	AL	PF	SF.11	AL	PF		
100-9	6' - 0"	7' - 0"	PAIR	3' - 0"	1 3/4"	S2	AL	PF	SF.11	AL	PF		
100-10	3' - 0"	7' - 0"	SINGLE	3' - 0"	1 3/4"	F	WD	STN	F1	HM	PT		
104-1	3' - 0"	7' - 0"	SINGLE	3' - 0"	1 3/4"	F	WD	STN	F1	HM	PT		
105-1	3' - 0"	7' - 0"	SINGLE	3' - 0"	1 3/4"	F	WD	STN	F1	HM	PT		
106-1	3' - 0"	7' - 0"	SINGLE	3' - 0"	1 3/4"	F	WD	STN	F1	HM	PT		
109-1	3' - 0"	7' - 0"	SINGLE	3' - 0"	1 3/4"	F	WD	STN	F1	HM	PT		
110-1	6' - 0"	7' - 0"	PAIR	3' - 0"	1 3/4"	F	WD	STN	F1	HM	PT		
115-1	3' - 0"	7' - 0"	SINGLE	3' - 0"	1 3/4"	F	WD	STN	F1	HM	PT		
117-1	6' - 0"	7' - 0"	PAIR	3' - 0"	1 3/4"	F	WD	STN	F1	HM	PT		
119-1	3' - 0"	7' - 0"	SINGLE	3' - 0"	1 3/4"	F	WD	STN	F1	HM	PT		
120-1	3' - 0"	7' - 0"	SINGLE	3' - 0"	1 3/4"	F	WD	STN	F1	HM	PT		
122-1	6' - 0"	7' - 0"	PAIR	3' - 0"	1 3/4"	F	WD	STN	F1	HM	PT		
122-2	6' - 0"	7' - 0"	PAIR	3' - 0"	1 3/4"	F	WD	STN	F1	HM	PT		
122-3	8' - 0"	8' - 0"			3"		-	-	-	-	-		OVERHEAD COILI
124-1	6' - 0"	7' - 0"	PAIR	3' - 0"	1 3/4"	N	WD	STN	F1	HM	PT		
124-2	6' - 0"	7' - 0"	PAIR	3' - 0"	1 3/4"	N	HM	PT	F1	HM	PT		
124-4	6' - 0"	7' - 0"	PAIR	3' - 0"	1 3/4"	G	HM	PT	F1	HM	PT		
124-5	8' - 0"	8' - 0"		01 01	3"		-	-	-	-	-		OVERHEAD COILI
124-6	3' - 0"	7' - 0"	SINGLE	3' - 0"	1 3/4"	F	HM	PT	F1	HM	PT		
125-1	6' - 0"	7' - 0"	PAIR	3' - 0"	1 3/4"	N	WD	STN	F1	HM	PT		
125-2	3' - 0"	7' - 0"	SINGLE	3' - 0"	1 3/4"	F	HM	PT	F1	HM	PT		
126-1	6' - 0"	7' - 0"	PAIR	3' - 0"	1 3/4"	F	WD	STN	F1	HM	PT		
126-2	3' - 0"	7' - 0" 7' - 0"	SINGLE	3' - 0"	1 3/4"	•	WD WD	STN STN	F1 F1	HM	PT PT		
127-1	6' - 0"	7' - 0"		3' - 0"	1 3/4"	N				HM	PT		
127-2 128-1	3' - 0" 3' - 0"	7' - 0"	SINGLE	3' - 0" 3' - 0"	1 3/4" 1 3/4"	N F	WD WD	STN	F2	HM	PT		
128-1	3' - 0"	7'-0	SINGLE	3 - 0"	1 3/4"	F	WD	STN STN	F2 F2	HM	PT		
120-2	3' - 0"	7'-0"	SINGLE	3'-0"	1 3/4"	F F	WD	STN	F2	HM	PT		
130-1	3' - 0"	7'-0	SINGLE	3 - 0"	1 3/4"	F	WD	STN	F1	HM	PT		
136-1	3' - 0"	7' - 0"	SINGLE	3' - 0"	1 3/4"	F	WD	STN	F1	HM	PT		
136-2	3' - 0"	7'-0"	SINGLE	3'-0"	1 3/4"	F	WD	STN	F1	HM	PT		
136-3	3' - 0"	3' - 6"	SINGLE	3' - 0"	1 3/4"	F	WD	STN	F1	HM	PT		
200-1	6' - 0"	7' - 0"	PAIR	3' - 0"	1 3/4"	F	WD	STN	F1	HM	PT		
200-1	6' - 0"	7' - 0"	PAIR	3' - 0"	1 3/4"	F F	WD	STN	F1	HM	PT		
200-2	6' - 0"	7' - 0"	PAIR	3' - 0"	1 3/4"	F	WD	STN	F1	HM	PT		
200-3	6' - 0"	7'-0"	PAIR	3' - 0"	1 3/4"	F	HM	PT	F1	HM	PT		
200-4	6' - 0"	7' - 0"	PAIR	3' - 0"	1 3/4"	N	WD	STN	F1	HM	PT		
200-5	6' - 0"	7'-0	PAIR	3 - 0	1 3/4"	N	WD	STN	F1	HM	PT		
200-6	3' - 0"	7'-0	SINGLE	3 - 0"	1 3/4"	F	WD	STN	F1	HM	PT	60 MIN.	BID ALTERNATE
201-1	3' - 0"	7'-0"	SINGLE	3' - 0"	1 3/4"	F	WD	STN	F1	HM	PT	60 MIN.	BID ALTERNATE

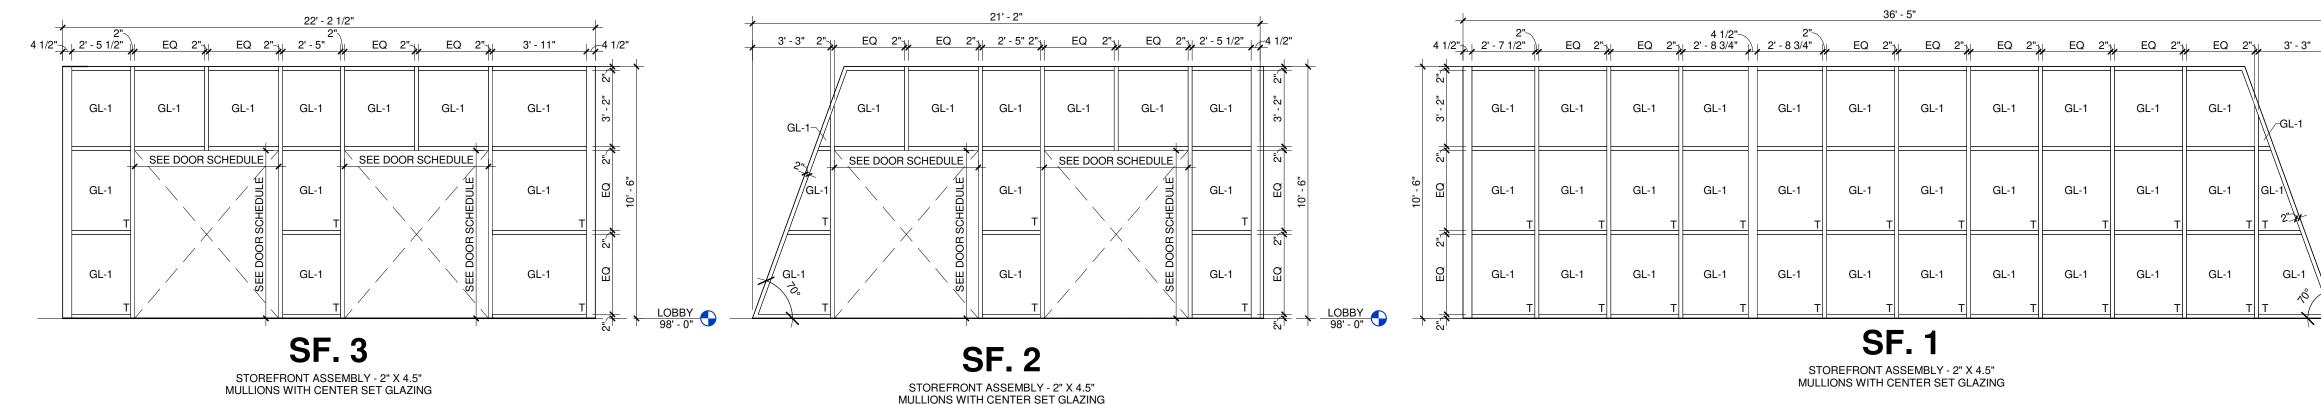


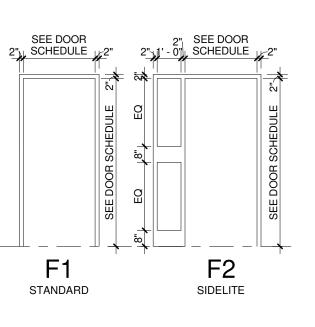


DOOR FRAME LEGEND



GL-1

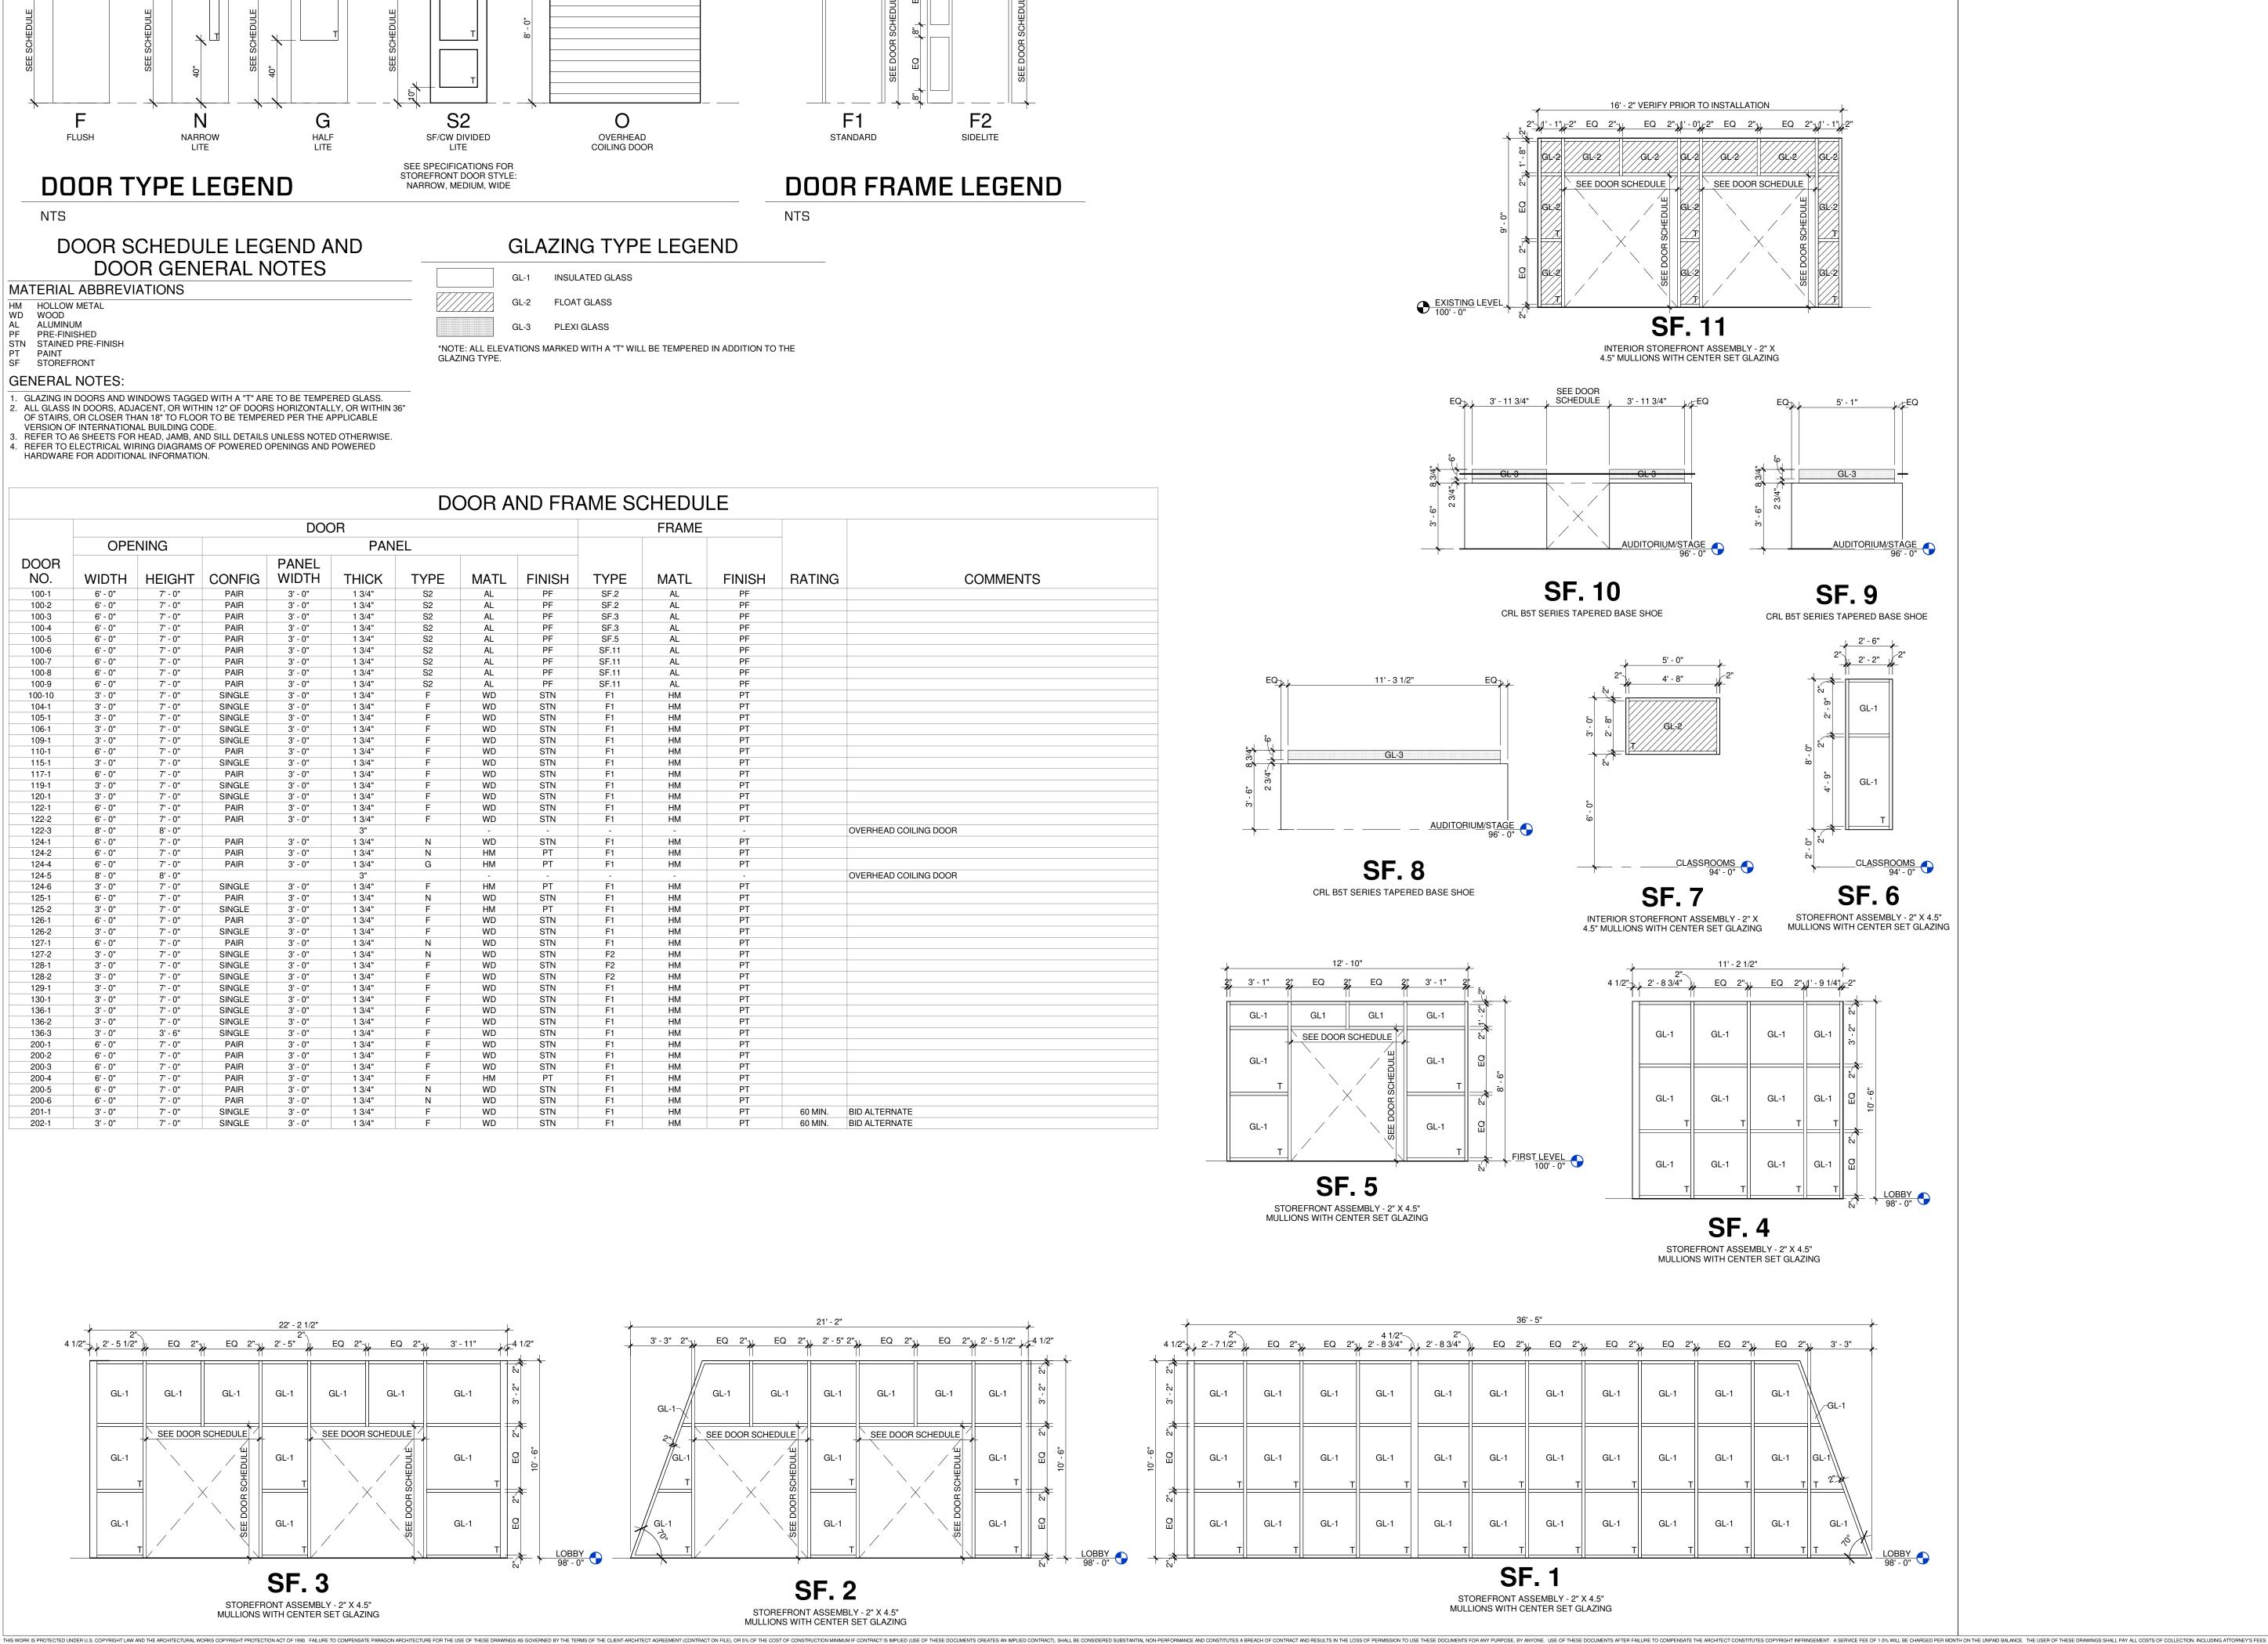

PARAGON
P A C H I T E C T U R 4
MISSOURI STATE CERTIFICATE OF AUTHORITY NUMBER A-2016000415 637 COLLEGE STREET SPRINGFIELD, MO 65806
PH: 417.885.0002 www.paragonarchitecture.com
STRUCTURAL ENGINEER RTM ENGINEERING CONSULTANTS 3045 S KANSAS EXPY
SPRINGFIELD, MO 65807 417-708-9315 <u>MEP ENGINEER</u> RTM ENGINEERING CONSULTANTS 3333 E BATTLEFIELD RD SUITE 1000
SPRINGFIELD, MO 65804 417-881-0020 <u>CIVIL ENGINEER</u> OLSSON 550 E ST. LOUIS ST
SPRINGFIELD, MO 65806 417-890-8802 <u>CONSTRUCTION MANAGER</u> RE SMITH CONSTRUCTION COMPANY 1036 W 2ND ST
JOPLIN, MO 84801 417-623-4545 OF M/S JARED A.
YOUNGLOVE NUMBER A-2017019282
JARED A. YOUNGLOVE, ARCHITECT MO #: A-2017019282
COPYRIGHT 2023 © THESE PRINTS ARE THE PROPERTY OF PARAGON ARCHITECTURE, LLC AND SHALL BE USED ONLY FOR THE PROJECT REFERENCE BELOW
REVISION SCHEDULE
STS
PROJECT DESCRIPTION: CASSVILLE HS: PERFORMING ARTS CENTER 1825 STATE HWY Y, CASSVILLE, MO 65625
NIN
NHO NHO
Ц Ц Ц
н Mo 65 К
PROJECT DESCRIPTION: CASSVILLE HS: I CENTER 1825 STATE HWY Y, CASSVILLE, MO 65625
PROJECT ARCHITECT: JAY
DRAWN BY: TW, TD, KW CHECKED BY: KW, JS, JAY PROJECT NUMBER:
21-620 DATE:
2023.05.17
DOOR SCHEDULE AND INFORMATION
SHEET NUMBER:
SHEET NUMBER:

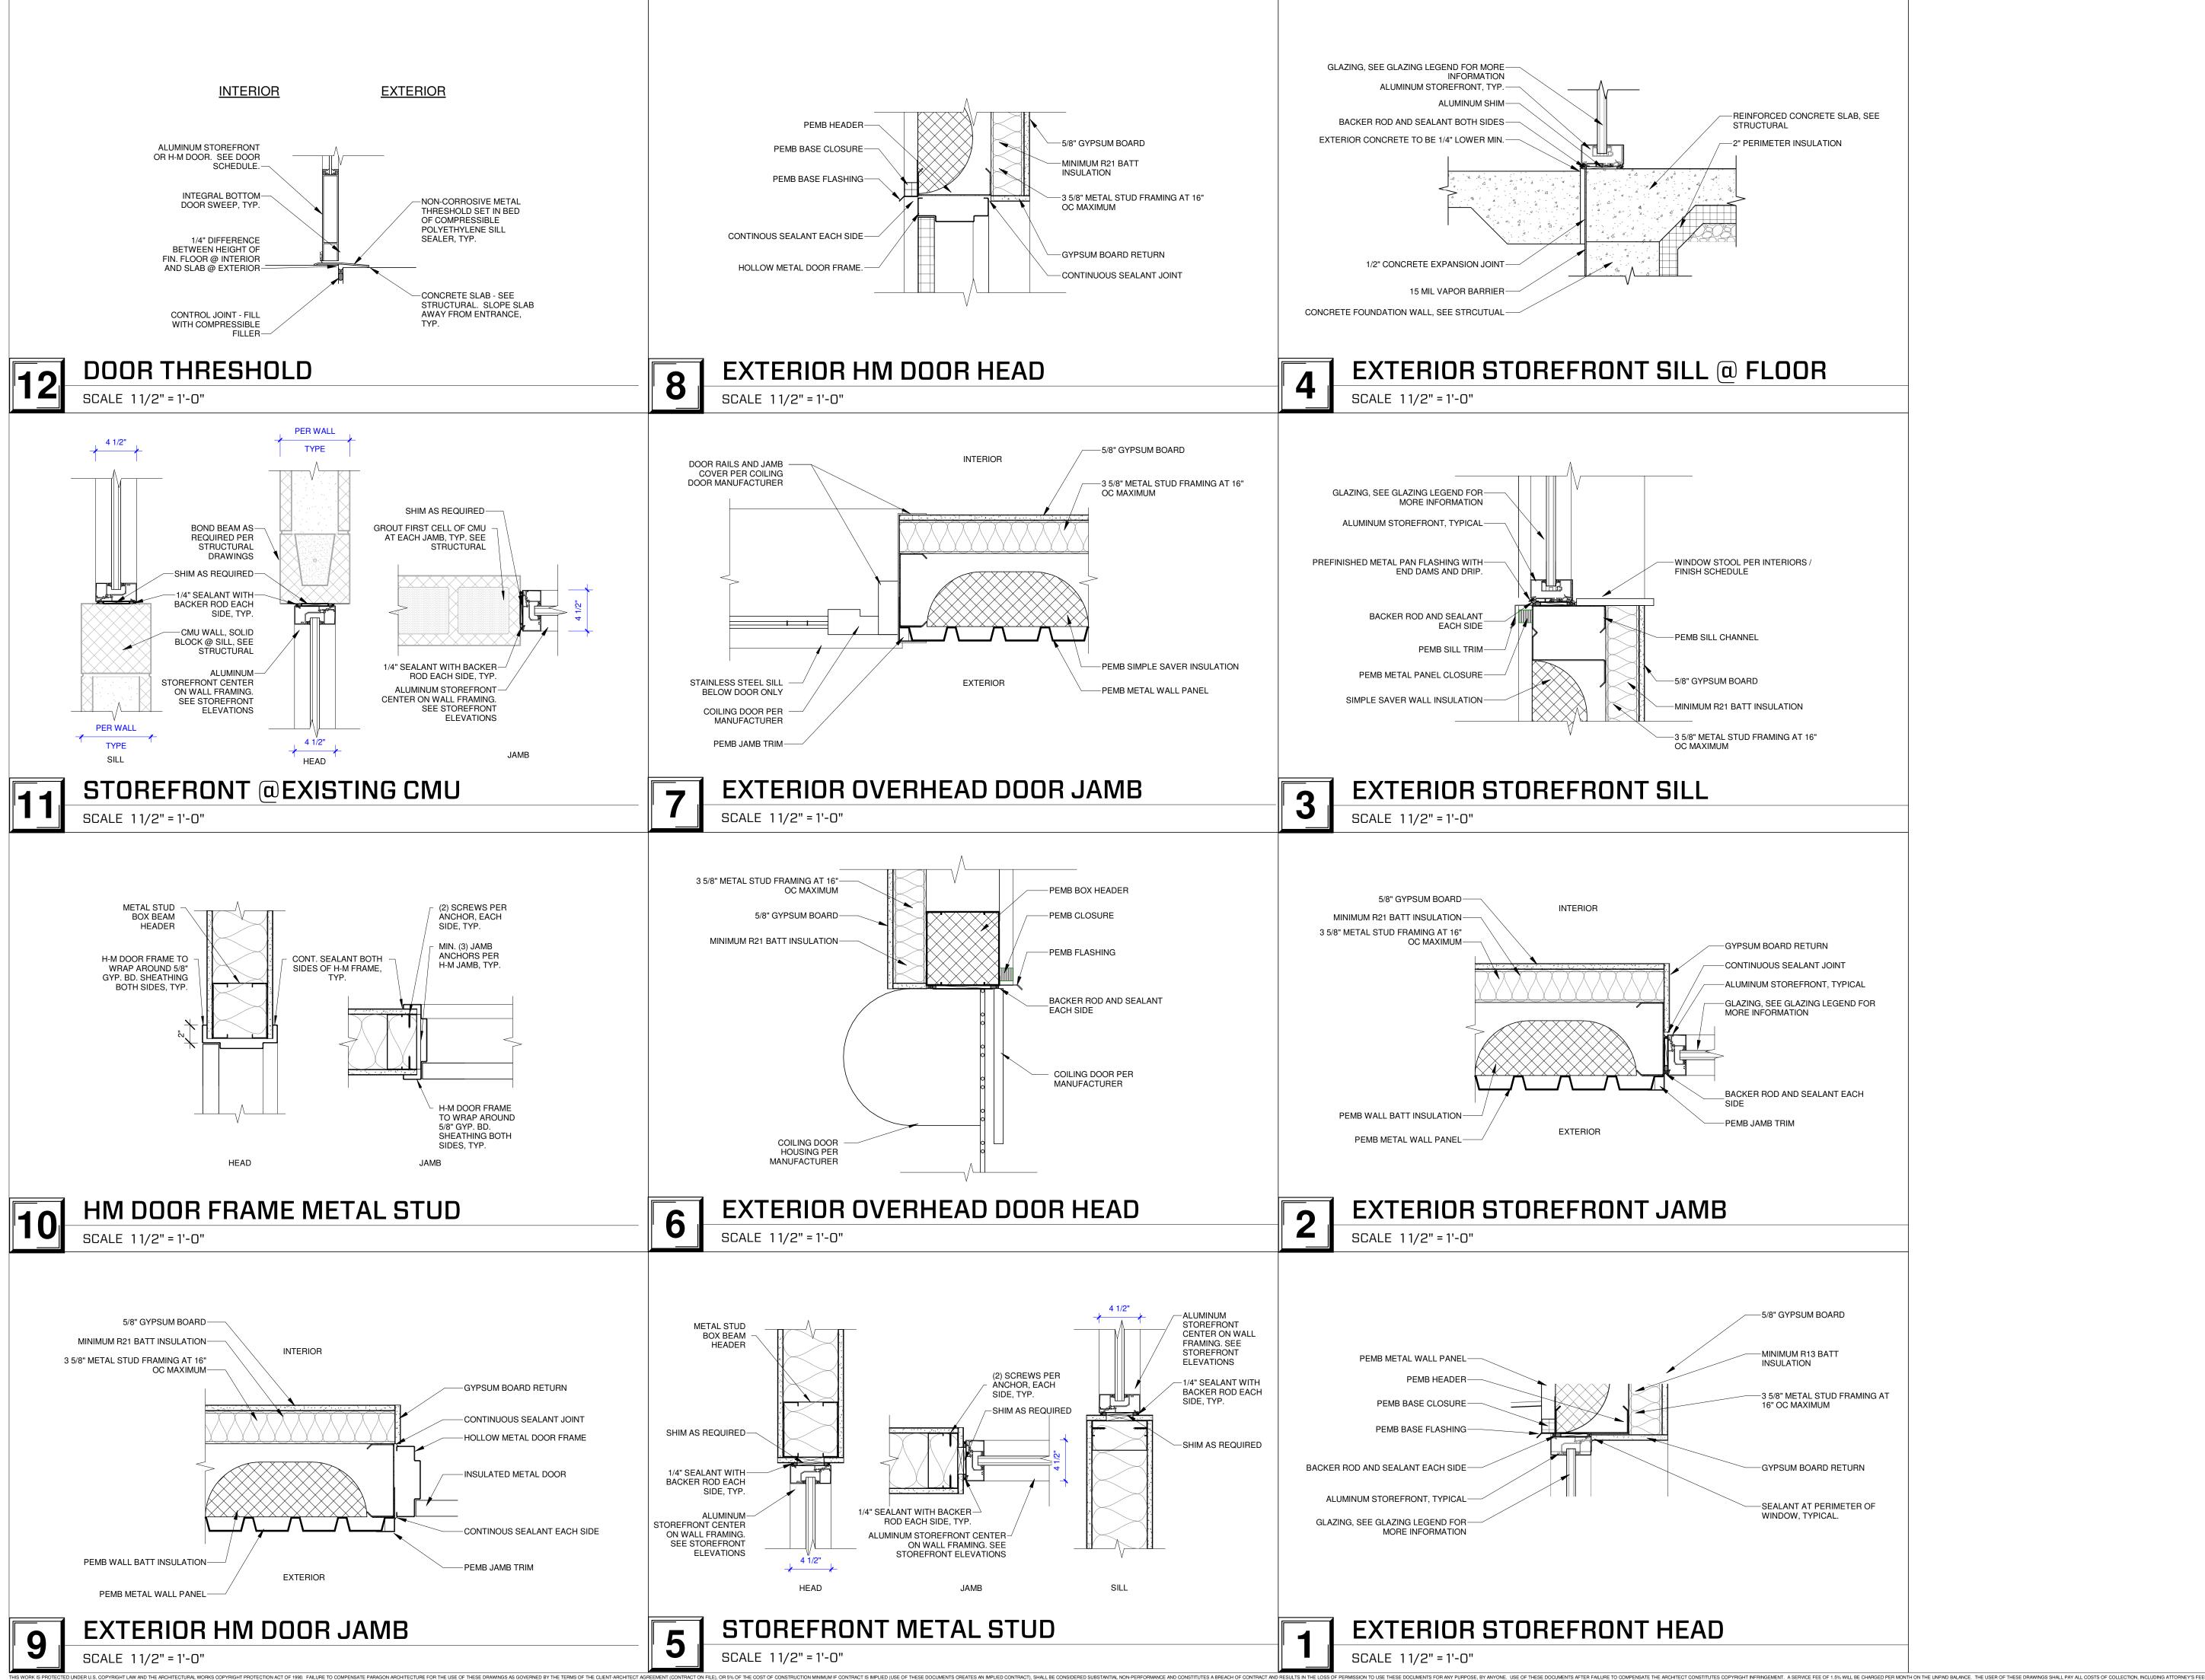

MISSOURI STATE CERTIFICATE OF AUTHORITY NUMBER A-20160004

637 COLLEGE STREET SPRINGFIELD, MO 65806

PH: 417.885.0002 www.paragonarchitecture.com

STRUCTURAL ENGINEER RTM ENGINEERING CONSULTANTS 3045 S KANSAS EXPY SPRINGFIELD, MO 65807 417-708-9315 MEP ENGINEER RTM ENGINEERING CONSULTANTS 3333 E BATTLEFIELD RD SUITE 1000 SPRINGFIELD, MO 65804 417-881-0020 CIVIL ENGINEER OLSSON 550 E ST. LOUIS ST SPRINGFIELD, MO 65806 417-890-8802 CONSTRUCTION MANAGER RE SMITH CONSTRUCTION COMPANY 1036 W 2ND ST JOPLIN, MO 64801 417-623-4545



COPYRIGHT 2023© THESE PRINTS ARE THE PROPERTY OF PARAGON ARCHITECTURE, LLC AND SHALL BE USED ONLY FOR THE PROJECT REFERENCE BELOW


REVISION SCHEDULE


S \vdash ſ A ORMING Ŭ С Ш Δ . . S Т Ш SSVIL КШ \dot{O} PROJECT ARCHITECT: JAY DRAWN BY: TW, TD, KW CHECKED BY: KW, JS, JAY PROJECT NUMBER: 21-620 DATE: 2023.05.17


OPENING DETAILS


SHEET NUMBER:

A6-1

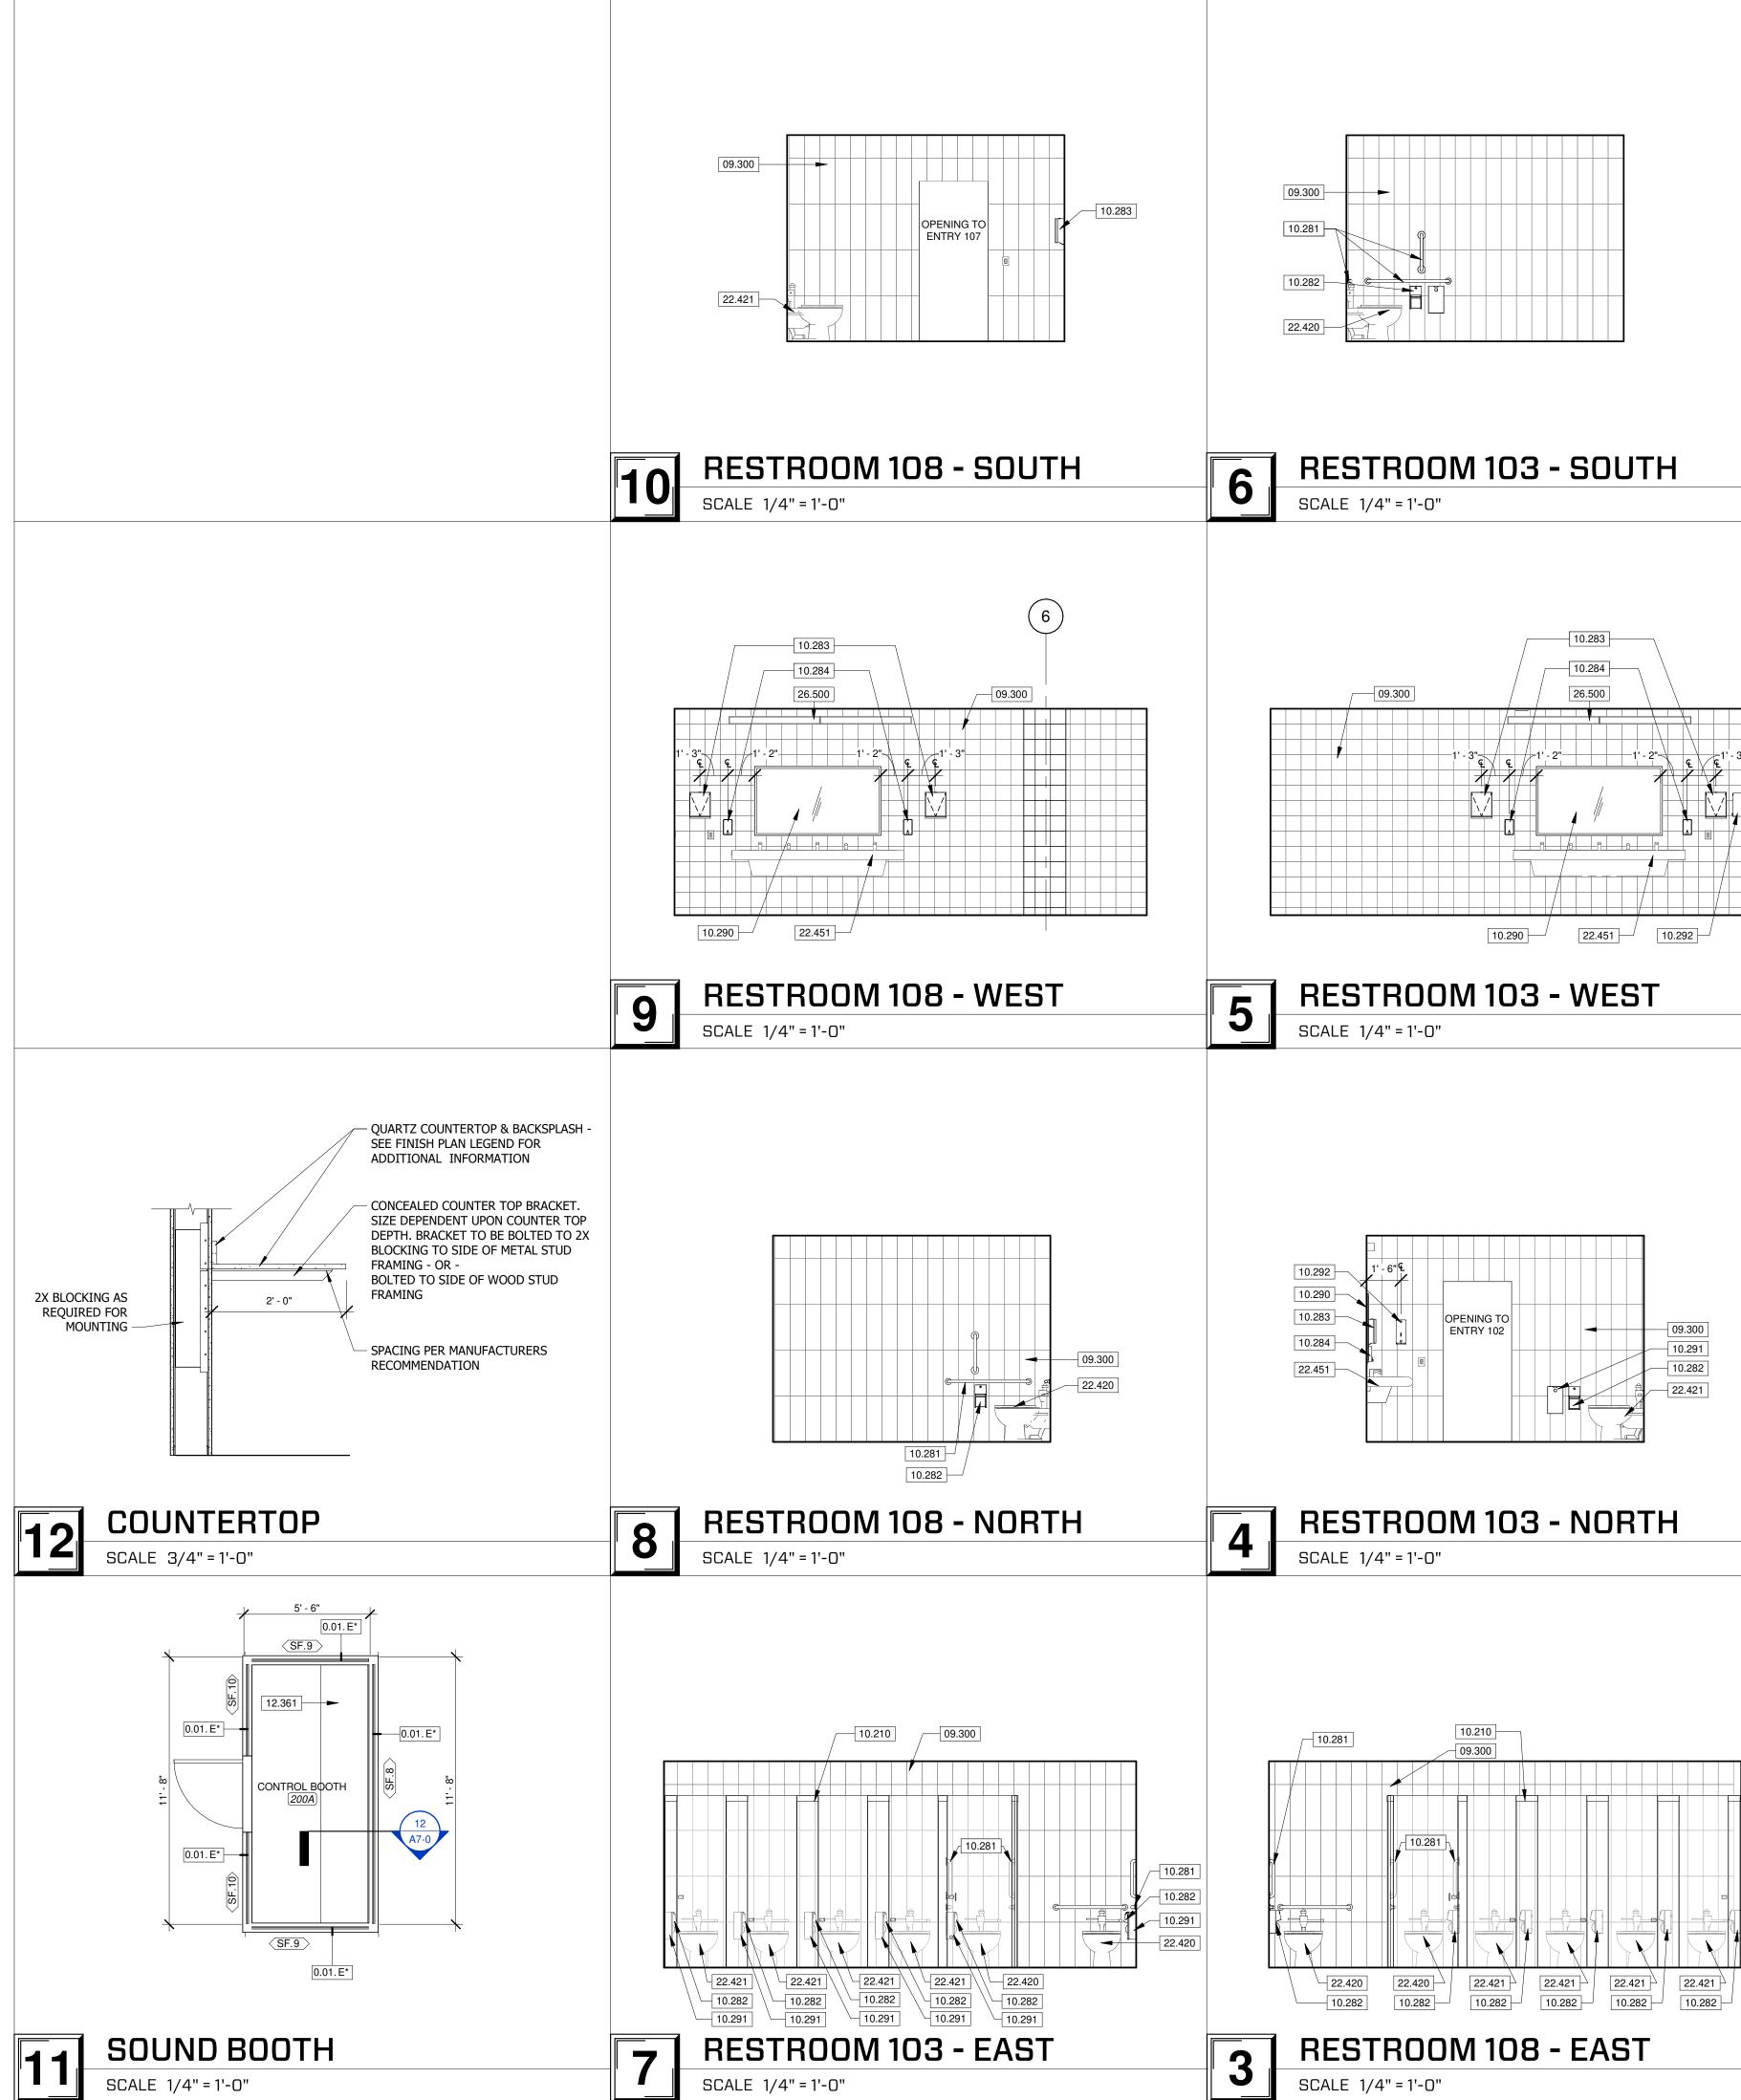

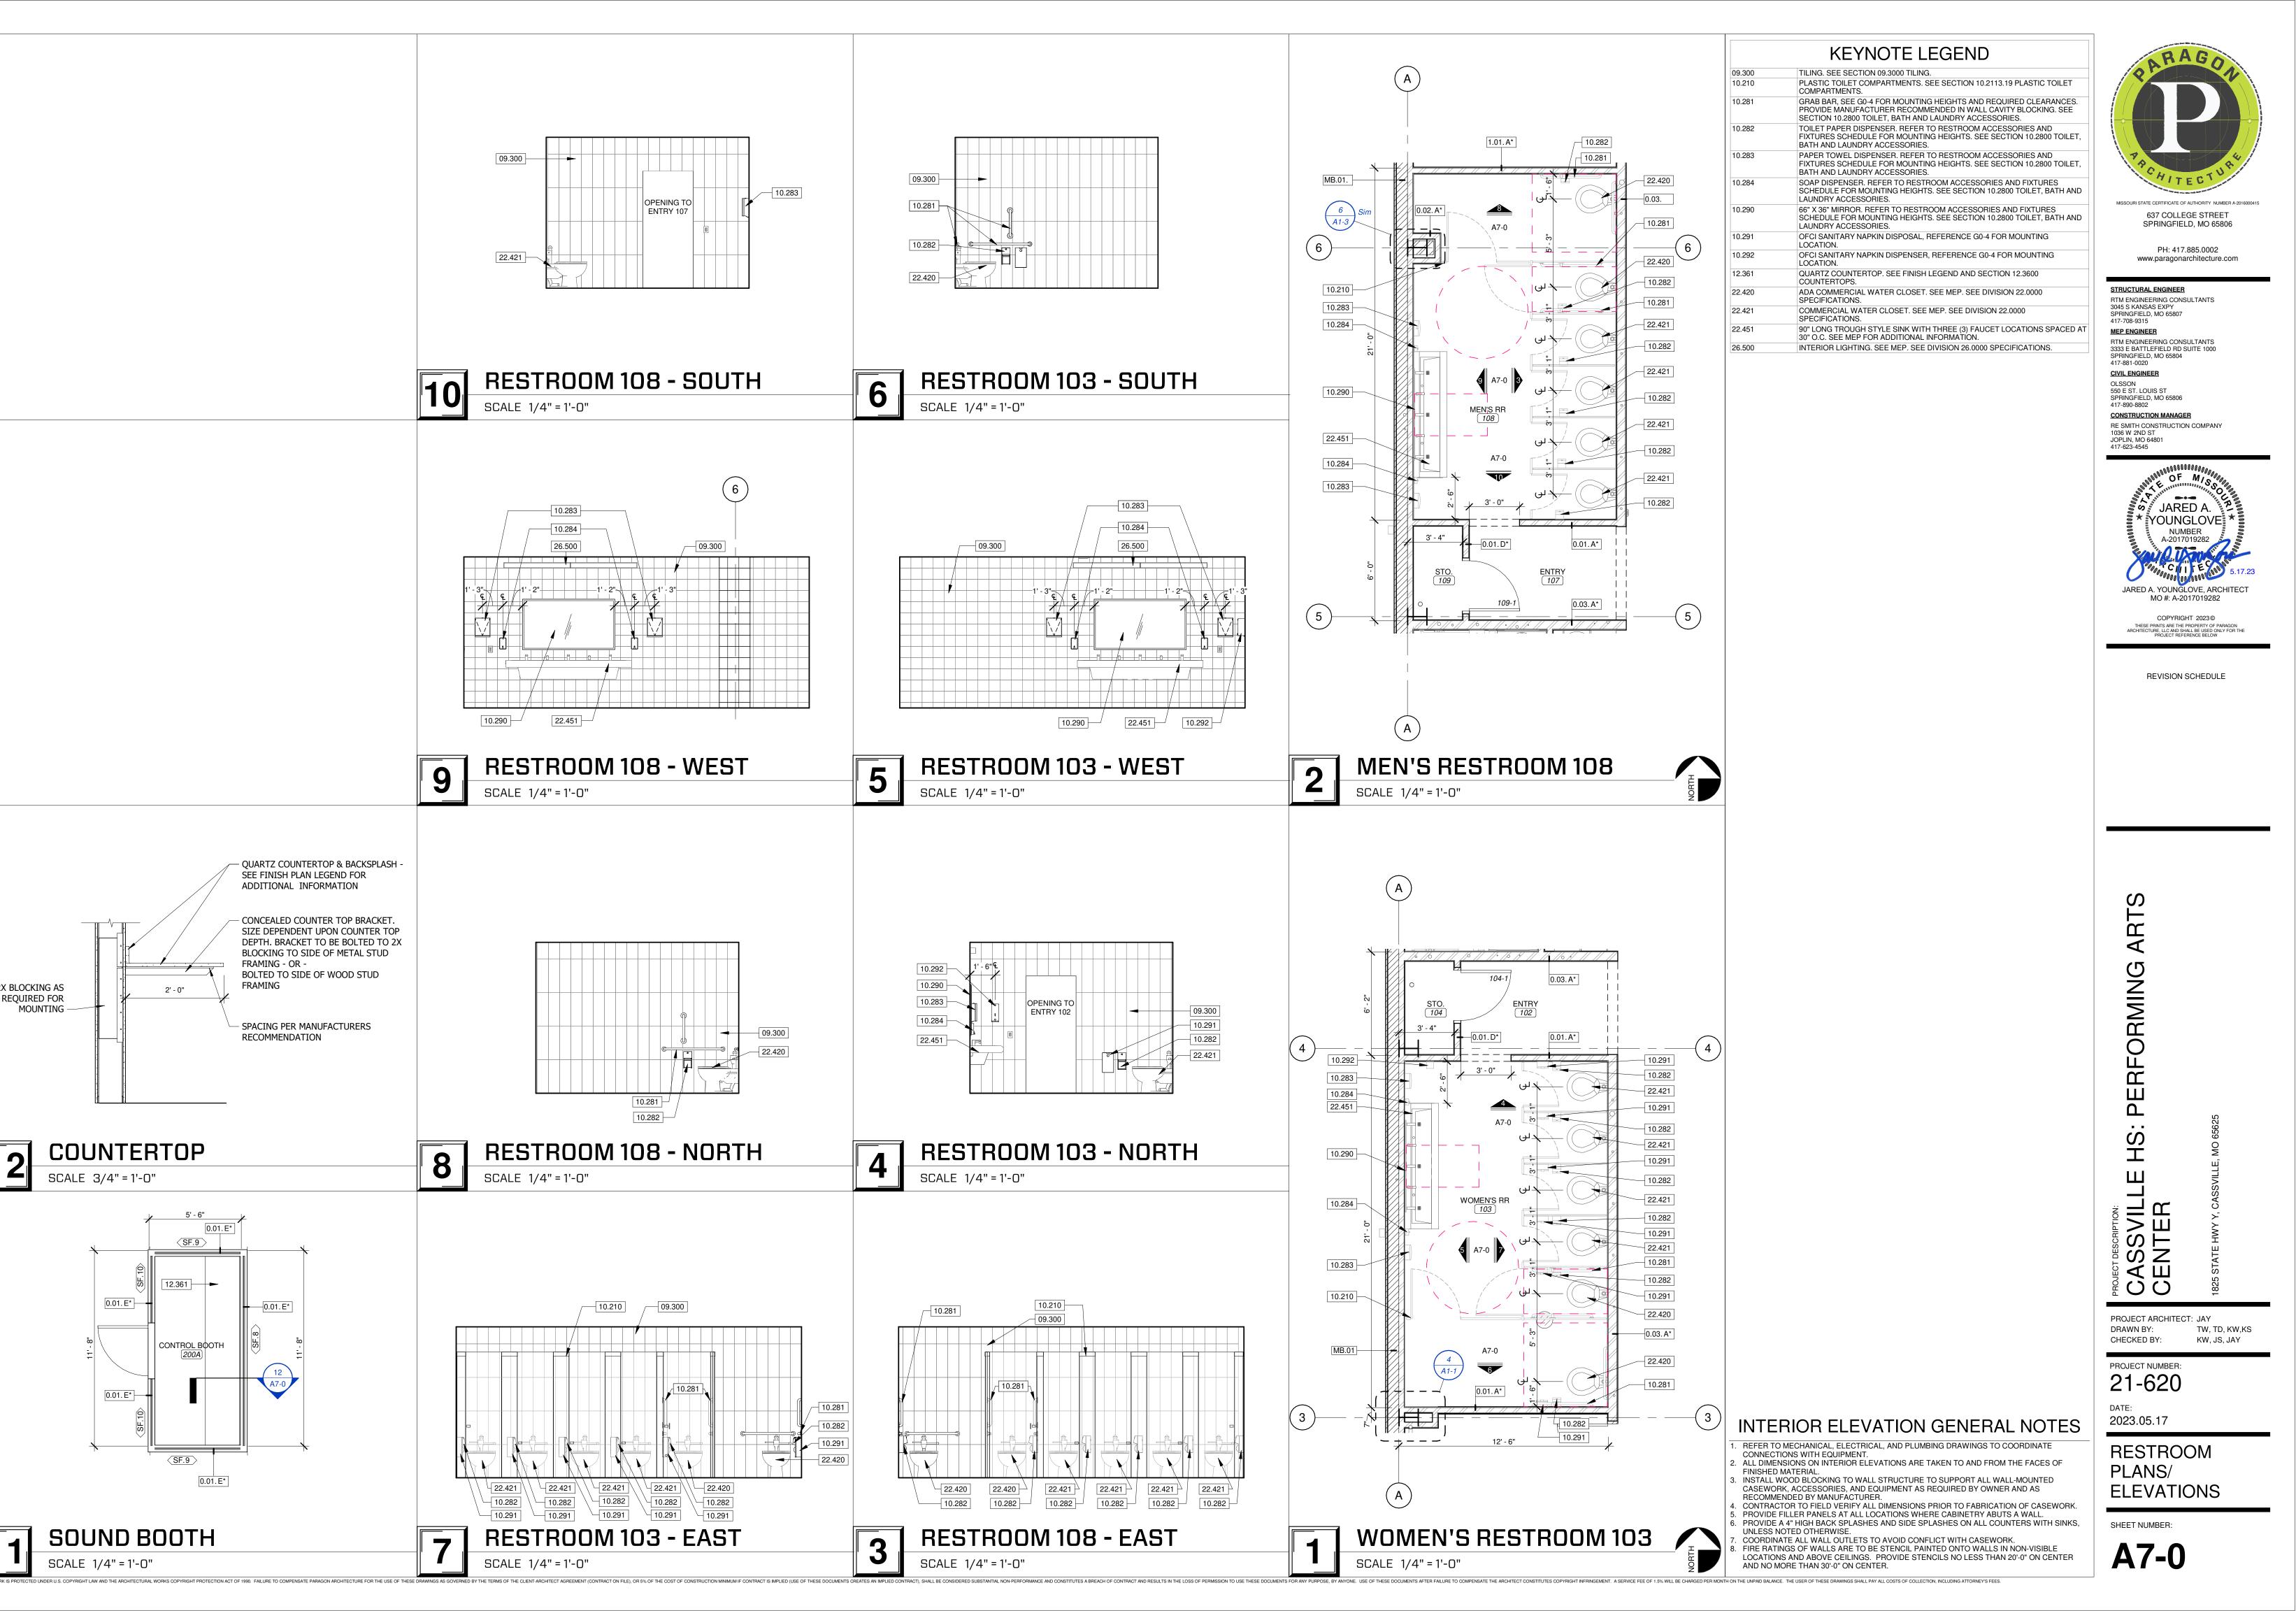


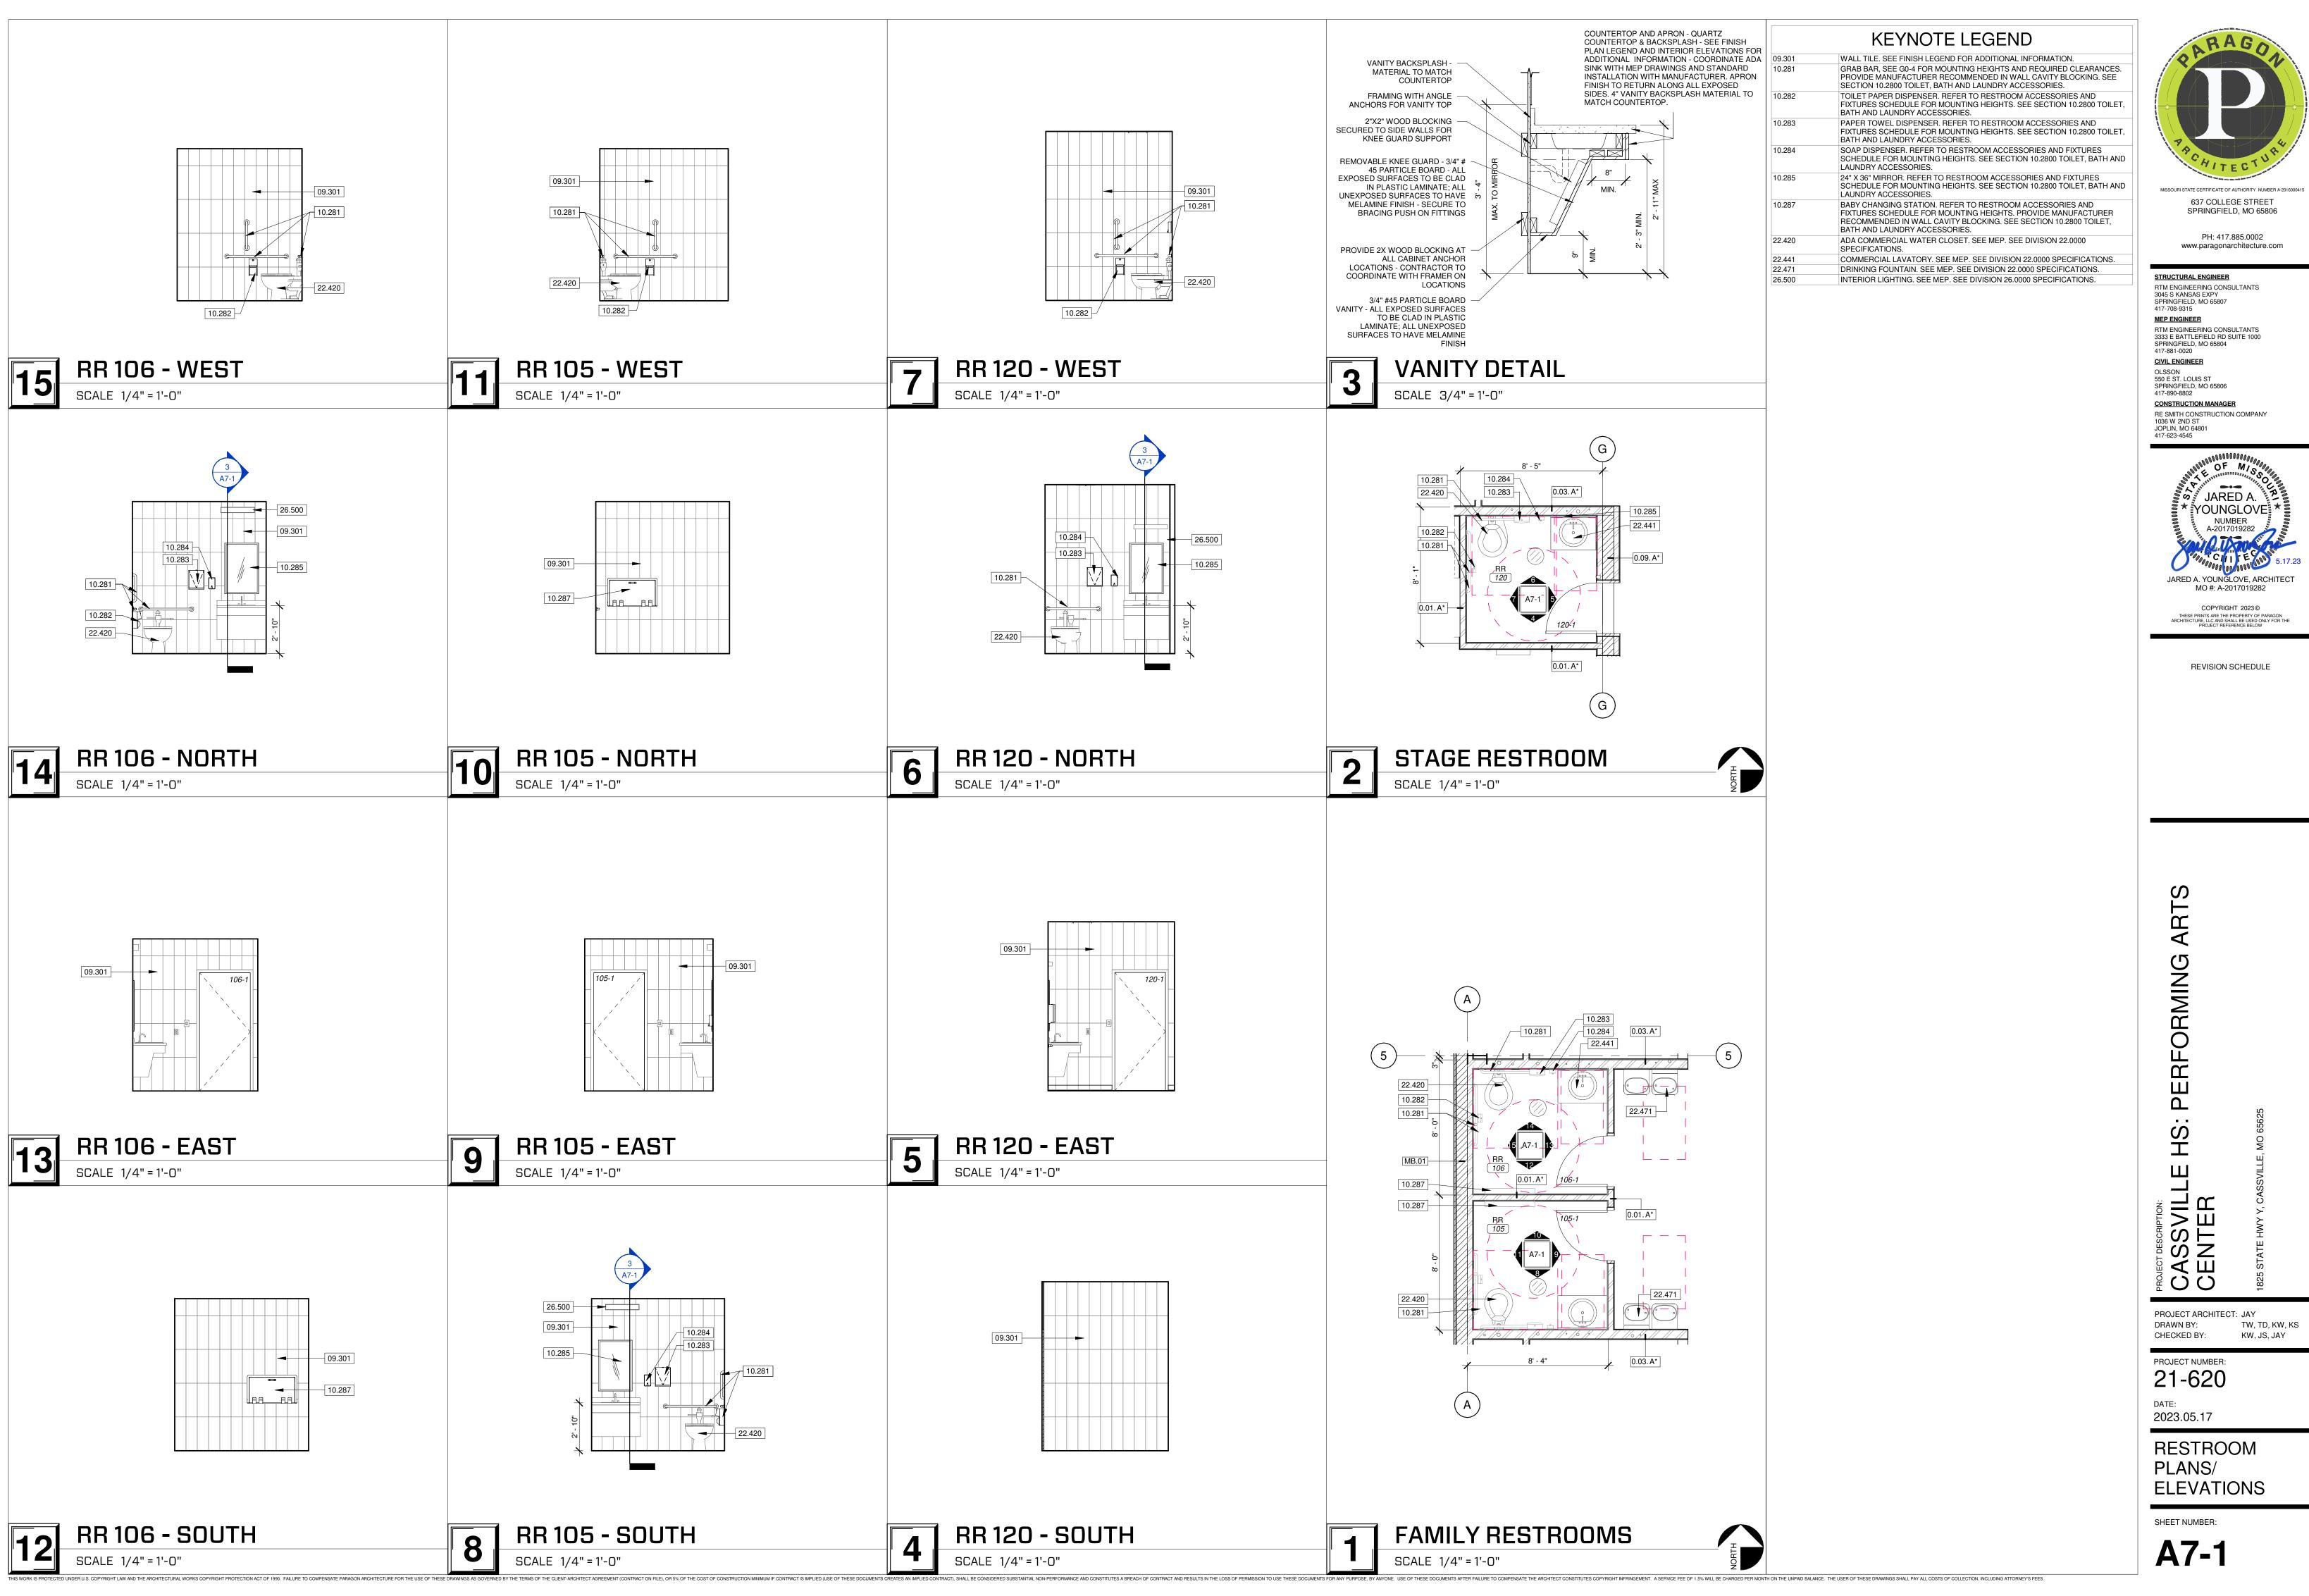


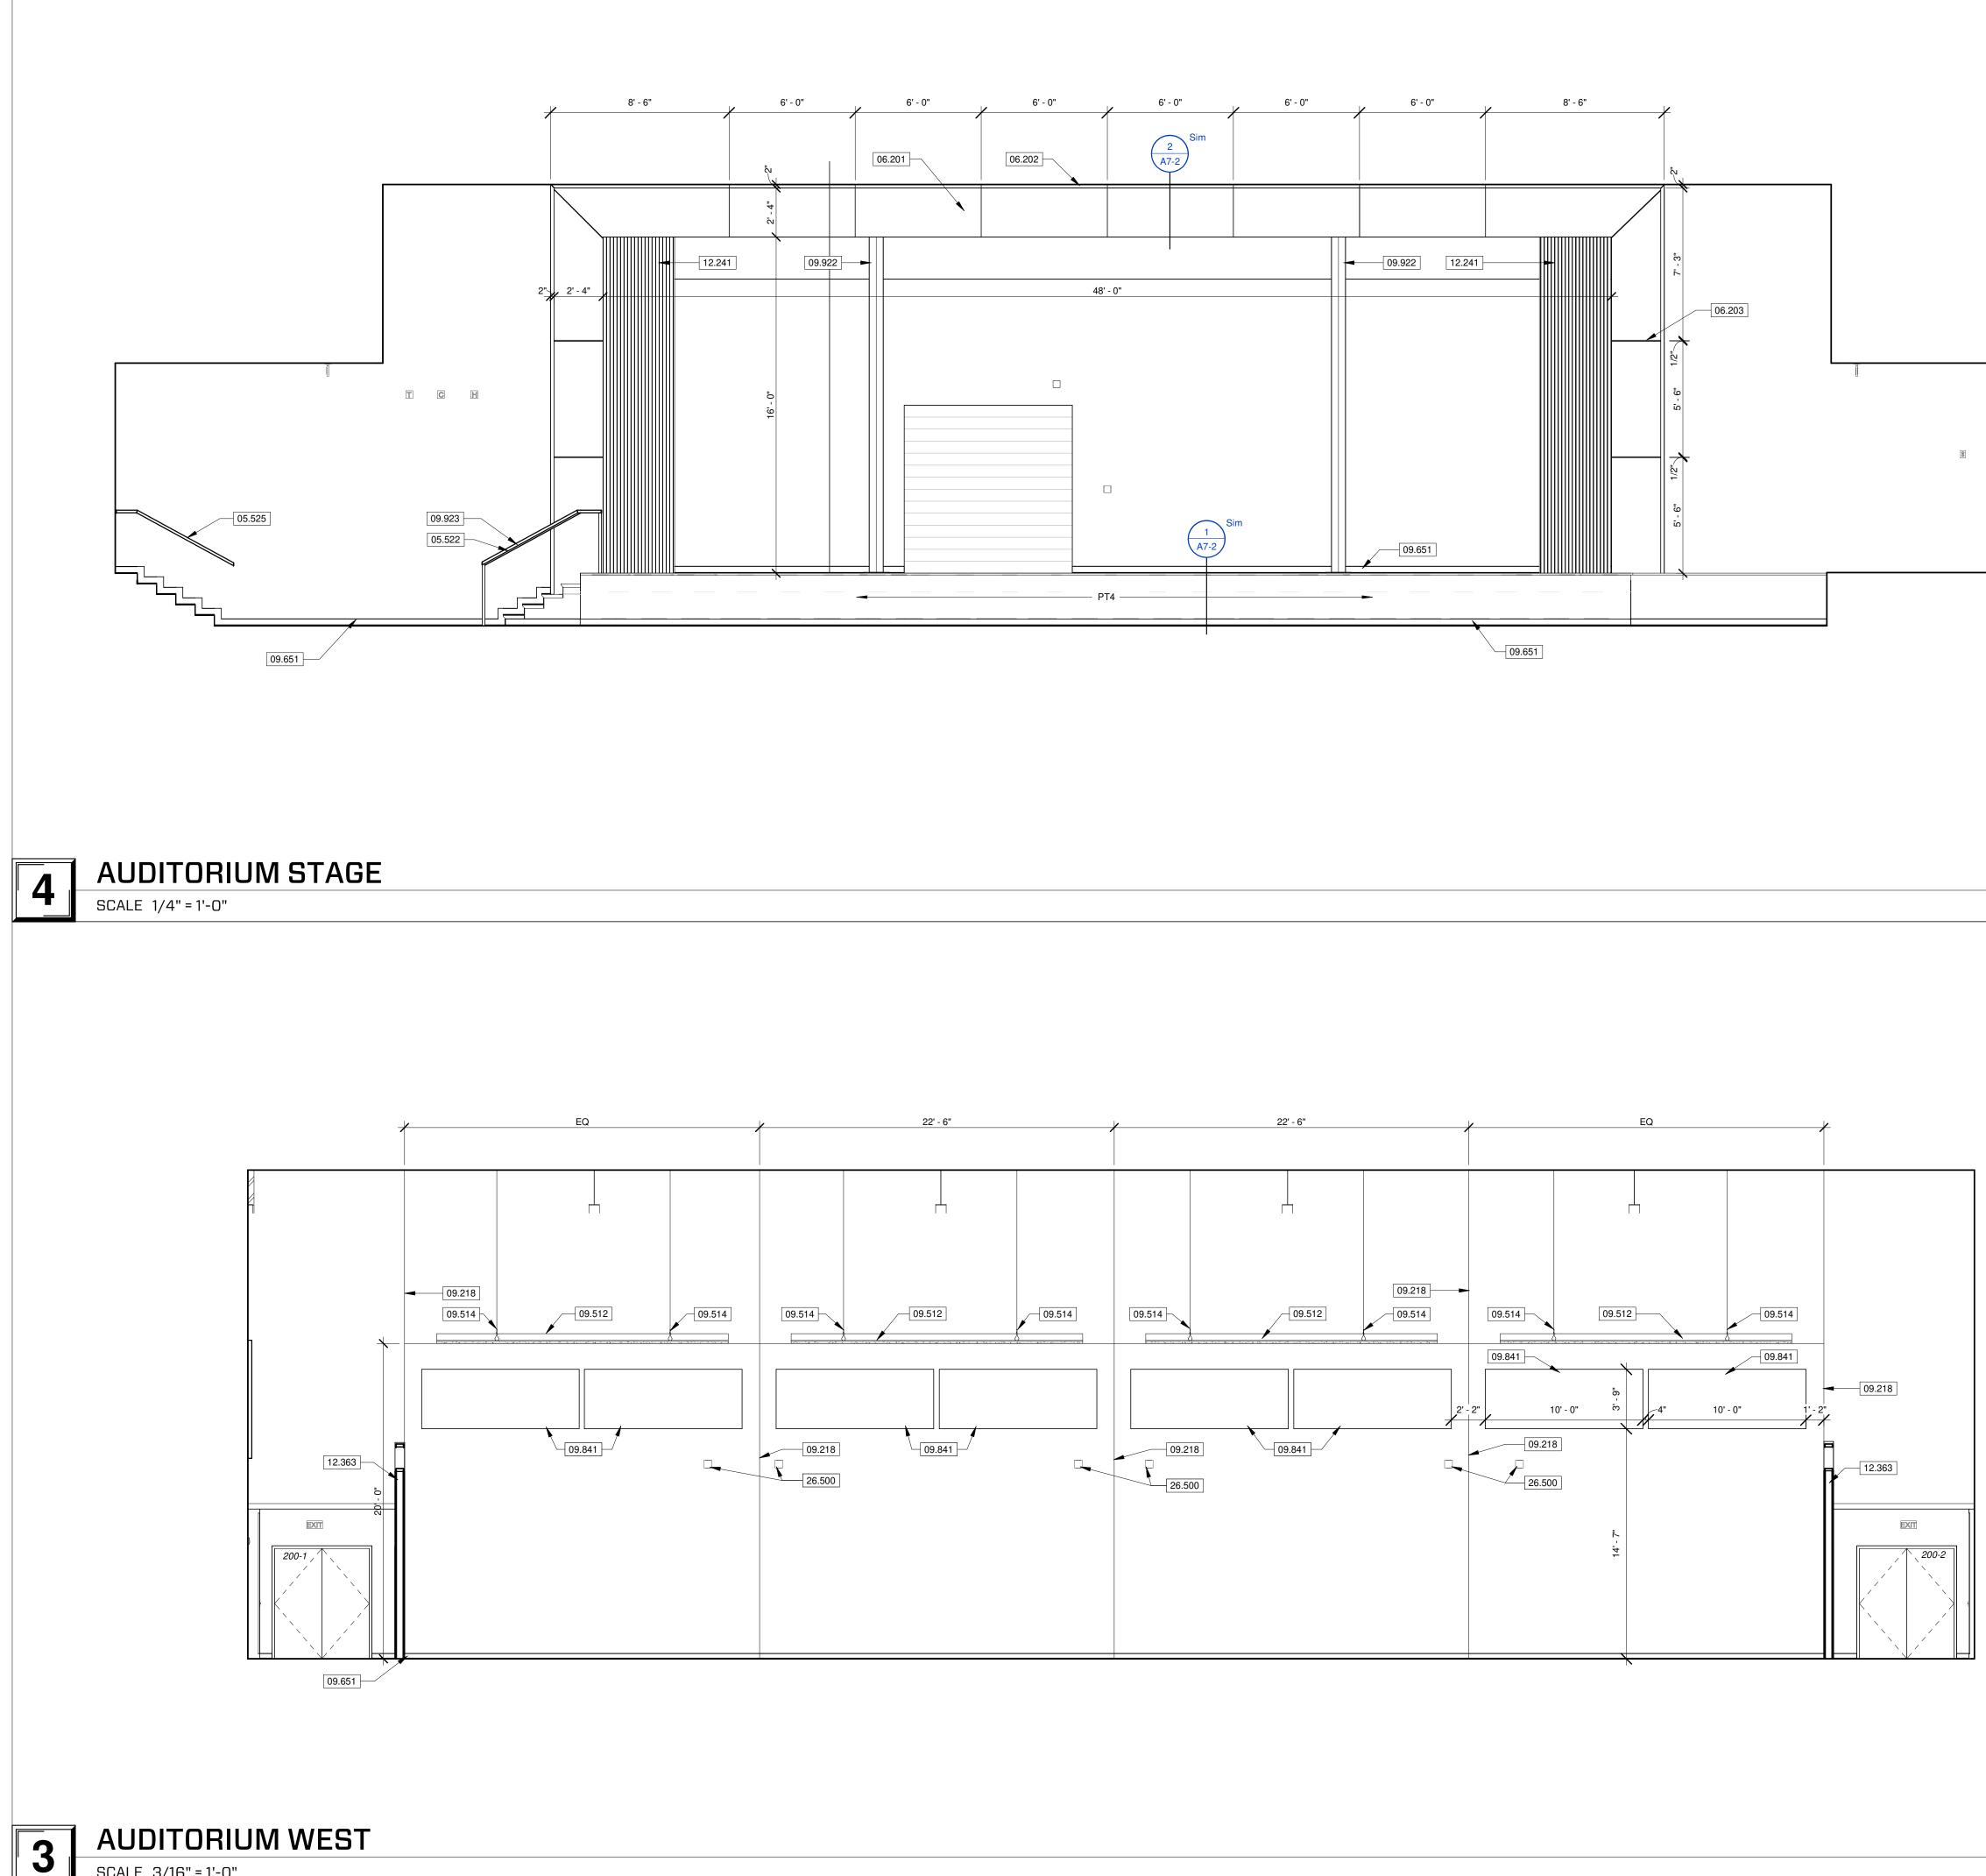


SCALE 3/16" = 1'-0" SCALE 1/2" = 1'-0"

	KEYNOTE LEGEND
03.301	REINFORCED CONCRETE SLAB. SEE STRUCTURAL. SEE SECTION 03.300 CAST-IN-PLACE CONCRETE.
05.121	STEEL JOIST FRAMING. SEE STRUCTURAL. SEE SECTION 05.1200 STRUCTURAL STEEL FRAMING.
05.401	METAL STUD FRAMING AT 16" ON CENTER MAXIMUM. SEE STRUCTURAL FOR LOAD-BEARING STUDS. SEE SECTION 05.4000 COLD-FORMED METAL FRAMING.
05.522	PRIMED/PAINTED 1-1/2" DIAMETER PIPE RAILING. MAINTAIN 1-1/2" CLEARANCE BETWEEN HANDRAILS AND ANY OBJECT. SEE 3/A5-6 FOR CONNECTION INFORMATION. SEE SECTION 05.5213 PIPE AND TUBE HANDRAILS.
05.525	PRIMED/PAINTED 1-1/2" DIAMETER PIPE HANDRAIL. MOUNT TO ADJACENT WALL MAINTAIN 1-1/2" CLEARANCE BETWEEN ANY OBJECT. RETURN HANDRAIL TO WALL AT EACH END. SEE SECTION 05.5213 PIPE AND TUBE HANDRAILS.
06.108	FIRE RETARDANT PLYWOOD SHEATHING. SEE STRUCTURAL. SEE SECTION 06.1000 ROUGH CARPENTRY.
06.114	2 LAYERS OF 3/4" FIRE TREATED PLYWOOD. SEE SECTION 06.1000 ROUGH CARPENTRY.
06.201	GRADE A BIRCH WOOD PANELS. PROVIDE FINISHED EDGES. STAINED TO MATCH PLAM1. SEE SECTION 06.2000 FINISH CARPENTRY.
06.202	GRADE A BIRCH WOOD TRIM MOLDING PAINTED: PT2.
06.203	GRADE A BIRCH WOOD PANEL 1/2" JOINT.
06.204	GRADE A BIRCH WOOD PANELS TO WRAP PROSCENIUM OPENING, MITERED EDGES.
06.206	GRADE A BIRCH WOOD FLOOR CORNER PROTECTION PAINTED: PT2.
09.214	5/8" GYPSUM BOARD. SEE SECTION 09.2116 GYPSUM BOARD ASSEMBLIES.
09.218	GYPSUM BOARD CONTROL JOINT. SEE SECTION 09.2110 GYPSUM BOARD ASSEMBLIES.
09.512	SUSPENDED ACOUSTICAL CEILING. EDGES FINISHED WITH 6" FLAT METAL PAN SEE SPECIFICATIONS FOR ADDITIONAL INFORMATION.
09.514	SUSPENSION WIRES ATTACHED TO STRUCTURE ABOVE.
09.651	RESILIENT VINYL BASE. SEE FINISH SCHEDULE AND FINISH PLANS FOR MORE INFORMATION. SEE SECTION 09.6500 RESILIENT FLOORING.
09.841	SOUND ABSORBING WALL UNITS. SEE FINISH PLAN LEGEND FOR PRODUCT DETAILS. SEE SECTION 09.8430 SOUND ABSORBING WALL AND CEILING UNITS.
09.922	EXPOSED PEMB FRAME TO BE PAINTED PT4. REFER TO THE FINISH PLAN LEGEND FOR ADDITIONAL INFORMATION.
09.923	HANDRAIL PAINTED PT8. REFER TO THE FINISH PLAN LEGEND FOR ADDITIONAL INFORMATION.
12.241	STAGE CURTAIN BY PARAGON 360. COORDINATE PROCUREMENT AND INSTALLATION WITH PARAGON 360.
12.363	SOLID SURFACE WALL CAP, PROVIDE MANUFACTURERS RECOMMENDED SUBSTRATE AND 1/2" OVERHANG ON EACH SIDE.
13.366	PRE-ENGINEERED METAL BUILDING BEAM. SEE SECTION 13.3419 METAL BUILDING SYSTEMS.
26.500	INTERIOR LIGHTING. SEE MEP. SEE DIVISION 26.0000 SPECIFICATIONS.

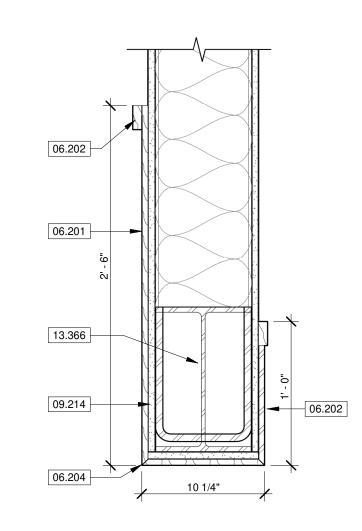

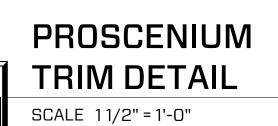

2

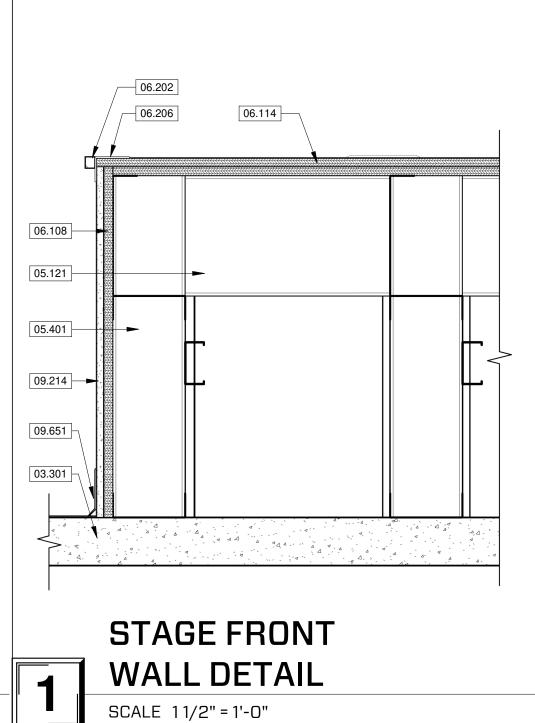



637 COLLEGE STREET SPRINGFIELD, MO 65806

PH: 417.885.0002 www.paragonarchitecture.com

STRUCTURAL ENGINEER RTM ENGINEERING CONSULTANTS 3045 S KANSAS EXPY SPRINGFIELD, MO 65807 417-708-9315 **MEP ENGINEER** RTM ENGINEERING CONSULTANTS 3333 E BATTLEFIELD RD SUITE 1000 SPRINGFIELD, MO 65804 417-881-0020 **DIVL ENGINEER** OLSSON 550 E ST. LOUIS ST SPRINGFIELD, MO 65806 417-890-8802 **CONSTRUCTION MANAGER** RE SMITH CONSTRUCTION COMPANY 1036 W 2ND ST JOPLIN, MO 64801 417-623-4545




COPYRIGHT 2023 THESE PRINTS ARE THE PROPERTY OF PARAGON ARCHITECTURE, LLC AND SHALL BE USED ONLY FOR THE PROJECT REFERENCE BELOW


REVISION SCHEDULE



SHEET NUMBER:

A7-2

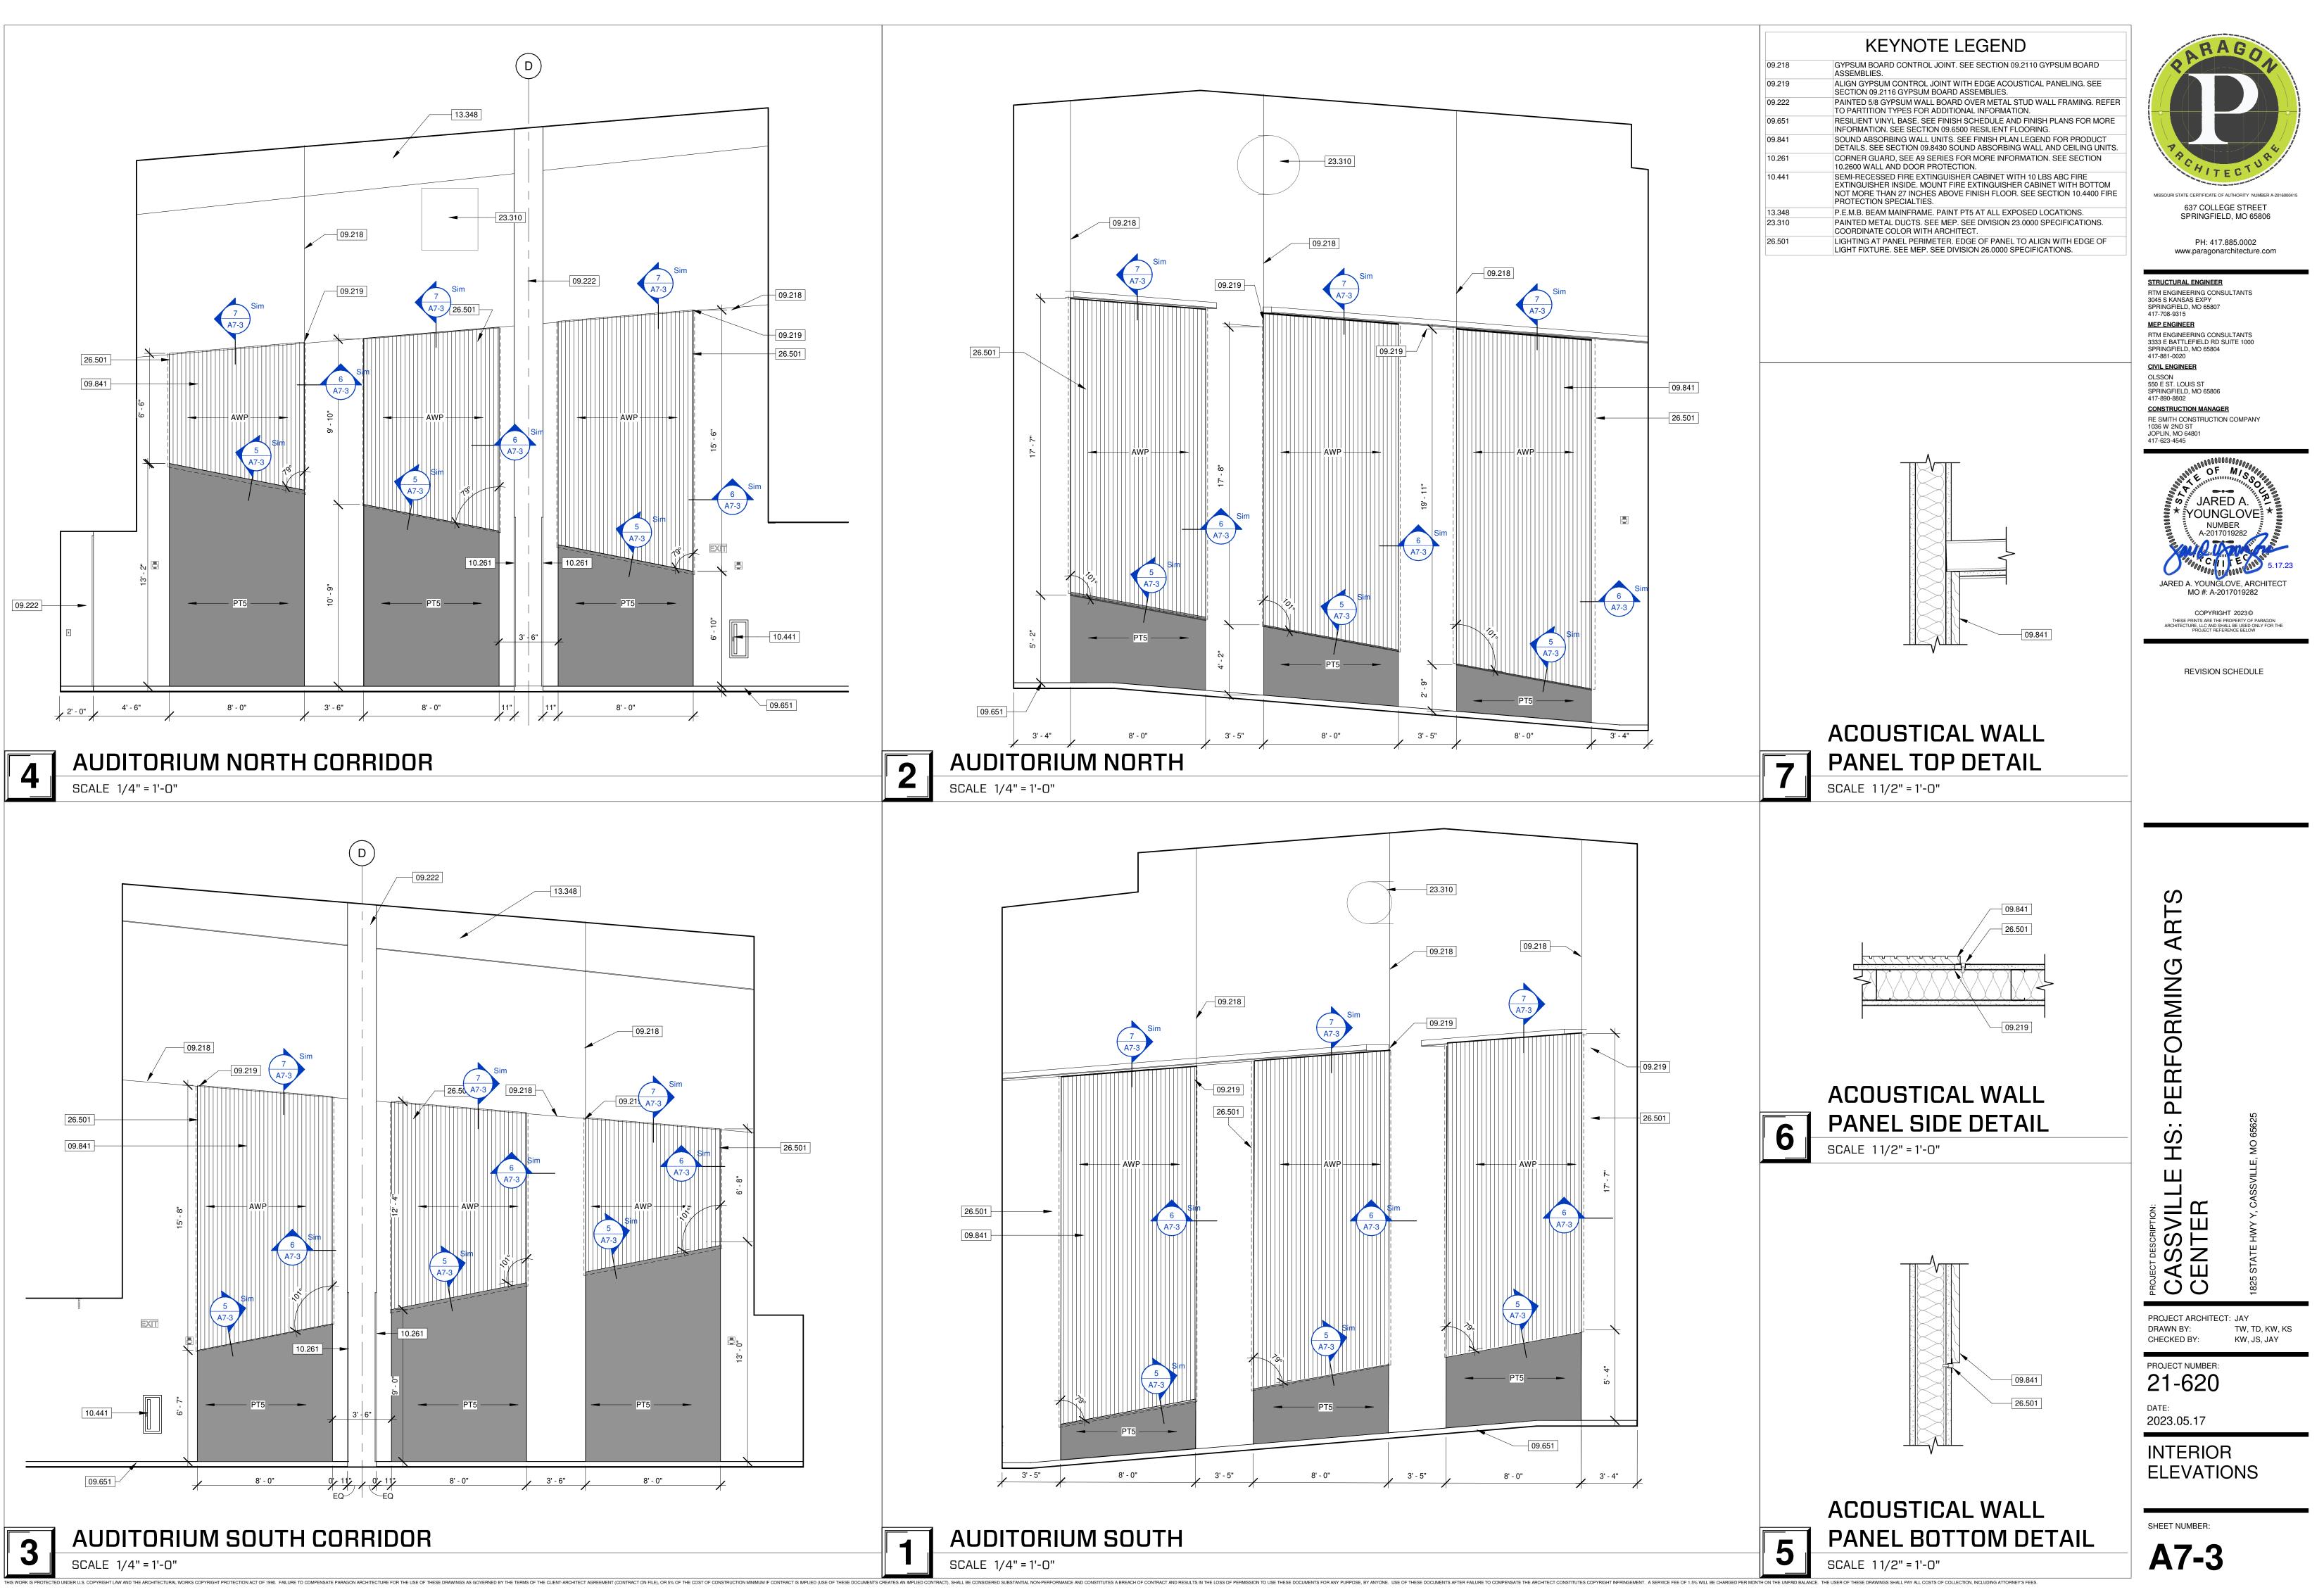

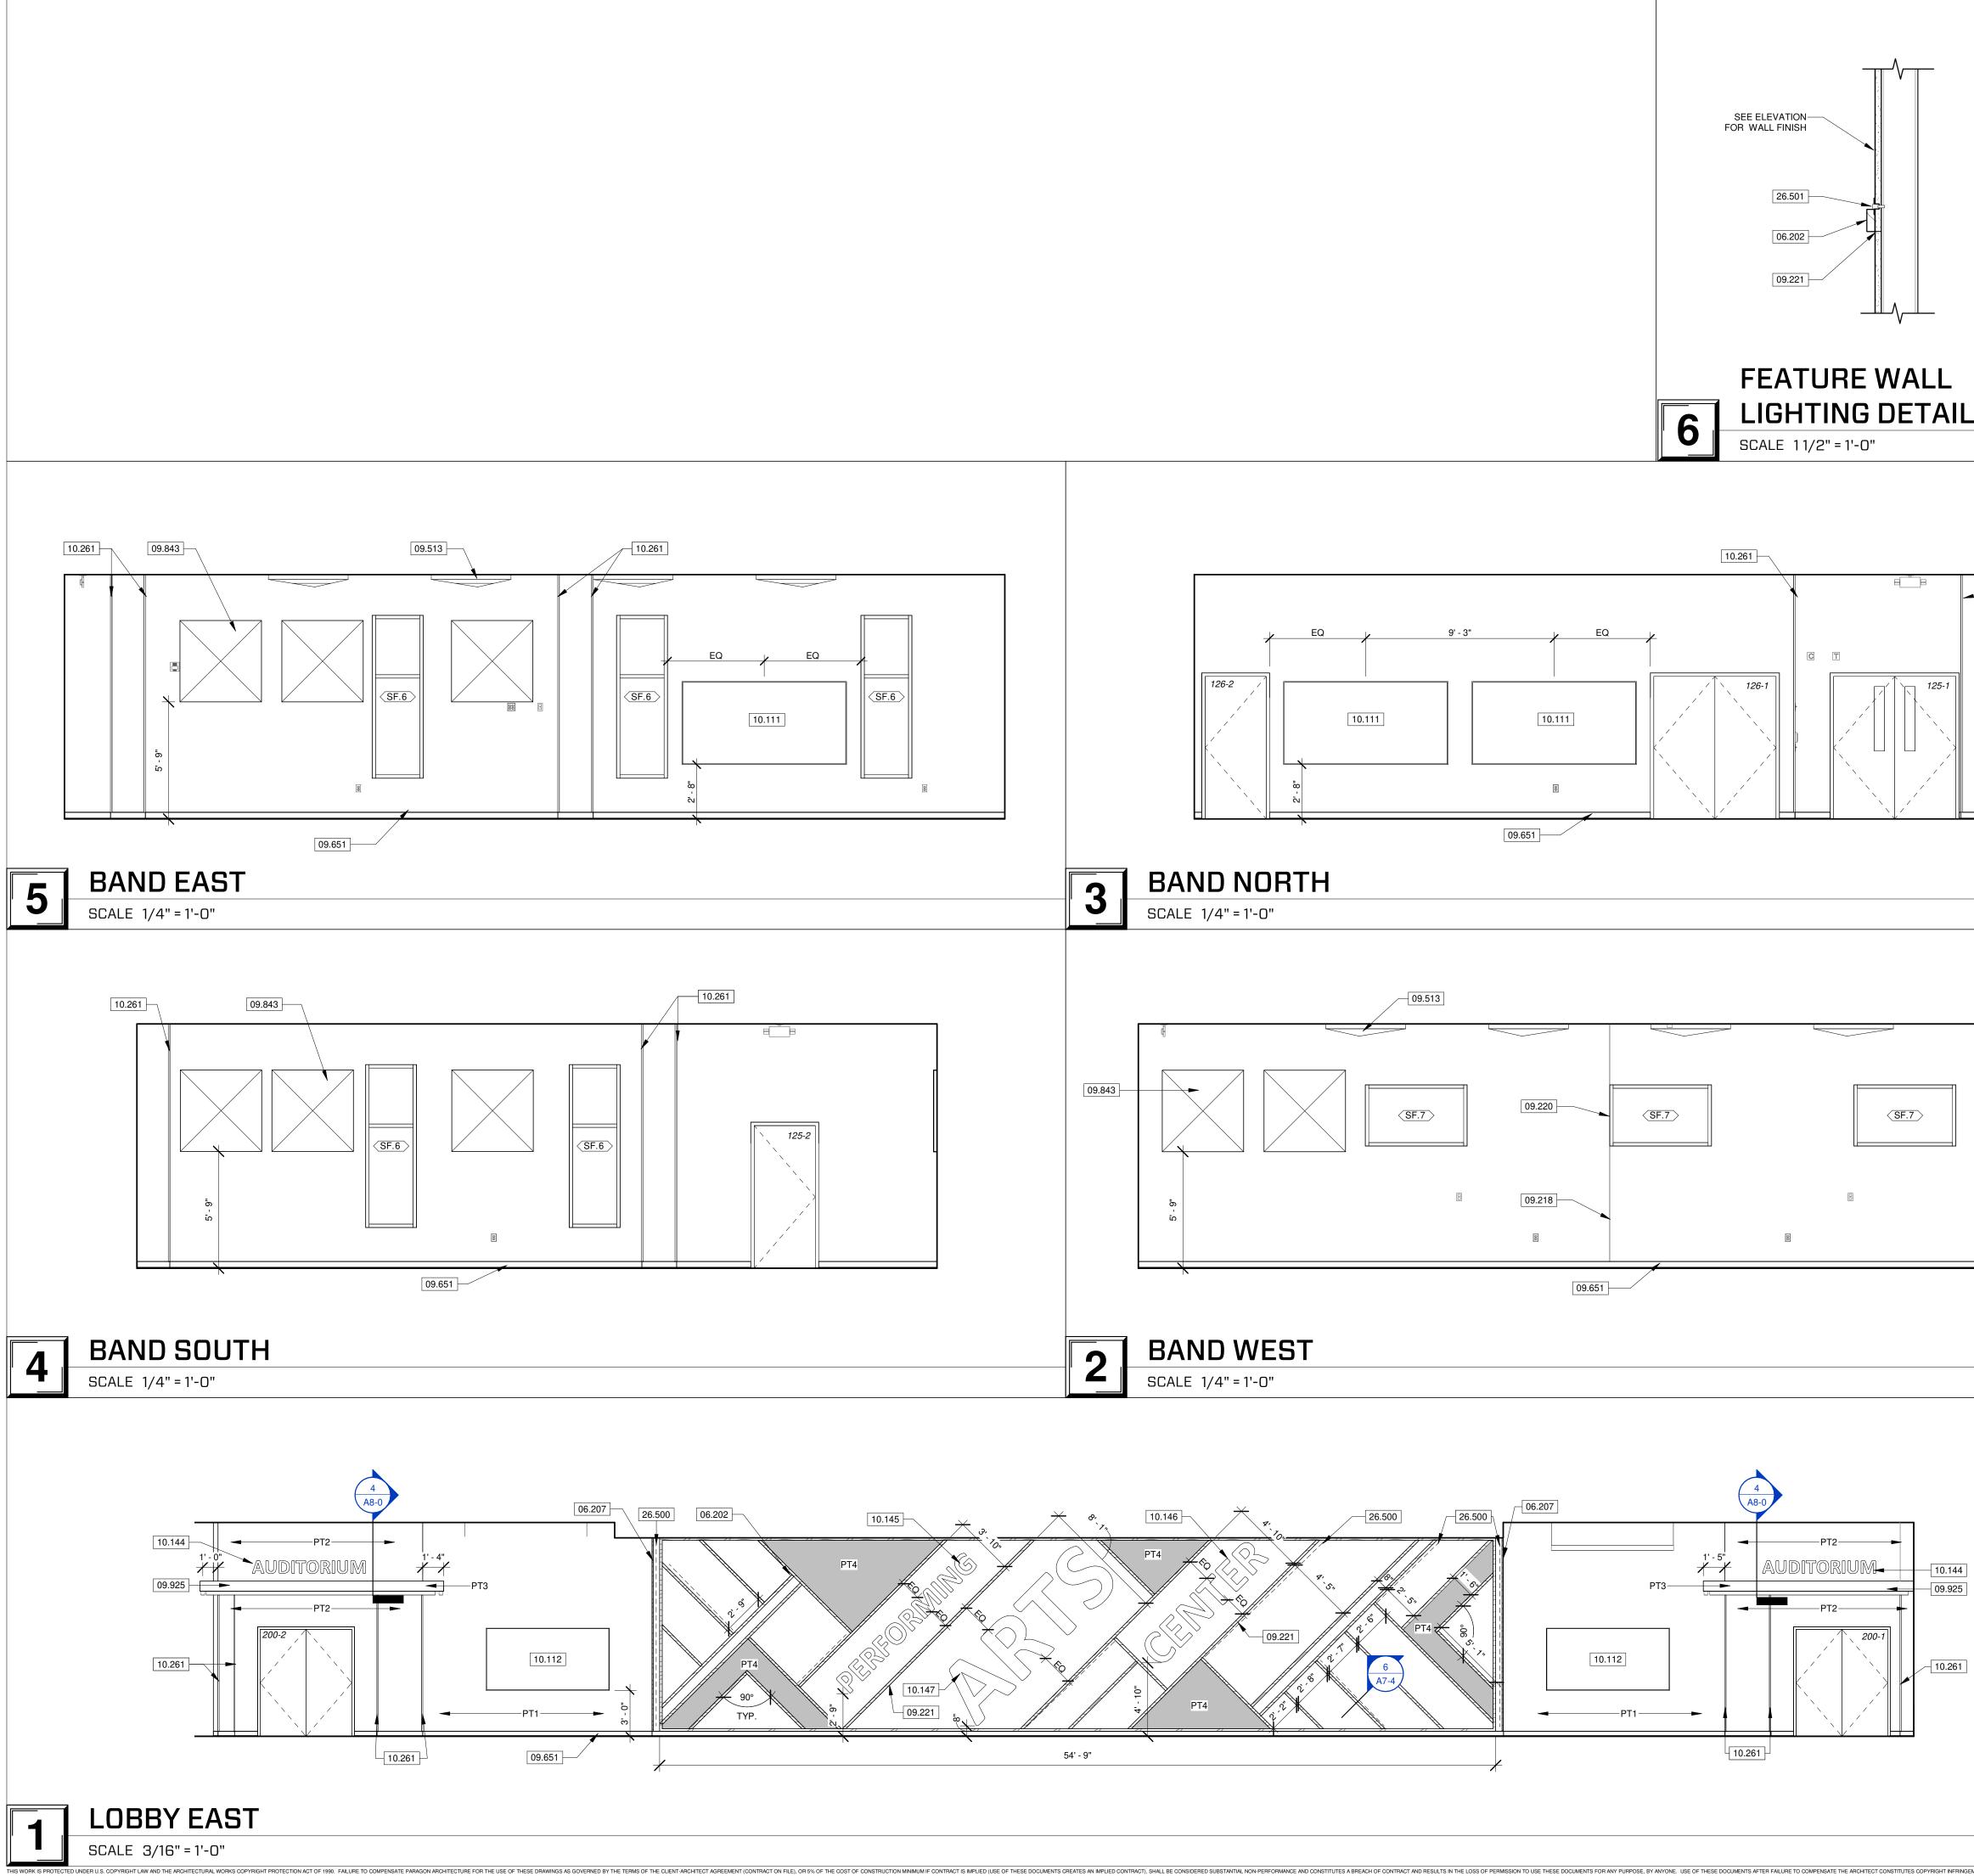

		KEYNOTE LEGEND	RAGO
	06.202	GRADE A BIRCH WOOD TRIM MOLDING PAINTED: PT2.	RARAGON
Π	06.207	GRADE A BIRCH WOOD CORNER WALL PROTECTION PAINTED: PT2. 1" WIDTH ON EACH CORNER. GYPSUM BOARD CONTROL JOINT. SEE SECTION 09.2110 GYPSUM BOARD	
	09.218	ASSEMBLIES. ALIGN GYPSUM CONTROL JOINT WITH EDGE OF STOREFRONT FRAME. SEE	
	09.221	SECTION 09.2116 GYPSUM BOARD ASSEMBLIES. ALIGN GYPSUM CONTROL JOINT WITH EDGE OF FEATURE. SEE SECTION	
	09.513	09.2116 GYPSUM BOARD ASSEMBLIES. BID ALTERNATE: CEILING SOUND DIFFUSER. SEE SECTION 09.5100 ACOUSTICAL CEILINGS. SEE FINISH LEGEND FOR ADDITIONAL INFORMATION.	P P P
	09.651	RESILIENT VINYL BASE. SEE FINISH SCHEDULE AND FINISH PLANS FOR MORE INFORMATION. SEE SECTION 09.6500 RESILIENT FLOORING.	PACHITECTURE
	09.843	BID ALTERNATE: WALL SOUND PYRAMIDAL DIFFUSER. SEE FINISH PLAN LEGEND FOR ADDITIONAL INFORMATION. SEE SECTION 09.8430 SOUND-ABSORBING WALL AND CEILING UNITS.	MISSOURI STATE CERTIFICATE OF AUTHORITY NUMBER A-2016000415
	09.925	PAINT PT3 ON ALL EXPOSED FACES OF SOFFIT. 4' X 8' WHITEBOARD, SEE SECTION 10.1100 VISUAL DISPLAY UNITS.	637 COLLEGE STREET SPRINGFIELD, MO 65806
	10.112	WALL MOUNTED TV AND MOUNTING BRACKETS, OFCI. PROVIDE IN WALL CAVITY BLOCKING.	PH: 417.885.0002
	10.144	DIMENSIONAL LETTERING. BASIS-OF-DESIGN: WOODLAND MANUFACTURING, MDF PAINTED LETTERS. 10" HEIGHT. FONT: CUSTOM. PAINT: CUSTOM, PT7. PROVIDE PAPER TEMPLATE. COORDINATE WITH OWNER/ ARCHITECT.	www.paragonarchitecture.com
	10.145	DIMENSIONAL LETTERING. BASIS-OF-DESIGN: WOODLAND MANUFACTURING, MDF PAINTED LETTERS. 18" HEIGHT. FONT: CUSTOM. PAINT: CUSTOM, PT2.	STRUCTURAL ENGINEER RTM ENGINEERING CONSULTANTS
	10.146	PROVIDE PAPER TEMPLATE. COORDINATE WITH OWNER/ ARCHITECT. DIMENSIONAL LETTERING. BASIS-OF-DESIGN: WOODLAND MANUFACTURING, MDF PAINTED LETTERS. 24" HEIGHT. FONT: CUSTOM. PAINT: CUSTOM, PT2.	3045 S KANSAS EXPY SPRINGFIELD, MO 65807 417-708-9315
	10.147	PROVIDE PAPER TEMPLATE. COORDINATE WITH OWNER/ ARCHITECT. DIMENSIONAL LETTERING. BASIS-OF-DESIGN: WOODLAND MANUFACTURING,	MEP ENGINEER RTM ENGINEERING CONSULTANTS
ALL	10.261	MDF PAINTED LETTERS. 48" HEIGHT. FONT: CUSTOM. PAINT: CUSTOM, PT2. PROVIDE PAPER TEMPLATE. COORDINATE WITH OWNER/ ARCHITECT. CORNER GUARD. SEE A9 SERIES FOR MORE INFORMATION. SEE SECTION	3333 E BATTLEFIELD RD SUITE 1000 SPRINGFIELD, MO 65804 417-881-0020
TAIL	26.500	10.2600 WALL AND DOOR PROTECTION. INTERIOR LIGHTING. SEE MEP. SEE DIVISION 26.0000 SPECIFICATIONS.	CIVIL ENGINEER OLSSON
	26.501	LIGHTING AT PANEL PERIMETER. EDGE OF PANEL TO ALIGN WITH EDGE OF LIGHT FIXTURE. SEE MEP. SEE DIVISION 26.0000 SPECIFICATIONS.	550 E ST. LOUIS ST SPRINGFIELD, MO 65806 417-890-8802
	_		CONSTRUCTION MANAGER RE SMITH CONSTRUCTION COMPANY 1036 W 2ND ST
			JOPLIN, MO 64801 417-623-4545
			NUM OF M/S PLANNING OF M/S SOLUTION AND A
			PLUTTER SS
			るの JARED A. たき * YOUNGLOVE *
10.261			 JARED A. YOUNGLOVE NUMBER A-2017019282
			Sail Unit
			5.17.23
125-1			JARED A. YOUNGLOVE, ARCHITECT MO #: A-2017019282
			COPYRIGHT 2023 © THESE PRINTS ARE THE PROPERTY OF PARAGON ARCHITECTURE, LLC AND SHALL BE USED ONLY FOR THE
			PROJECT REFERENCE BELOW
			REVISION SCHEDULE
	_		
			လ
			A
			U
			Z
			Σ
			Ц
			О Ш
			Ш
			2625 2625
			S S S S S S S S S S S S S S S S S S S
	_		
	_		
			- DESCRIPTION: SSVILLE HS: PERFORMING ARTS NTER ATE HWY Y, CASSVILLE, MO 65625
			DESCRIPTION: SSVIL NTER ATE HWY Y, CA
]			
			PROJECT ARCHITECT: JAY
09.925			DRAWN BY: TW, TD, KW, KS CHECKED BY: KW, JS, JAY
			PROJECT NUMBER:
			21-620
10.261			DATE:
			2023.05.17
			INTERIOR
]			ELEVATIONS
			SHEET NUMBER:
	-		A7-4
S COPYRIGHT INFRINGEMENT. A SERVICE FEE OF 1.5% WILL BE CHARGED PER MO	NTH ON THE UNPAID BALANCE.	THE USER OF THESE DRAWINGS SHALL PAY ALL COSTS OF COLLECTION, INCLUDING ATTORNEY'S FEES.	

