PH: 417.885.0002 www.paragonarchitecture.com

STRUCTURAL ENGINEER RTM ENGINEERING CONSULTANTS

637 COLLEGE STREET SPRINGFIELD, MO 65806

3045 S KANSAS EXPY SPRINGFIELD, MO 65807 417-708-9315 MEP ENGINEER RTM ENGINEERING CONSULTANTS 3333 E BATTLEFIELD RD SUITE 1000 SPRINGFIELD, MO 65804 417-881-0020 CIVIL ENGINEER OLSSON 550 E ST. LOUIS ST SPRINGFIELD, MO 65806 417-890-8802 CONSTRUCTION MANAGER RE SMITH CONSTRUCTION COMPANY 1036 W 2ND ST JOPLIN, MO 64801

> JARED A. YOUNGLOVE NUMBER JARED A. YOUNGLOVE, ARCHITECT MO #: A-2017019282

COPYRIGHT 2023© THESE PRINTS ARE THE PROPERTY OF PARAGON ARCHITECTURE, LLC AND SHALL BE USED ONLY FOR THE PROJECT REFERENCE BELOW

REVISION SCHEDULE

SC: SEALED CONCRETE T1: TILE MANUFACTURER: DALTILE, PRODUCT: MODERNIST, COLOR: KNOLL CHARCOAL,

SIZE: 24"X24", PATTERN: MONOLITHIC GROUT: BOSTIK HYDROMENT VIVD, COLOR: FRENCH GRAY. 1/16" GROUT JOINT. NOTE: PROVIDE FLOORING TRANSITION STRIPS AT ALL TILE AND CONCRETE FLOORING TRANSITIONS, BASIS-OF-DESIGN: SCHLUTER SCHIENE-10-AE. NOTE: PROVIDE METAL COVE PROFILE TRIM WHEREVER WALL TILE MEETS FLOOR TILE, BASIS-OF-DESIGN: SCHLUTER AHK-1S-100-AE.

WALL BASE

FINISH PLAN LEGEND

NOTE: REFERENCE STRUCTURAL.

10"X39.25". PATTERN: MONOLITHIC.

24"X24". PATTERN: MONOLITHIC.

<u>PW:</u> PLYWOOD FIRE-RESISTANT PLYWOOD, TONGUE AND GROOVE, PAINTED: PT7

<u>CPT1:</u> CARPET TILE MANUFACTURER: MILLIKEN. PRODUCT: ALLOY. COLOR: BRASS. SIZE:

WO1: WALK OFF CARPET MANUFACTURER: SHAW CONTRACT. PRODUCT: JIVE TILE, COLOR: STEP. SIZE:

<u>PC:</u> POLISHED CONCRETE. PCAEC 11.17 AGGREGATE EXPOSURE: CLASS B. PCAC 11.17 APPEARANCE: LEVEL 2.

B1: 4" RESILIENT WALL BASE. BASIS-OF-DESIGN TO BE JOHNSONITE TRADITIONAL WALL BASE. COLOR: BURNT UMBER

PT1 THROUGH 8: PAINT COLORS, BASIS-OF-DESIGN TO BE SHERWIN-WILLIAMS EGGSHELL UNLESS NOTED OTHERWISE. SEE REFLECTED CEILING PLAN FOR CEILING COLORS.

PT1: FIELD COLOR: GLACIER BAY, SW9695
PT2: ACCENT COLOR: REPOSE GRAY SW7015
PT3: ACCENT COLOR: AFTER THE STORM, SW9685 PT4: AUDITORIUM COLOR: WEB GREY SW7075

09.926

H

H

PT5: DRYFALL FOR EXPOSED STRUCTURE & DUCTWORK: COLOR: AFTER THE STORM, SW9685
PT6: DRYFALL FOR EXPOSED STRUCTURE & DUCTWORK: COLOR: GLACIER BAY, SW9695
PT7: HOLLOW METAL DOOR & FRAME & RAILING, SEMI-GLOSS: IRON ORE, SW7069 PT8: CEILING CLOUD COLOR: GLACIER BAY, SW9695

PLASTIC LAMINATE PLAM1: PLASTIC LAMINATE. BASIS-OF-DESIGN: WILSONART UNLESS NOTED OTHERWISE.

PLAM1: COLOR: PHANTOM COCOA. LOCATION: VERTICAL SURFACES.

OTHER

T2: WALL TILE. BASIS-OF-DESIGN: DALTILE COLOR WHEEL LINEAR. COLOR: DESERT GRAY. SIZE: 8" X 24". PATTERN: STACKED. PROVIDE CONTINUOUS TRIM AT EXPOSED TOP EDGE OF WALL TILE AND AT OUTSIDE WALL CORNERS. BASIS-OF-DESIGN: SCHLUTER SHIENE-10-AE.

T3: WALL TILE. BASIS-OF-DESIGN: DALTILE GEOMETRIC FUSION. COLOR: GRAPHITE. SIZE: 8" X 8". PATTERN: STACKED. PROVIDE CONTINUOUS TRIM AT EXPOSED TOP EDGE OF WALL TILE AND AT OUTSIDE WALL CORNERS. BASIS-OF-DESIGN: SCHLUTER SHIENE-10-AE.

GROUT: BOSTIK HYDROMENT VIVD, COLOR: FRENCH GRAY. 1/16" GROUT JOINT. **NOTE:** FOR T2-T3. $\underline{\textbf{QZ1:}}$ QUARTZ COUNTERTOPS, WALL CAPS AND WINDOW SILLS. BASIS-OF-DESIGN: WILSONART. COLOR: MARFA, 3 CM THICKNESS.

<u>WD:</u> WOOD DOOR FINISH, BASIS-OF-DESIGN TO BE MASONITE ARCHITECTURAL, WHITE BIRCH, STAIN: COCOA BEAN

AWP: ACOUSTICAL WALL PANELS:
BASIS-OF-DESIGN: TERRAMAI. PRODUCT: WOOD GRILLE SLAT ACOUSTIC PANEL FINISH: ORCHARD WALNUT. INCLUDE EDGE TRIM ON EXPOSED EDGES OF

<u>WALL SOUND DIFFUSER</u>: MANUF: G&S ACOUSTICS. PYRAMIDAL DIFFUSER. SIZE: 4' X 4'. WDA CORE, TEXTURED WHITE FINISH.

<u>CEILING SOUND DIFFUSER:</u> MANUF: G&S ACOUSTICS. PYRAMIDAL DIFFUSER. TEXTURED WHITE FINISH. SEE SECTION 09.5100 ACOUSTICAL CEILINGS. SIZE: 4' X 4'. INSTALLED IN CEILING GRID. <u>TOILET PARTITIONS:</u> BASIS-OF-DESIGN: SCRANTON PRODUCTS. PRODUCT: HINY HIDERS. COLOR; STAINLESS IN HAMMERED TEXTURE.

WITH A HATCH PATTERN ON FINISH PLANS WHERE APPLICABLE.

GENERAL NOTES

. TRANSITION BETWEEN FLOORING TYPES MUST INCLUDE A TRANSITION STRIP AND/OR NOSING IF TRANSITION IS GREATER THAN 1/4". TRANSITION STRIP AND/OR NOSING IN A COLOR MATCHING WALL BASE COLOR, OR METAL FOR TILE, UNLESS NOTED OTHERWISE. REVIEW AND RECEIVE WRITTEN APPROVAL FOR ALL GRAPHICS WITH ARCHITECT AND OWNER OF WALL COVERINGS AND VINYL FILM BEFORE ORDERING. . REFER TO REFLECTED CEILING PLAN FOR ADDITIONAL FINISH INFORMATION. . FIELD FLOOR FINISH NOTATED WITHIN FINISH TAG. ACCENT FLOOR FINISHES ARE SHOWN

> SC FIELD FLOOR FINISH B1 BASE FINISH

PT1 FIELD PAINT FINISH

SHEET NUMBER:

PROJECT ARCHITECT: JAY

FINISH PLAN

TW, TD, KW, KS

KW, JS, JAY

DRAWN BY:

CHECKED BY:

PROJECT NUMBER: 21-620

2023.05.17

 \Box



REFER TO

APPLICABLE INTERIOR ELEVATIONS -

FOR

ADDITIONAL FINISH

INFORMATION

RR 106

-T2

REFER

APPLICABLE

INTERIOR

ELEVATIONS -

ADDITIONAL

FINISH

INFORMATION

SCALE 3/32" = 1'-0"

AUDITORIUM

EXISTING BUILDING

09.926

PT2:---

REFER

APPLICABLE INTERIOR

ELEVATIONS


ADDITIONAL FINISH

INFORMATION/

PT2

OVERALL

IS WORK IS PROTECTED UNDER U.S. COPYRIGHT LAW AND THE ARCHITECT U.S. COPYRIGHT LAW AND THE ARCHITECT CONSTRUCTION ACT OF THESE DOCUMENTS AFTER FAILURE TO COMPENSATE THE COST OF THESE DOCUMENTS AFTER FAILURE TO COMPENSATE THE COST OF THESE DOCUMENTS FOR ANY PURPOSE, BY ANYONE. USE OF THESE DOCUMENTS AFTER FAILURE TO COMPENSATE THE COST OF THESE DOCUMENTS AFTER FAILURE TO COMPENSATE THE COST OF THESE DOCUMENTS AFTER FAILURE TO COMPENSATE THE COST OF THESE DOCUMENTS AFTER FAILURE TO COMPENSATE THE COST OF THESE DOCUMENTS AFTER FAILURE TO COMPENSATE THE COST OF THESE DOCUMENTS AFTER FAILURE TO COMPENSATE THE COST OF THESE DOCUMENTS AFTER FAILURE TO COMPENSATE THE COST OF THESE DOCUMENTS AFTER FAILURE TO COMPENSATE THE COST OF THESE DOCUMENTS AFTER FAILURE TO COMPENSATE THE COST OF THESE DOCUMENTS AFTER FAILURE TO COMPENSATE THE COST OF THESE DOCUMENTS AFTER FAILURE TO COMPENSATE THE COST OF THESE DOCUMENTS AFTER FAILURE TO COMPENSATE THE COST OF THESE DOCUMENTS AFTER FAILURE TO COMPENSATE THE COST OF TH

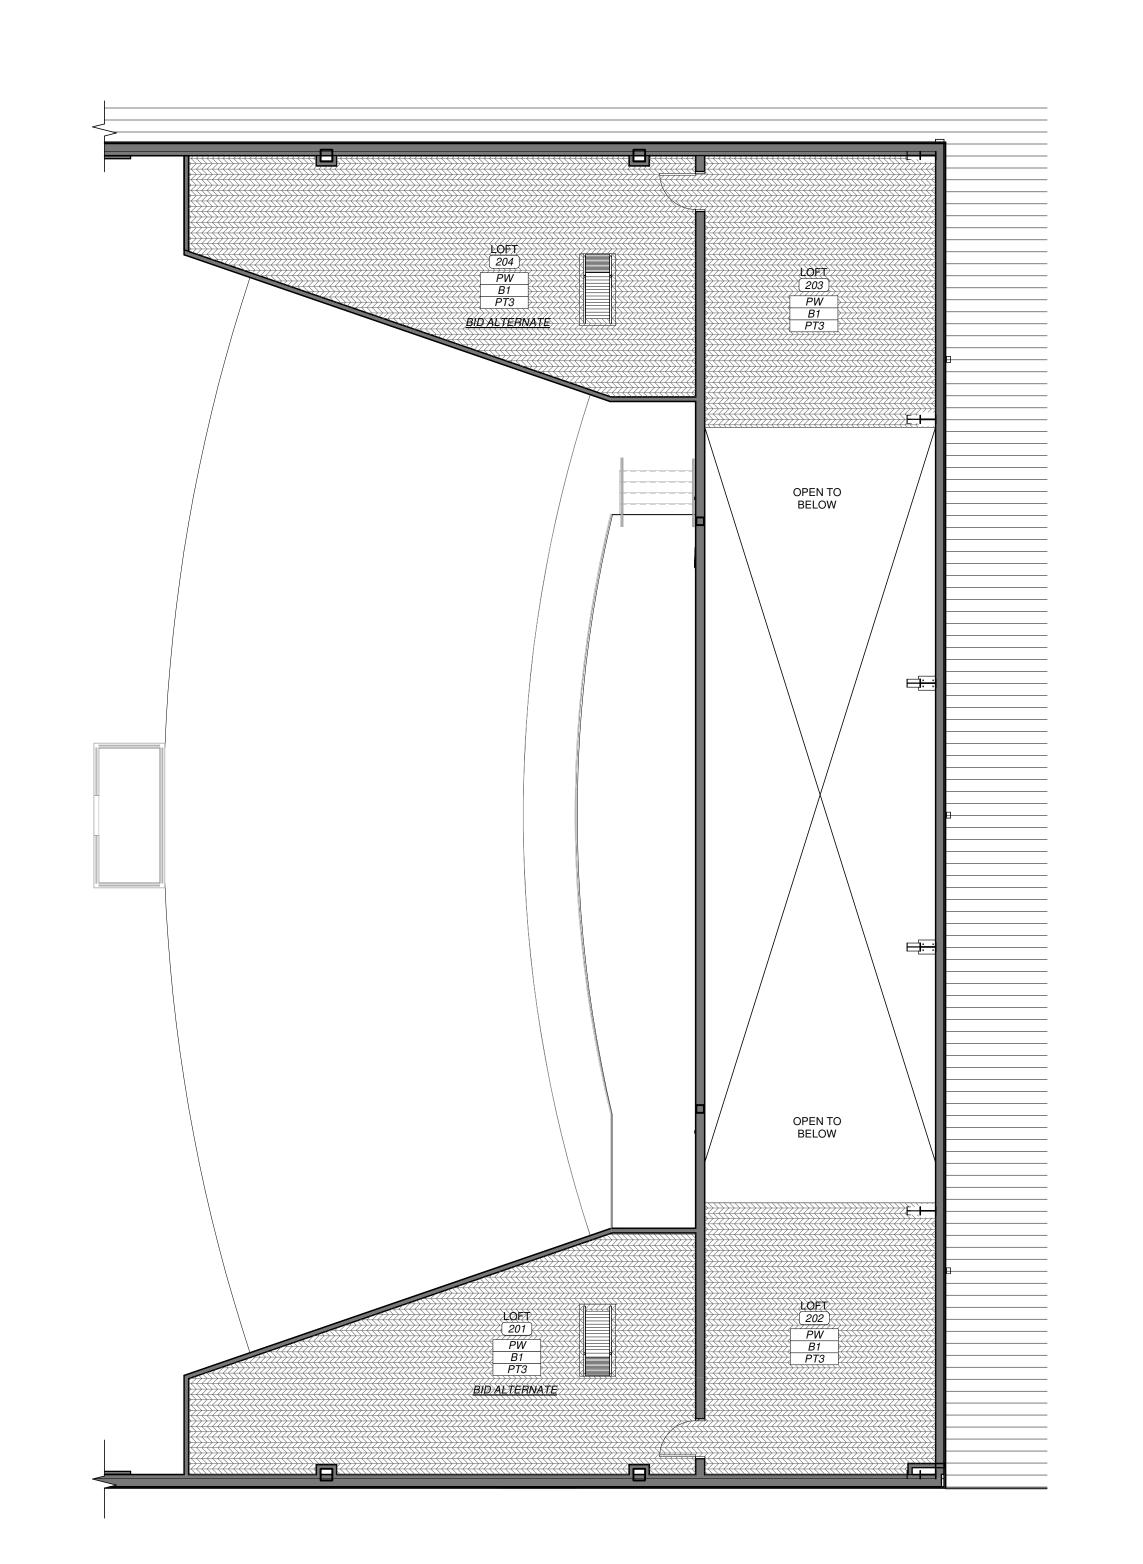



637 COLLEGE STREET SPRINGFIELD, MO 65806

www.paragonarchitecture.com

PH: 417.885.0002

STRUCTURAL ENGINEER RTM ENGINEERING CONSULTANTS 3045 S KANSAS EXPY SPRINGFIELD, MO 65807 417-708-9315 MEP ENGINEER RTM ENGINEERING CONSULTANTS 3333 E BATTLEFIELD RD SUITE 1000 SPRINGFIELD, MO 65804 417-881-0020 **CIVIL ENGINEER** OLSSON 550 E ST. LOUIS ST SPRINGFIELD, MO 65806 417-890-8802 CONSTRUCTION MANAGER RE SMITH CONSTRUCTION COMPANY 1036 W 2ND ST JOPLIN, MO 64801

417-623-4545



COPYRIGHT 2023©

REVISION SCHEDULE

RFORMING

SC: SEALED CONCRETE

MANUFACTURER: DALTILE, PRODUCT: MODERNIST, COLOR: KNOLL CHARCOAL, SIZE: 24"X24", PATTERN: MONOLITHIC GROUT: BOSTIK HYDROMENT VIVD, COLOR: FRENCH GRAY. 1/16" GROUT JOINT.

NOTE: PROVIDE FLOORING TRANSITION STRIPS AT ALL TILE AND CONCRETE
FLOORING TRANSITIONS, BASIS-OF-DESIGN: SCHLUTER SCHIENE-10-AE. NOTE: PROVIDE METAL COVE PROFILE TRIM WHEREVER WALL TILE MEETS FLOOR TILE, BASIS-OF-DESIGN: SCHLUTER AHK-1S-100-AE.

FINISH PLAN LEGEND

NOTE: REFERENCE STRUCTURAL.

10"X39.25". PATTERN: MONOLITHIC.

24"X24". PATTERN: MONOLITHIC.

<u>PW:</u> PLYWOOD FIRE-RESISTANT PLYWOOD, TONGUE AND GROOVE, PAINTED: PT7

<u>CPT1:</u> CARPET TILE MANUFACTURER: MILLIKEN. PRODUCT: ALLOY. COLOR: BRASS. SIZE:

<u>WO1:</u> WALK OFF CARPET MANUFACTURER: SHAW CONTRACT. PRODUCT: JIVE TILE, COLOR: STEP. SIZE:

PC: POLISHED CONCRETE. PCAEC 11.17 AGGREGATE EXPOSURE: CLASS B. PCAC 11.17 APPEARANCE: LEVEL 2.

WALL BASE

B1: 4" RESILIENT WALL BASE. BASIS-OF-DESIGN TO BE JOHNSONITE TRADITIONAL WALL BASE. COLOR: BURNT UMBER

PT1 THROUGH 8: PAINT COLORS, BASIS-OF-DESIGN TO BE SHERWIN-WILLIAMS EGGSHELL UNLESS NOTED OTHERWISE. SEE REFLECTED CEILING PLAN FOR CEILING COLORS.

PT1: FIELD COLOR: GLACIER BAY, SW9695
PT2: ACCENT COLOR: REPOSE GRAY SW7015
PT3: ACCENT COLOR: AFTER THE STORM, SW9685
PT4: AUDITORIUM COLOR: WEB GREY SW7075

PT5: DRYFALL FOR EXPOSED STRUCTURE & DUCTWORK: COLOR: AFTER THE STORM, SW9685
PT6: DRYFALL FOR EXPOSED STRUCTURE & DUCTWORK: COLOR: GLACIER BAY, SW9695
PT7: HOLLOW METAL DOOR & FRAME & RAILING, SEMI-GLOSS: IRON ORE, SW7069
PT8: CEILING CLOUD COLOR: GLACIER BAY, SW9695

PLASTIC LAMINATE PLAM1: PLASTIC LAMINATE. BASIS-OF-DESIGN: WILSONART UNLESS NOTED OTHERWISE.

PLAM1: COLOR: PHANTOM COCOA. LOCATION: VERTICAL SURFACES.

OTHER

T2: WALL TILE. BASIS-OF-DESIGN: DALTILE COLOR WHEEL LINEAR. COLOR: DESERT GRAY. SIZE: 8" X 24". PATTERN: STACKED. PROVIDE CONTINUOUS TRIM AT EXPOSED TOP EDGE OF WALL TILE AND AT OUTSIDE WALL CORNERS. BASIS-OF-DESIGN: SCHLUTER SHIENE-10-AE.

T3: WALL TILE. BASIS-OF-DESIGN: DALTILE GEOMETRIC FUSION. COLOR: GRAPHITE. SIZE: 8" X 8". PATTERN: STACKED. PROVIDE CONTINUOUS TRIM AT EXPOSED TOP EDGE OF WALL TILE AND AT OUTSIDE WALL CORNERS. BASIS-OF-DESIGN: SCHLUTER SHIENE-10-AE.

GROUT: BOSTIK HYDROMENT VIVD, COLOR: FRENCH GRAY. 1/16" GROUT JOINT. **NOTE:** FOR T2-T3. $\underline{\textbf{QZ1:}}$ QUARTZ COUNTERTOPS, WALL CAPS AND WINDOW SILLS. BASIS-OF-DESIGN: WILSONART. COLOR: MARFA, 3 CM THICKNESS.

 $\underline{\textbf{WD:}}$ WOOD DOOR FINISH, BASIS-OF-DESIGN TO BE MASONITE ARCHITECTURAL, WHITE BIRCH, STAIN: COCOA BEAN

AWP: ACOUSTICAL WALL PANELS:
BASIS-OF-DESIGN: TERRAMAI. PRODUCT: WOOD GRILLE SLAT ACOUSTIC PANEL. FINISH: ORCHARD WALNUT. INCLUDE EDGE TRIM ON EXPOSED EDGES OF

<u>WALL SOUND DIFFUSER</u>: MANUF: G&S ACOUSTICS. PYRAMIDAL DIFFUSER. SIZE: 4' X 4'. WDA CORE, TEXTURED WHITE FINISH.

<u>CEILING SOUND DIFFUSER:</u> MANUF: G&S ACOUSTICS. PYRAMIDAL DIFFUSER. TEXTURED WHITE FINISH. SEE SECTION 09.5100 ACOUSTICAL CEILINGS. SIZE: 4' X 4'. INSTALLED IN CEILING GRID. <u>TOILET PARTITIONS:</u> BASIS-OF-DESIGN: SCRANTON PRODUCTS. PRODUCT: HINY HIDERS. COLOR; STAINLESS IN HAMMERED TEXTURE.

GENERAL NOTES

- TRANSITION BETWEEN FLOORING TYPES MUST INCLUDE A TRANSITION STRIP AND/OR NOSING IF TRANSITION IS GREATER THAN 1/4". TRANSITION STRIP AND/OR NOSING IN A COLOR MATCHING WALL BASE COLOR, OR METAL FOR TILE, UNLESS NOTED OTHERWISE. REVIEW AND RECEIVE WRITTEN APPROVAL FOR ALL GRAPHICS WITH ARCHITECT AND OWNER OF WALL COVERINGS AND VINYL FILM BEFORE ORDERING.
- REFER TO REFLECTED CEILING PLAN FOR ADDITIONAL FINISH INFORMATION. FIELD FLOOR FINISH NOTATED WITHIN FINISH TAG. ACCENT FLOOR FINISHES ARE SHOWN WITH A HATCH PATTERN ON FINISH PLANS WHERE APPLICABLE.

SC FIELD FLOOR FINISH
BASE FINISH PT1 FIELD PAINT FINISH

FINISH PLAN -MEZZANINE

PROJECT ARCHITECT: JAY

TW, TD, KW

KW, JS, JAY

DRAWN BY:

CHECKED BY:

PROJECT NUMBER:

21-620

2023.05.17

SHEET NUMBER:

L

IN SUBSTRANTIAL BE CONSTRUCTION ACT OF THESE DOCUMENTS AFTER FAILURE TO COMPENSATE THE ARCHITECT CONSTRUCTION MINIMUM IF CONTRACT ON FILE), OR 5% OF THE COST OF CONSTRUCTION ACT OF 1990. FAILURE TO COMPENSATE THE ARCHITECT CONSTRUCTS AND THE CURRY SHALL BE CONSIDERED SUBSTANTIAL NON-PERFORMANCE AND CONSTRUCTS IN THE LOSS OF PERMISSION TO USE THESE DOCUMENTS AFTER FAILURE TO COMPENSATE THE ARCHITECT CONSTRUCTS IN THE LOSS OF THESE DOCUMENTS AFTER FAILURE TO COMPENSATE THE ARCHITECT CONSTRUCTS IN THE LOSS OF THESE DOCUMENTS AFTER FAILURE TO COMPENSATE THE ARCHITECT CONSTRUCTS IN THE LOSS OF THESE DOCUMENTS AFTER FAILURE TO COMPENSATE THE ARCHITECT CONSTRUCTS IN THE LOSS OF THESE DOCUMENTS AFTER FAILURE TO COMPENSATE THE ARCHITECT CONSTRUCTS IN THE LOSS OF THESE DOCUMENTS AFTER FAILURE TO COMPENSATE THE ARCHITECT CONSTRUCTS IN THE LOSS OF THESE DOCUMENTS AFTER FAILURE TO COMPENSATE THE ARCHITECT CONSTRUCTS IN THE LOSS OF THESE DOCUMENTS AFTER FAILURE TO COMPENSATE THE ARCHITECT CONSTRUCTS IN THE LOSS OF THESE DOCUMENTS AFTER FAILURE TO COMPENSATE THE ARCHITECT CONSTRUCTS IN THE LOSS OF THESE DOCUMENTS AFTER FAILURE TO COMPENSATE THE ARCHITECT CONSTRUCTS IN THE LOSS OF THESE DOCUMENTS AFTER FAILURE TO COMPENSATE THE ARCHITECT CONSTRUCTS IN THE LOSS OF THESE DOCUMENTS AFTER FAILURE TO COMPENSATE THE ARCHITECT CONSTRUCTS IN THE LOSS OF THESE DOCUMENTS AFTER FAILURE TO COMPENSATE THE ARCHITECT CONSTRUCTS IN THE LOSS OF THE LOSS OF THE CONSTRUCTS IN THE LOS

PH: 417.885.0002 www.paragonarchitecture.com

RE SMITH CONSTRUCTION COMPANY 1036 W 2ND ST JOPLIN, MO 64801 417-623-4545

* YOUNGLOVE NUMBER JARED A. YOUNGLOVE, ARCHITECT MO #: A-2017019282

COPYRIGHT 2023©

REVISION SCHEDULE

PERFORMING

PROJECT ARCHITECT: JAY TW, TD, KW KW, JS, JAY DRAWN BY: CHECKED BY:

PROJECT NUMBER: 21-620

2023.05.17

ACCESSORIES FINISH PLAN LEGEND

 $\underline{\textbf{CG1:}}$ CORNER GUARDS. BASIS-OF-DESIGN: INPRO. COLOR: FEATHER. SIZE: 1-1/2" X 1-1/2". INSTALL FULL HEIGHT.

<u>CG2:</u> CORNER GUARDS. BASIS-OF-DESIGN: INPRO. COLOR: PEWTER GRAY. SIZE: 1-1/2" X 1-1/2". INSTALL FULL HEIGHT.


RS: ROLLER SHADES: BASIS-OF-DESIGN: CROWN SHADE. PRODUCT: CHAIN LIFT SYSTEM. FABRIC: MERMET E SCREEN HIGH PERFORMANCE. COLOR: 3% OPENNESS CHARCOAL/CHARCOAL.

APPLY 4' W X 8' H SHEET ON WALLS BEHIND MOP SINK.

WP: WALL PROTECTION. BASIS-OF-DESIGN: KOROGUARD WALL PROTECTION SYSTEMS.
PRODUCT: STANDARD KOROGUARD SHEETS. COLOR: FEATHER. TEXTURE. P1 DUNE. NOTE:

ACCESSORIES PLAN


SHEET NUMBER:

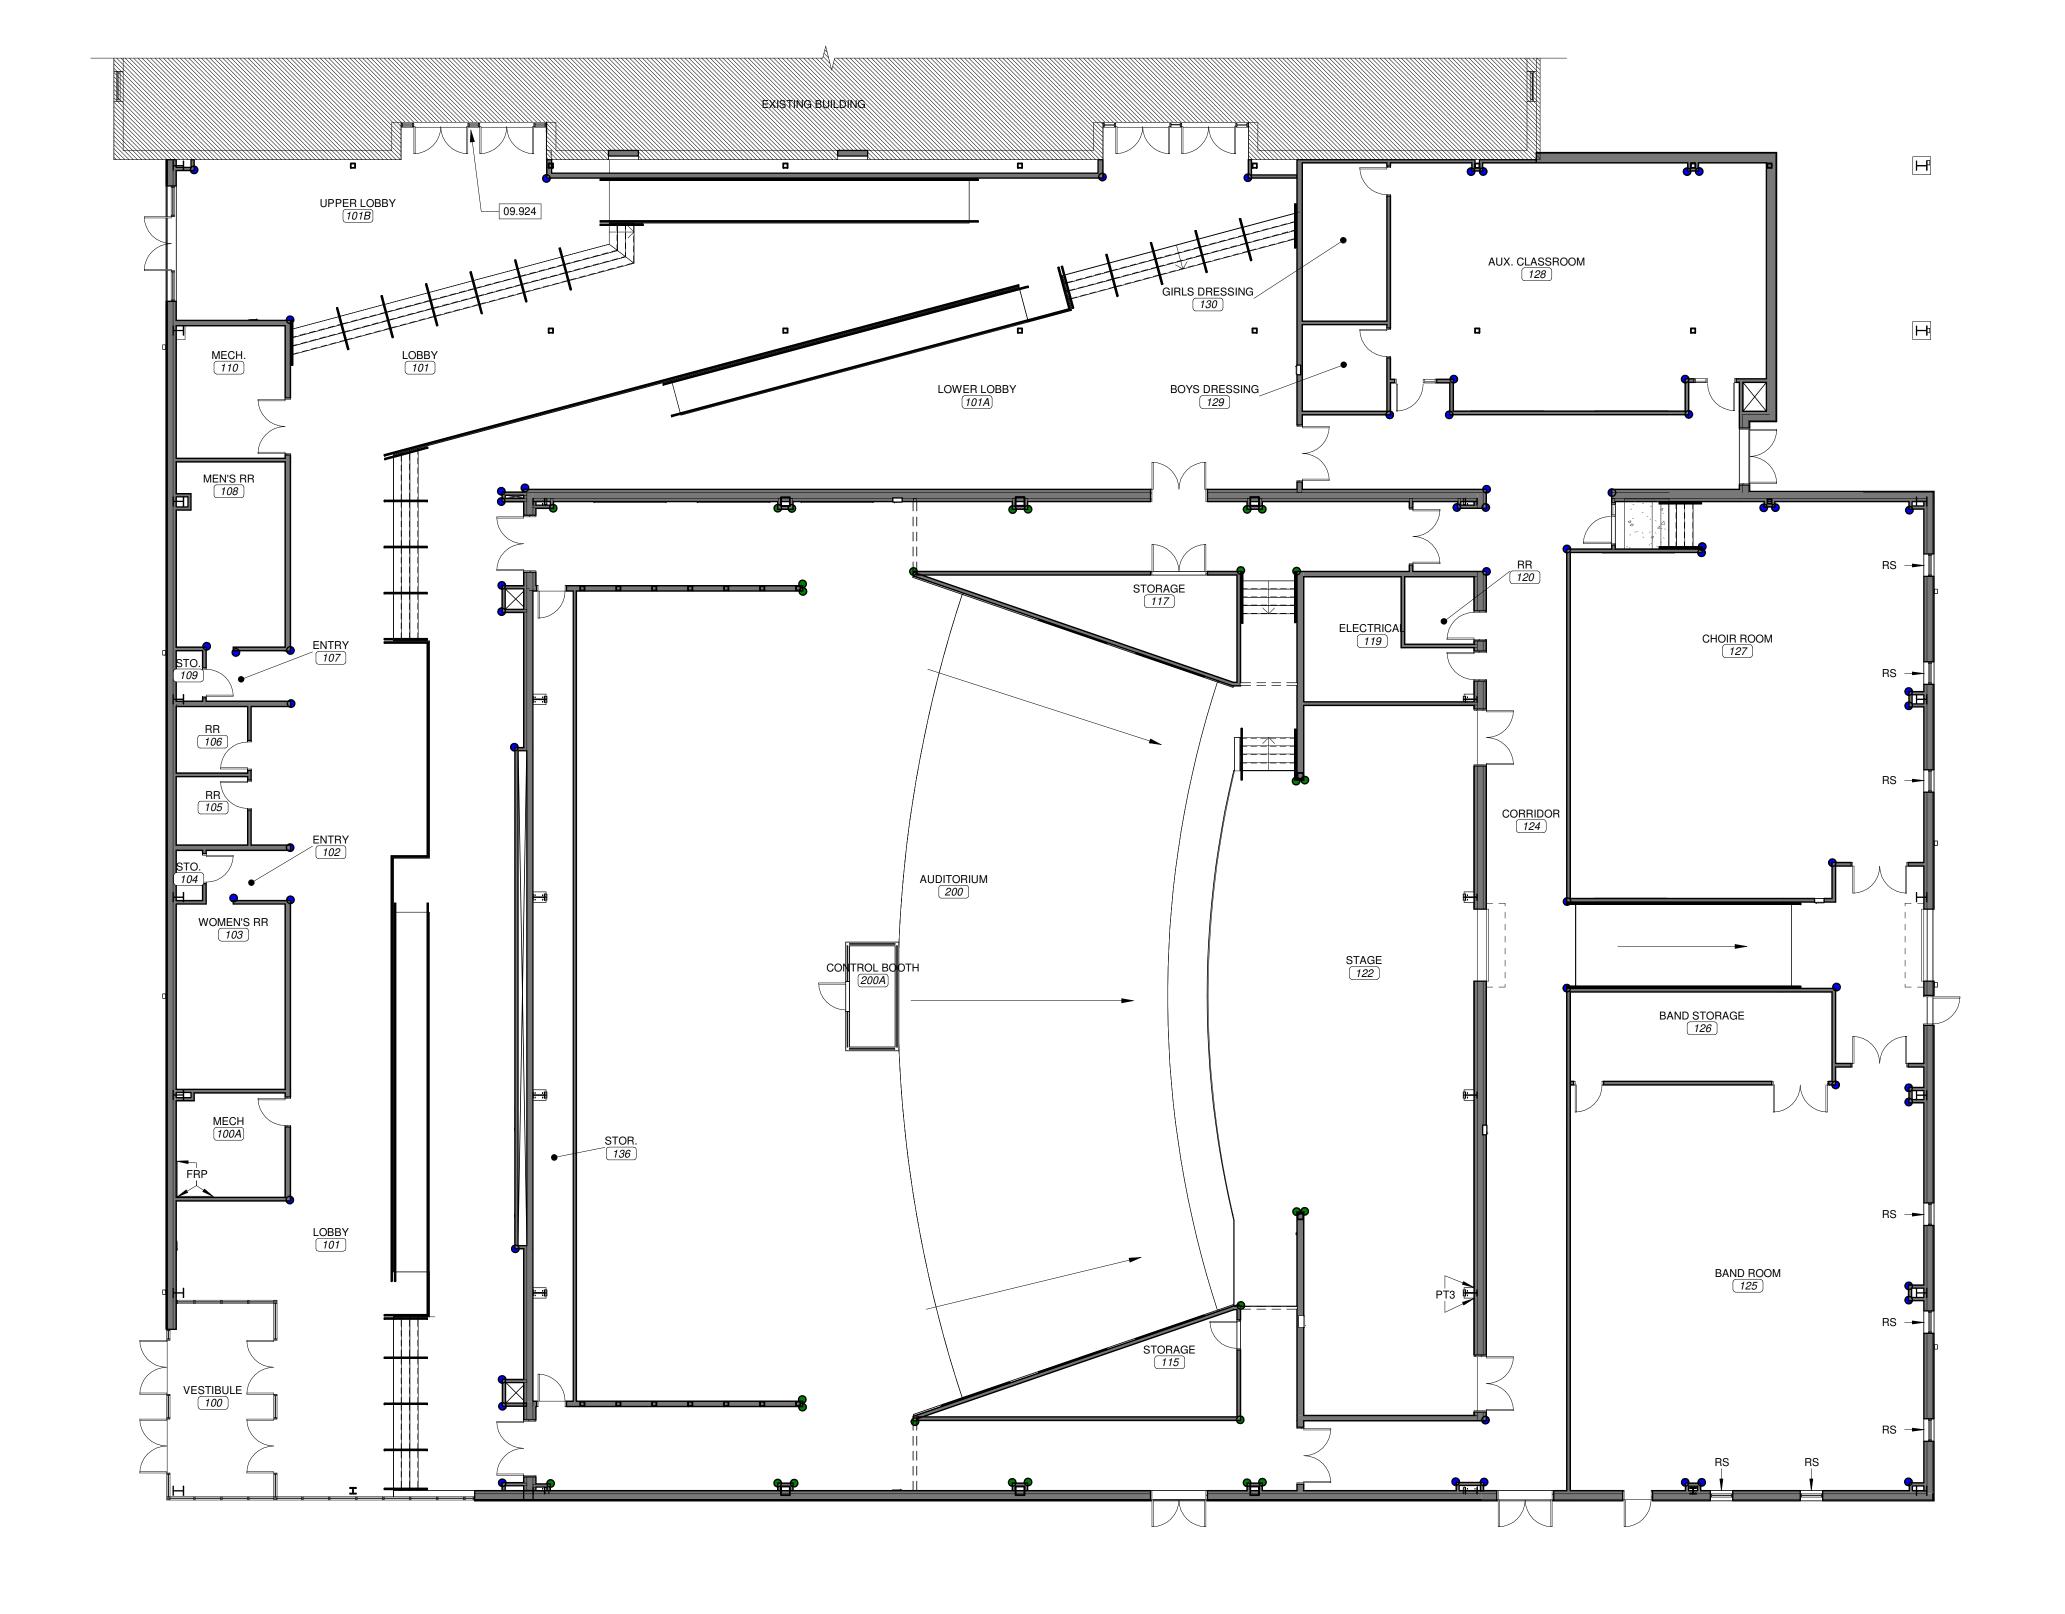

HIS WORK IS PROTECTED UNDER U.S. COPYRIGHT LAW AND THE ARCHITECTURAL WORKS COPYRIGHT INFRINGEMENT. A SERVICE FEE OF 1.5% WILL BE CONSTRUCT SIN INFLIED CONTRACT, SHALL POS OF THESE DOCUMENTS AFTER FAILURE TO COMPENSATE PARAGON ARCHITECTURAL WORKS COPYRIGHT INFRINGEMENT. A SERVICE FEE OF 1.5% WILL BE CONSTRUCTION MINIMUM IF CONTRACT, SHALL POS OF THESE DOCUMENTS AFTER FAILURE TO COMPENSATE THE ARCHITECT CONSTITUTES AN INPLIED CONTRACT, SHALL POS OF THESE DOCUMENTS AFTER FAILURE TO COMPENSATE THE ARCHITECTURAL WORKS COPYRIGHT INFRINGEMENT. AS EXCHANGED FOR MANY OF THE COST OF THESE DOCUMENTS AFTER FAILURE TO COMPENSATE THE ARCHITECT CONSTITUTES AND REACH OF CONTRACT, SHALL POS OF THESE DOCUMENTS AFTER FAILURE TO COMPENSATE THE ARCHITECT CONSTITUTES AND REACH OF CONTRACT, SHALL POS OF THESE DOCUMENTS AFTER FAILURE TO COMPENSATE THE ARCHITECT CONSTITUTES AND REACH OF CONTRACT IS INCLUDING ANTONION OF THE COST OF CONTRACT AND REACH OF CON

SCALE 3/32" = 1'-0"

	F	URNITURE SCI	HEDULE	
TAG	MANUFACTURER	PRODUCT DISCRIPTION	MATERIAL	SEAT COUNT
SE-1	Interkal Seating	Vision Platform Chair + B3 Blackout 19" width	Polydeck: Black, Plastic Seat & Back color to be selected from manufacturer's full range of colors	438
SE-2	Steadfast	Convention T; 19" wide fixed chair	Polypropylene Outer Back Color: Black, Arm Rest: Black.Surface Material: Upholstery: to be selected from manufacturer's full range of colors	389

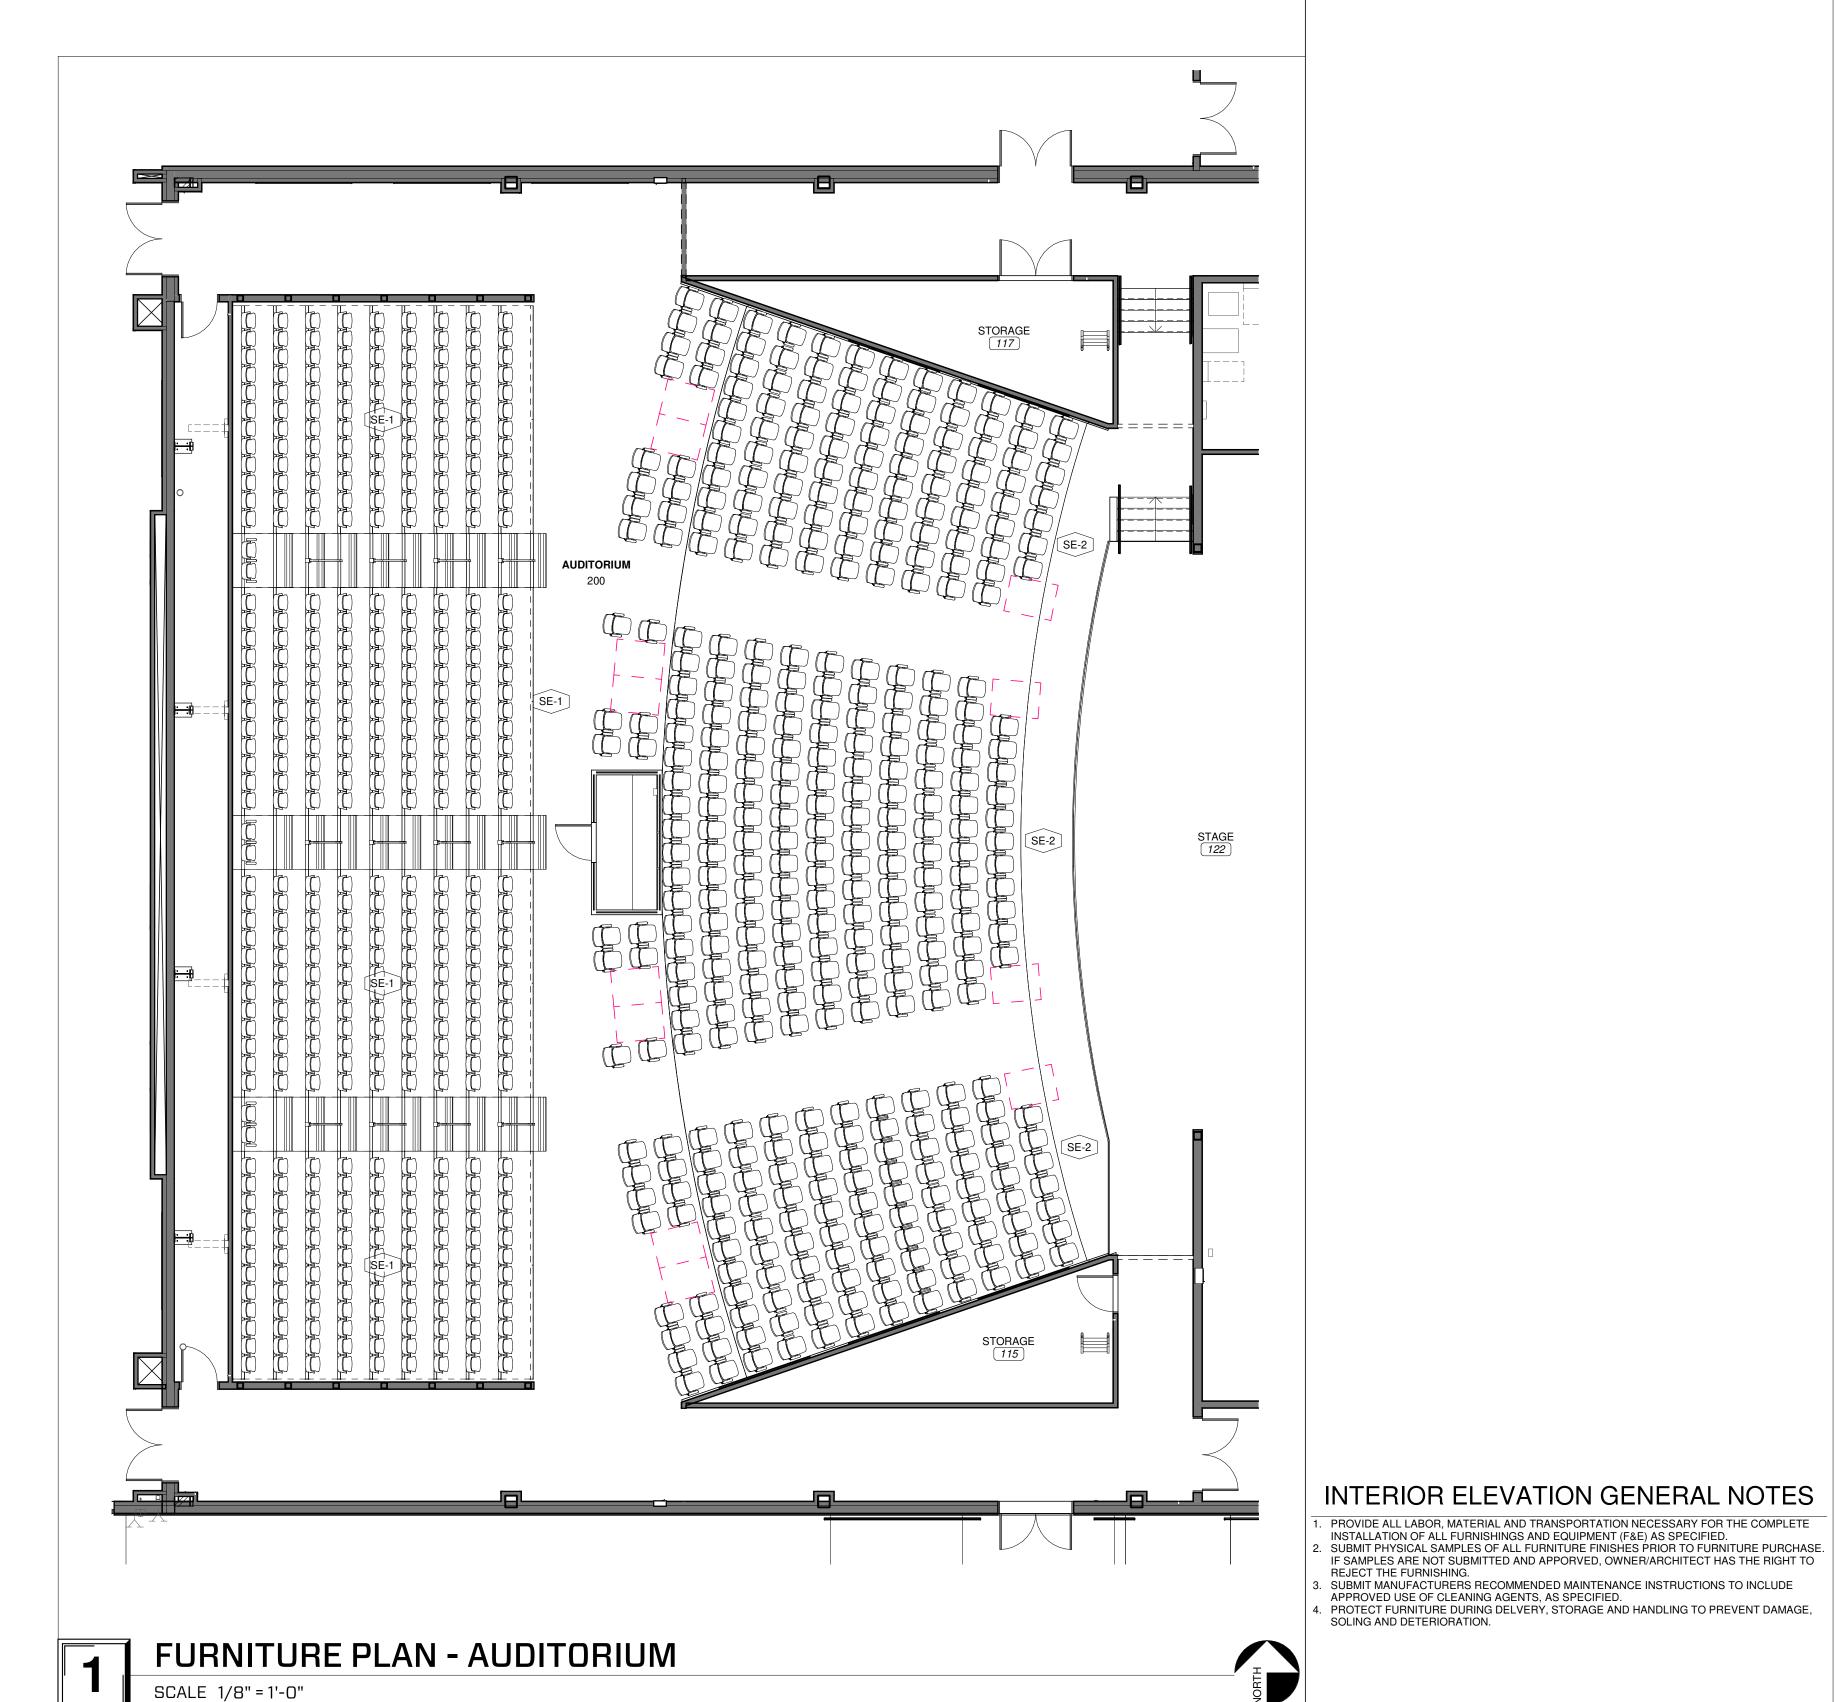

THIS WORK IS PROTECTED UNDER U.S. COPYRIGHT LAW AND THE ARCHITECT CONSTITUTES A BREACH OF CONTRACT ON FILE), OR 5% OF THE COST OF CONSTRUCTION MINIMUM IF CONTRACT SI MPLIED CONTRACT ON FILE DOCUMENTS A BREACH OF CONSTRUCTION MINIMUM IF CONTRACT ON FILE). OR 5% OF THE COST OF CONSTRUCTION MINIMUM IF CONTRACT ON FILE DOCUMENTS A BREACH OF CONTRACT ON FILE). OR 5% OF THE COST OF CONSTRUCTION MINIMUM IF CONTRACT ON FILE DOCUMENTS A BREACH OF CONTRACT ON FILE). OR 5% OF THE COST OF CONSTRUCTION MINIMUM IF CONTRACT ON FILE DOCUMENTS A BREACH OF CONTRACT ON FILE). OR 5% OF THE COST OF CONSTRUCTION MINIMUM IF CONTRACT ON FILE DOCUMENTS A BREACH OF CONTRACT ON FILE). OR 5% OF THE COST OF CONSTRUCTION MINIMUM IF CONTRACT ON FILE). OR 5% OF THE COST OF CONSTRUCTION MINIMUM IF CONTRACT ON FILE). OR 5% OF THE COST OF CONSTRUCTION MINIMUM IF CONTRACT ON FILE). OR 5% OF THE COST OF CONSTRUCTION MINIMUM IF CONTRACT ON FILE). OR 5% OF THE COST OF CONSTRUCTION MINIMUM IF CONTRACT ON FILE). OR 5% OF THE COST OF CONSTRUCTION MINIMUM IF CONTRACT ON FILE). OR 5% OF THE COST OF CONSTRUCTION MINIMUM IF CONTRACT ON FILE). OR 5% OF THE COST OF CONSTRUCTION MINIMUM IF CONTRACT ON FILE). OR 5% OF THE COST OF CONSTRUCTION MINIMUM IF CONTRACT ON FILE). OR 5% OF THE COST OF CONSTRUCTION MINIMUM IF CONTRACT ON FILE). OR 5% OF THE COST OF CONSTRUCTION MINIMUM IF CONTRACT ON FILE). OR 5% OF THE COST OF CONSTRUCTION MINIMUM IF CONTRACT ON FILE). OR 5% OF THE COST OF CONSTRUCTION MINIMUM IF CONTRACT ON FILE). OR 5% OF THE COST OF CONSTRUCTION MINIMUM IF CONTRACT ON FILE). OR 5% OF THE COST OF CONSTRUCTION MINIMUM IF CONTRACT ON FILE). OR 5% OF THE COST OF CONSTRUCTION MINIMUM IF CONTRACT ON FILE). OR 5% OF THE COST OF CONTRACT ON FILE). OR 5% OF THE COST OF CONTRACT ON FILE). OR 5% OF THE COST OF CONTRACT ON FILE). OR 5% OF THE COST OF CONTRACT ON FILE). OR 5% OF THE COST OF CONTRACT ON FILE). OR 5% OF THE COST OF CONTRACT ON FILE). OR 5% OF THE COST OF COST O



MISSOURI STATE CERTIFICATE OF AUTHORITY NUMBER A-201600 637 COLLEGE STREET SPRINGFIELD, MO 65806

PH: 417.885.0002 www.paragonarchitecture.com

STRUCTURAL ENGINEER

RTM ENGINEERING CONSULTANTS
3045 S KANSAS EXPY
SPRINGFIELD, MO 65807
417-708-9315

MEP ENGINEER

RTM ENGINEERING CONSULTANTS
3333 E BATTLEFIELD RD SUITE 1000
SPRINGFIELD, MO 65804
417-881-0020

CIVIL ENGINEER

CIVIL ENGINEER

OLSSON
550 E ST. LOUIS ST
SPRINGFIELD, MO 65806
417-890-8802

CONSTRUCTION MANAGER

RE SMITH CONSTRUCTION COMPANY
1036 W 2ND ST
JOPLIN, MO 64801
417-623-4545

JARED A.

NUMBER
A-2017019282

JARED A. YOUNGLOVE, ARCHITECT
MO #: A-2017019282

COPYRIGHT 2023 ©
THESE PRINTS ARE THE PROPERTY OF PARAGON
CHITECTURE, LLC AND SHALL BE USED ONLY FOR THE

REVISION SCHEDULE

HS: PERFORMING ARTS

PROJECT DESCRIPTION:

CASSVILLE

CASSVILLE

CHECKED BY: KM, TD, KW, KS

CHECKED BY: KW, JS, JAY


PROJECT NUMBER: 21-620

DATE: 2023.05.17

FURNITURE PLAN

SHEET NUMBER:

A10-0

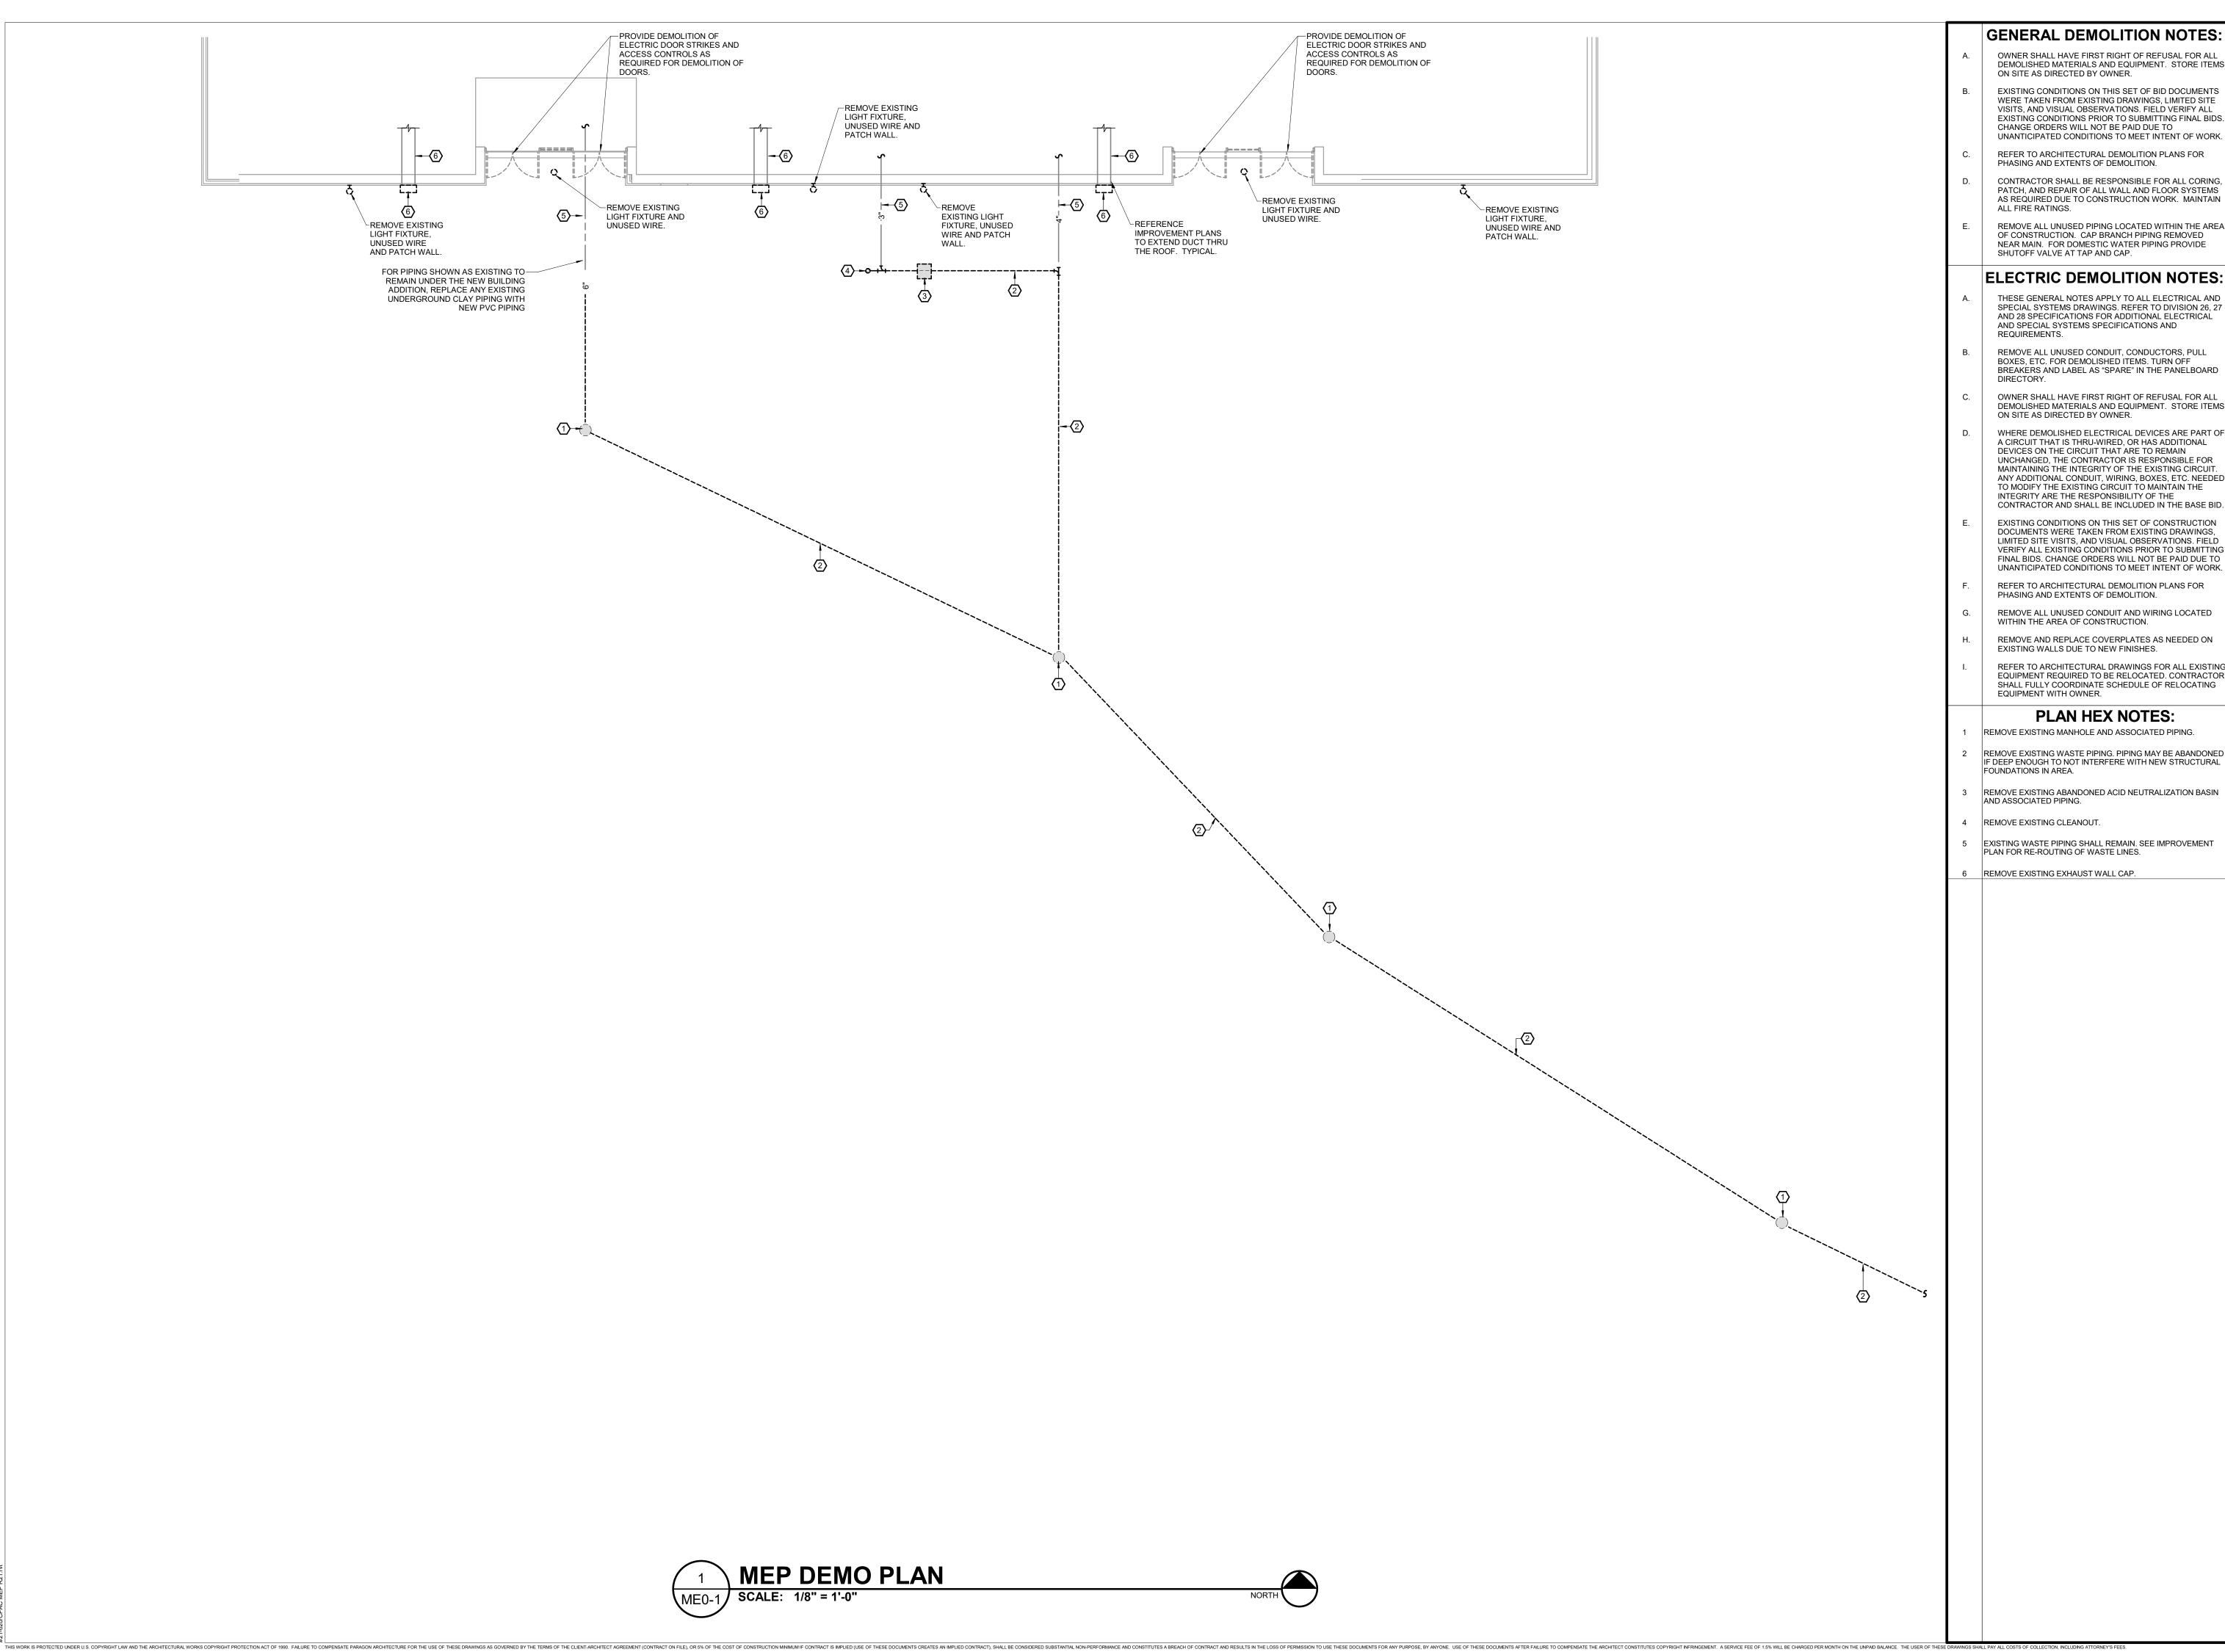

GENERAL DEMOLITION NOTES: OWNER SHALL HAVE FIRST RIGHT OF REFUSAL FOR ALL DEMOLISHED MATERIALS AND EQUIPMENT. STORE ITEMS ON SITE AS DIRECTED BY OWNER.

EXISTING CONDITIONS ON THIS SET OF BID DOCUMENTS WERE TAKEN FROM EXISTING DRAWINGS, LIMITED SITE VISITS, AND VISUAL OBSERVATIONS. FIELD VERIFY ALL EXISTING CONDITIONS PRIOR TO SUBMITTING FINAL BIDS.

CHANGE ORDERS WILL NOT BE PAID DUE TO UNANTICIPATED CONDITIONS TO MEET INTENT OF WORK.

REFER TO ARCHITECTURAL DEMOLITION PLANS FOR PHASING AND EXTENTS OF DEMOLITION. CONTRACTOR SHALL BE RESPONSIBLE FOR ALL CORING,

PATCH, AND REPAIR OF ALL WALL AND FLOOR SYSTEMS AS REQUIRED DUE TO CONSTRUCTION WORK. MAINTAIN

REMOVE ALL UNUSED PIPING LOCATED WITHIN THE AREA OF CONSTRUCTION. CAP BRANCH PIPING REMOVED NEAR MAIN. FOR DOMESTIC WATER PIPING PROVIDE SHUTOFF VALVE AT TAP AND CAP.

ELECTRIC DEMOLITION NOTES: THESE GENERAL NOTES APPLY TO ALL ELECTRICAL AND

AND SPECIAL SYSTEMS SPECIFICATIONS AND REMOVE ALL UNUSED CONDUIT, CONDUCTORS, PULL

BOXES, ETC. FOR DEMOLISHED ITEMS. TURN OFF BREAKERS AND LABEL AS "SPARE" IN THE PANELBOARD

OWNER SHALL HAVE FIRST RIGHT OF REFUSAL FOR ALL DEMOLISHED MATERIALS AND EQUIPMENT. STORE ITEMS ON SITE AS DIRECTED BY OWNER.

WHERE DEMOLISHED ELECTRICAL DEVICES ARE PART OF A CIRCUIT THAT IS THRU-WIRED, OR HAS ADDITIONAL DEVICES ON THE CIRCUIT THAT ARE TO REMAIN UNCHANGED, THE CONTRACTOR IS RESPONSIBLE FOR MAINTAINING THE INTEGRITY OF THE EXISTING CIRCUIT. ANY ADDITIONAL CONDUIT, WIRING, BOXES, ETC. NEEDED TO MODIFY THE EXISTING CIRCUIT TO MAINTAIN THE INTEGRITY ARE THE RESPONSIBILITY OF THE CONTRACTOR AND SHALL BE INCLUDED IN THE BASE BID.

EXISTING CONDITIONS ON THIS SET OF CONSTRUCTION DOCUMENTS WERE TAKEN FROM EXISTING DRAWINGS, LIMITED SITE VISITS, AND VISUAL OBSERVATIONS. FIELD VERIFY ALL EXISTING CONDITIONS PRIOR TO SUBMITTING FINAL BIDS. CHANGE ORDERS WILL NOT BE PAID DUE TO UNANTICIPATED CONDITIONS TO MEET INTENT OF WORK.

REFER TO ARCHITECTURAL DEMOLITION PLANS FOR PHASING AND EXTENTS OF DEMOLITION.

REMOVE ALL UNUSED CONDUIT AND WIRING LOCATED

REMOVE AND REPLACE COVERPLATES AS NEEDED ON EXISTING WALLS DUE TO NEW FINISHES.

REFER TO ARCHITECTURAL DRAWINGS FOR ALL EXISTING EQUIPMENT REQUIRED TO BE RELOCATED. CONTRACTOR SHALL FULLY COORDINATE SCHEDULE OF RELOCATING

PLAN HEX NOTES:

REMOVE EXISTING MANHOLE AND ASSOCIATED PIPING.

REMOVE EXISTING WASTE PIPING. PIPING MAY BE ABANDONED IF DEEP ENOUGH TO NOT INTERFERE WITH NEW STRUCTURAL

REMOVE EXISTING ABANDONED ACID NEUTRALIZATION BASIN

EXISTING WASTE PIPING SHALL REMAIN. SEE IMPROVEMENT PLAN FOR RE-ROUTING OF WASTE LINES.

MISSOURI STATE CERTIFICATE OF AUTHORITY NUMBER A-2016000415 637 COLLEGE STREET SPRINGFIELD, MO 65806

PH: 417.885.0002

www.paragonarchitecture.com




engineering consultants 3333 E. Battlefield Rd | Suite 1000 Springfield, MO 65804 417.881.0020 | www.rtmec.com STATE OF MISSOURI

CERTIFICATE OF AUTHORITY:

2014035826

FOR ENGINEERING

JENNIFER A. LUCE E-2001018772

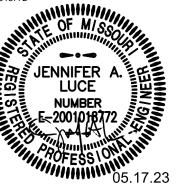

THESE PRINTS ARE THE PROPERTY OF PARAGON ARCHITECTURE, LLC AND SHALL BE USED ONLY FOR THE PROJECT REFERENCE BELOW

REVISION SCHEDULE

PERFORMING HS:

DRAWN BY:


PROJECT NUMBER: 21-620

05-17-2023

MEP DEMOLITION

SHEET NUMBER:

ME0-1

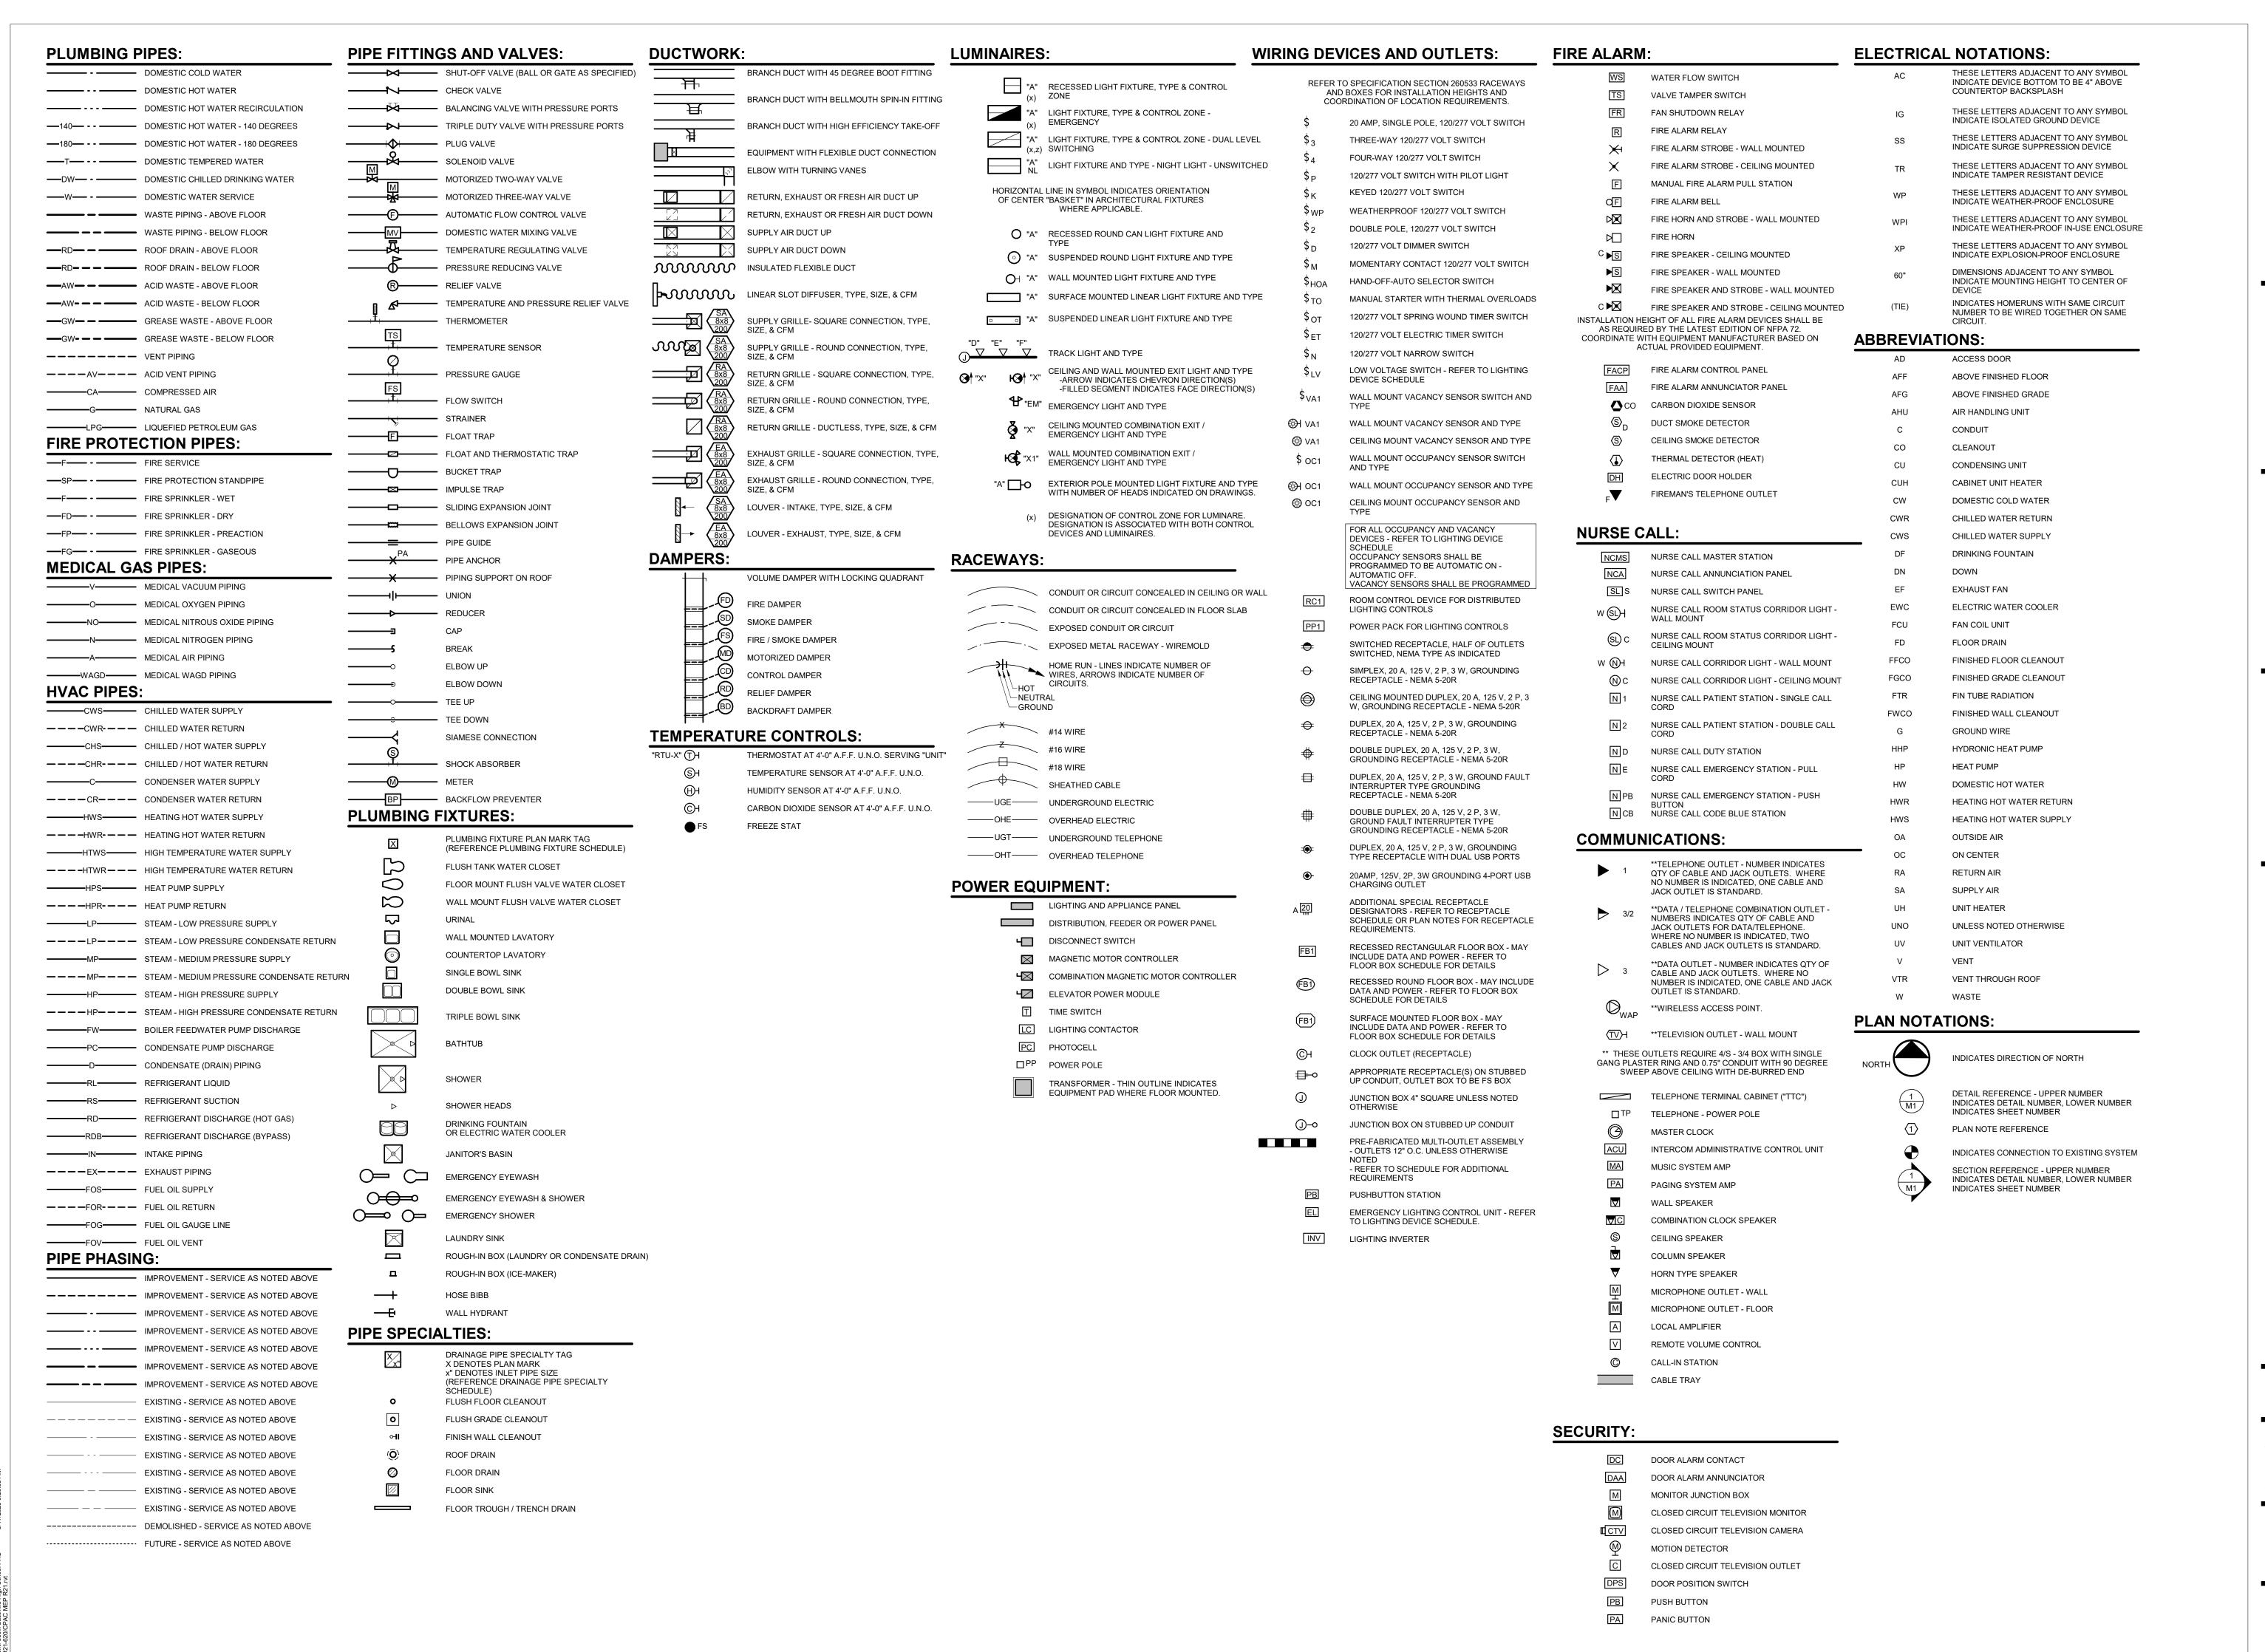

THIS WORK IS PROTECTED UNDER U.S. COPYRIGHT LAW AND THE ARCHITECT CONSTITUTES A SERVICE FEE OF 1.5% WILL BE CHARGED PER MONTH ON THE USE OF THESE DOCUMENTS FOR ANY PURPOSE, BY ANYONE. USE OF THESE DOCUMENTS FOR ANY PURPOSE, BY ANY PURPO

MISSOURI STATE CERTIFICATE OF AUTHORITY NUMBER A-2016000415

PH: 417.885.0002 www.paragonarchitecture.com

637 COLLEGE STREET

SPRINGFIELD, MO 65806



STATE OF MISSOURI

CERTIFICATE OF AUTHORITY

2014035826

FOR ENGINEERING

JENNIFER A. LUCE



THESE PRINTS ARE THE PROPERTY OF PARAGON ARCHITECTURE, LLC AND SHALL BE USED ONLY FOR THE PROJECT REFERENCE BELOW

REVISION SCHEDULE

VILLE HS: PERFORMING ARTS

PROJECT ENGINEER: JAL DRAWN BY: AGB CHECKED BY: JAL


PROJECT NUMBER: 21-620

DATE: 05-17-2023

SYMBOLS LEGEND

SHEET NUMBER:

ME1-1

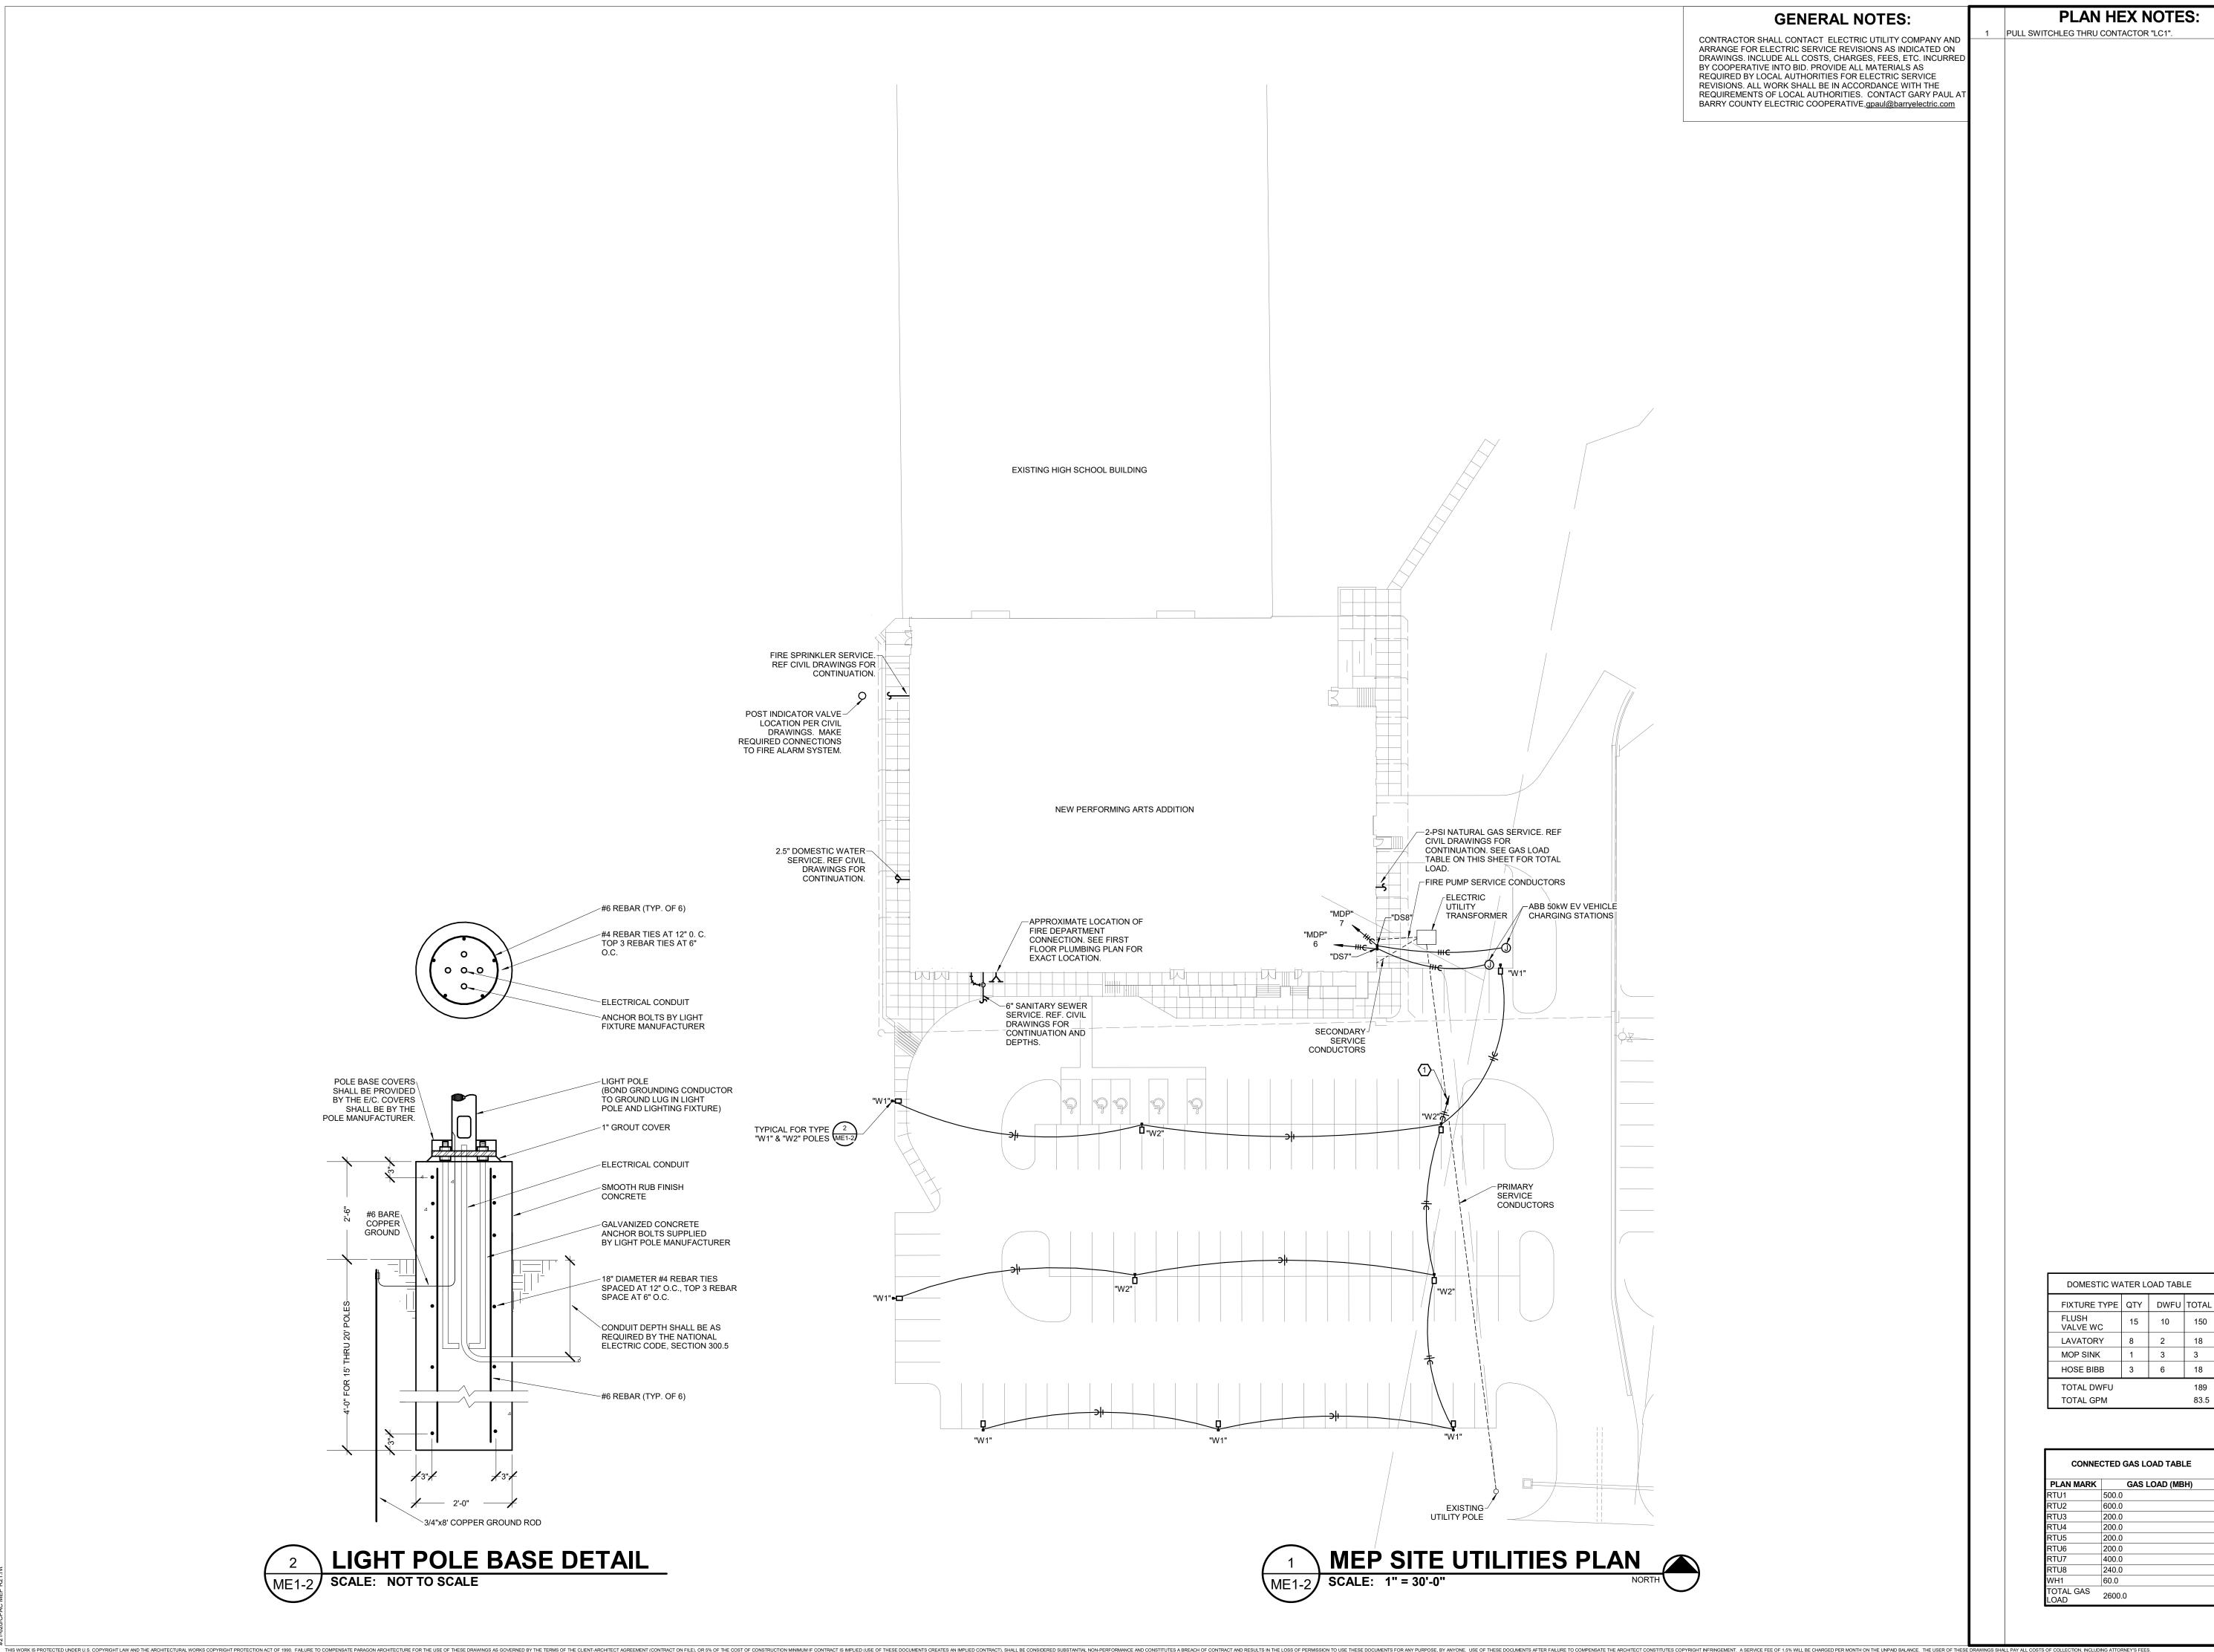

PLAN HEX NOTES: PULL SWITCHLEG THRU CONTACTOR "LC1".

> MISSOURI STATE CERTIFICATE OF AUTHORITY NUMBER A-2016000415 637 COLLEGE STREET

SPRINGFIELD, MO 65806


PH: 417.885.0002 www.paragonarchitecture.com



3333 E. Battlefield Rd | Suite 1000 Springfield, MO 65804 417.881.0020 | www.rtmec.com

STATE OF MISSOURI CERTIFICATE OF AUTHORITY: 2014035826 FOR ENGINEERING

JENNIFER A. LUCE E-2001018772

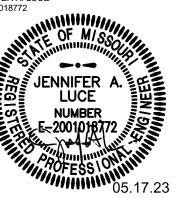

REVISION SCHEDULE

ARTS PERFORMING HS

CAS CEI PROJECT ENGINEER: JAL DRAWN BY: CHECKED BY:

PROJECT NUMBER: 21-620

DATE: 05-17-2023


83.5

GAS LOAD (MBH)

SITE UTILITIES PLAN

SHEET NUMBER:

ME1-2

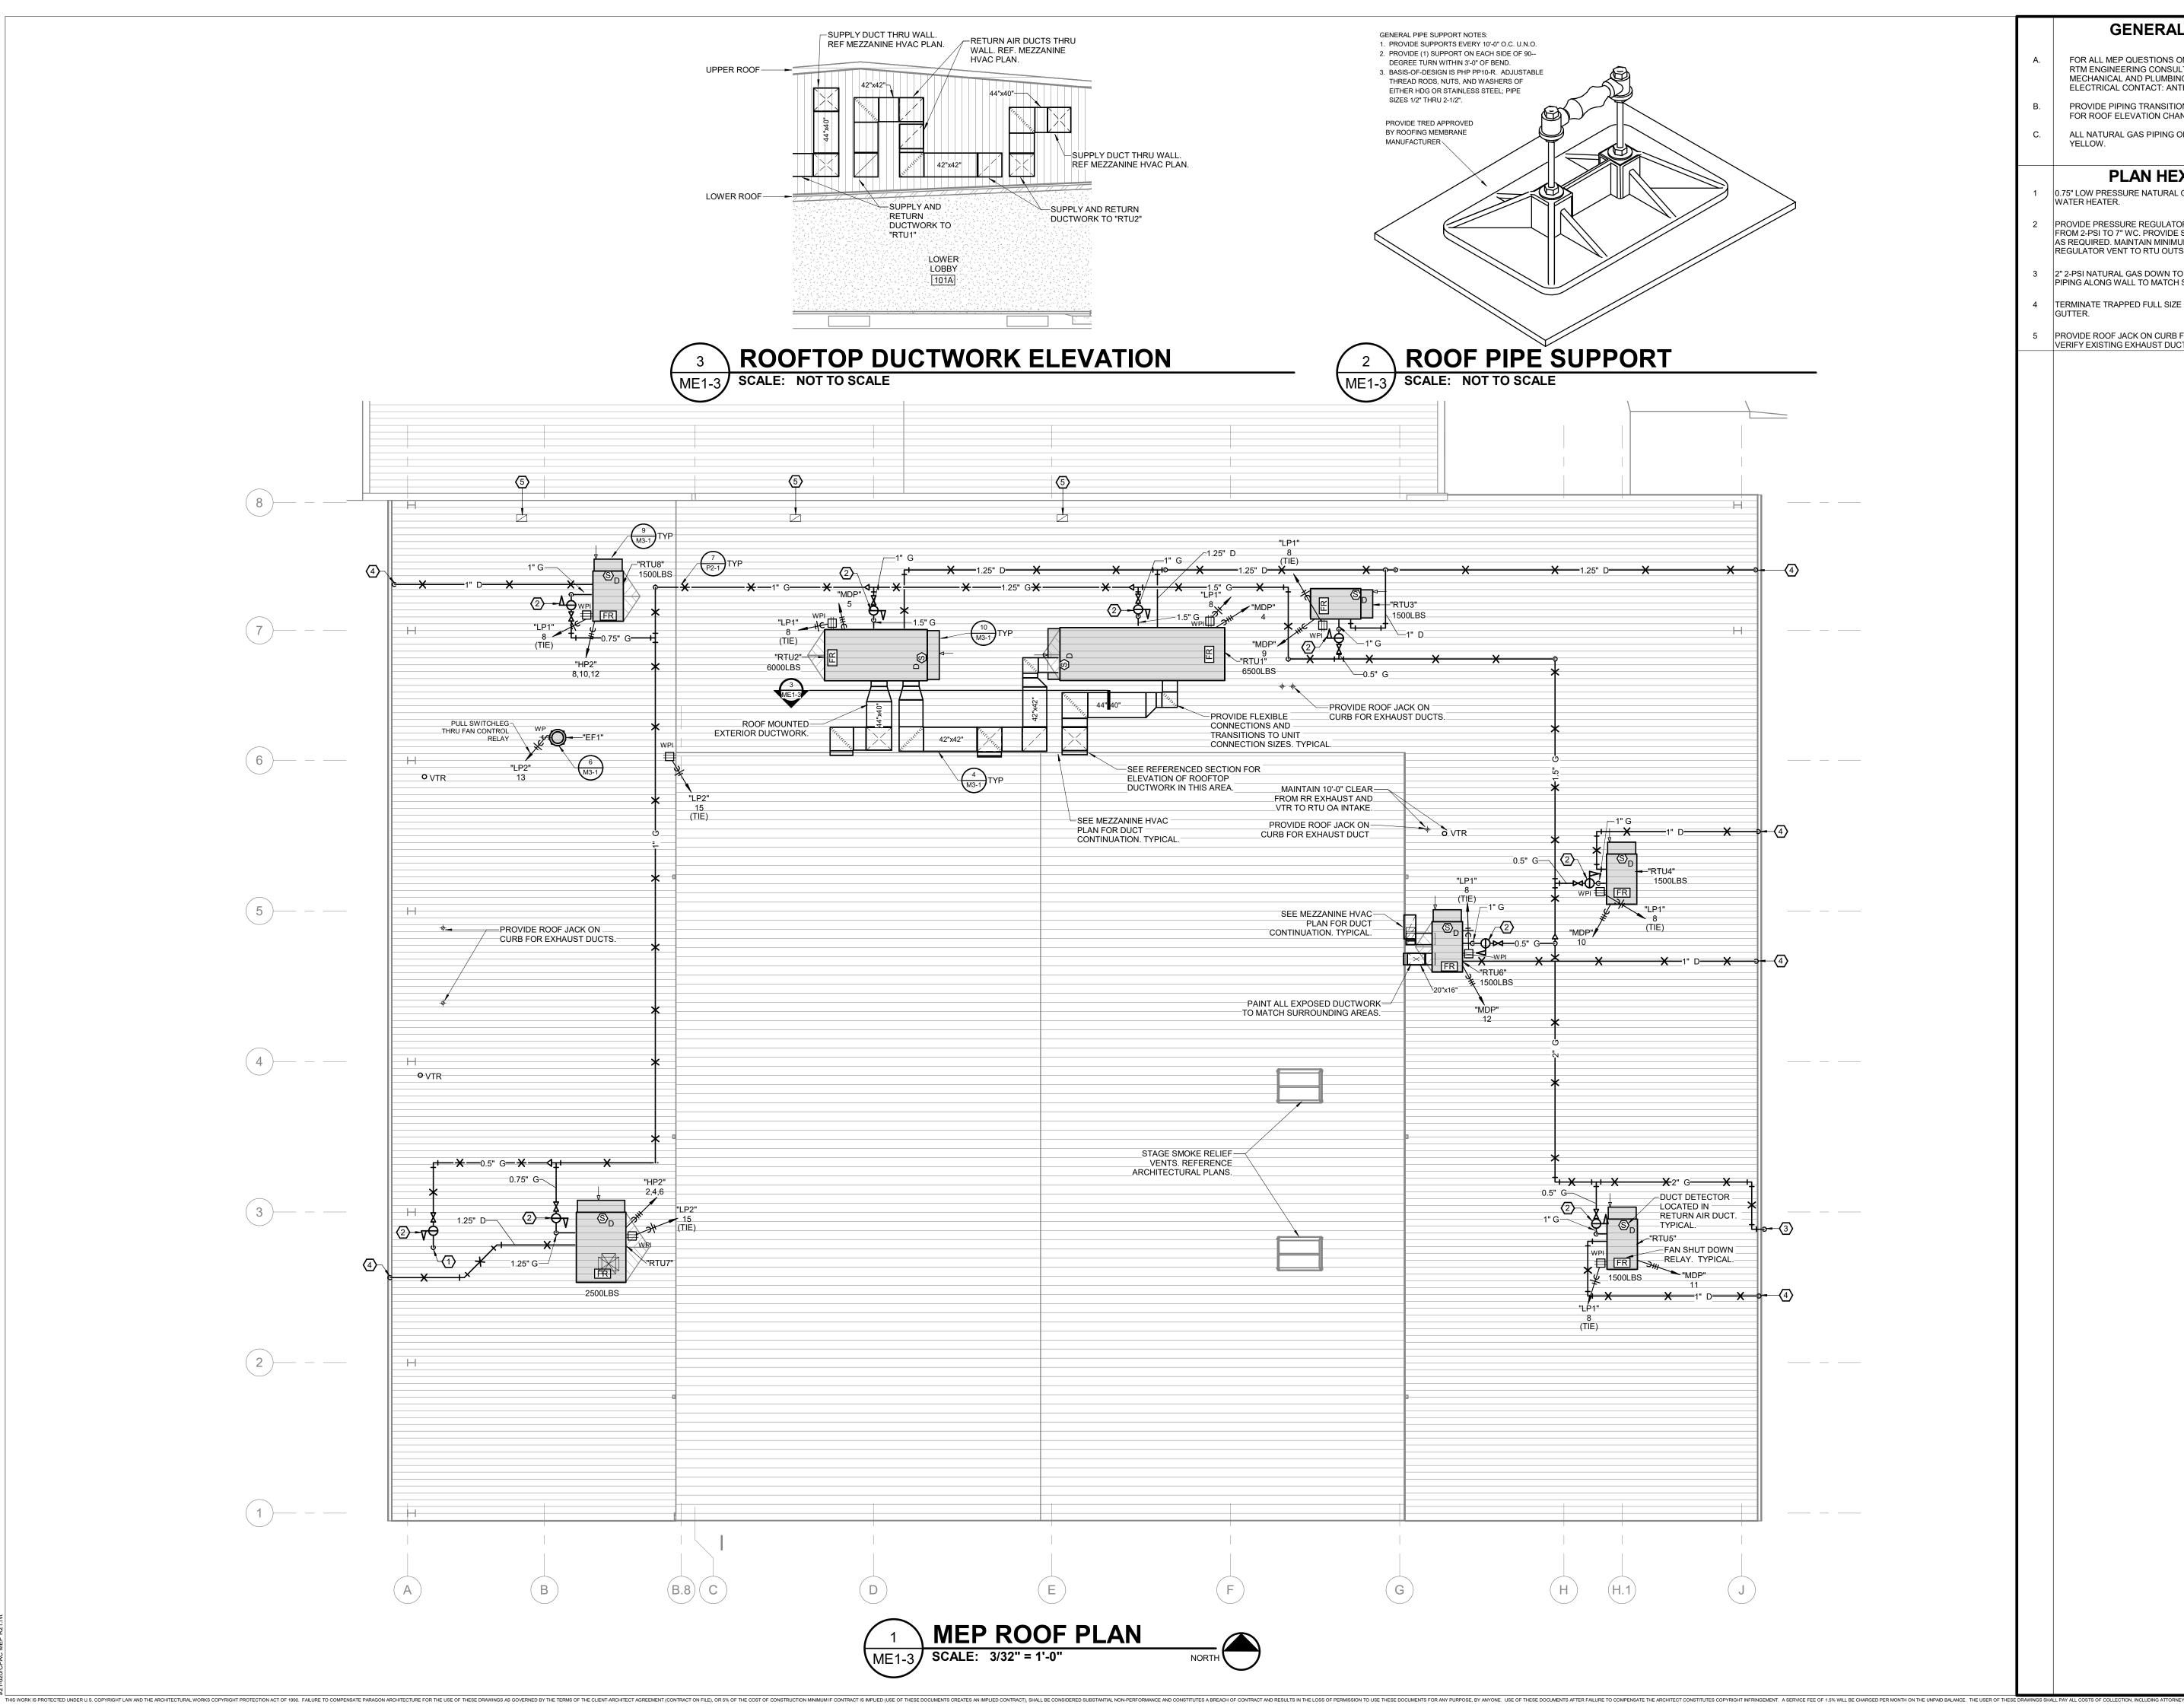

GENERAL NOTES:

- FOR ALL MEP QUESTIONS ON THIS PROJECT, CONTACT RTM ENGINEERING CONSULTANTS AT (417) 881-0020.
 MECHANICAL AND PLUMBING CONTACT: TYLER ENSERRO.
 ELECTRICAL CONTACT: ANTHONY BEIER.
- PROVIDE PIPING TRANSITIONS/OFFSETS AS REQUIRED FOR ROOF ELEVATION CHANGES.
- ALL NATURAL GAS PIPING ON ROOF SHALL BE PAINTED

PLAN HEX NOTES:

0.75" LOW PRESSURE NATURAL GAS DOWN THRU ROOF TO WATER HEATER.

- PROVIDE PRESSURE REGULATOR TO REDUCE NATURAL GAS FROM 2-PSI TO 7" WC. PROVIDE SHUT OFF VALVES AND UNIONS AS REQUIRED. MAINTAIN MINIMUM OF 5'-0" CLEAR FROM REGULATOR VENT TO RTU OUTSIDE AIR INTAKES.
- 2" 2-PSI NATURAL GAS DOWN TO METER. PAINT ALL EXPOSED PIPING ALONG WALL TO MATCH SURROUNDING AREA.
- TERMINATE TRAPPED FULL SIZE CONDENSATE DRAIN OVER
- PROVIDE ROOF JACK ON CURB FOR EXHAUST DUCTS. FIELD VERIFY EXISTING EXHAUST DUCT SIZE.



SPRINGFIELD, MO 65806

PH: 417.885.0002 www.paragonarchitecture.com



3333 E. Battlefield Rd | Suite 1000 Springfield, MO 65804 417.881.0020 | www.rtmec.com

STATE OF MISSOURI CERTIFICATE OF AUTHORITY: 2014035826 FOR ENGINEERING

JENNIFER A. LUCE E-2001018772



THESE PRINTS ARE THE PROPERTY OF PARAGON ARCHITECTURE, LLC AND SHALL BE USED ONLY FOR THE PROJECT REFERENCE BELOW

REVISION SCHEDULE

PERFORMING


PROJECT NUMBER: 21-620

05-17-2023

MEP ROOF PLAN

SHEET NUMBER:

ME1-3

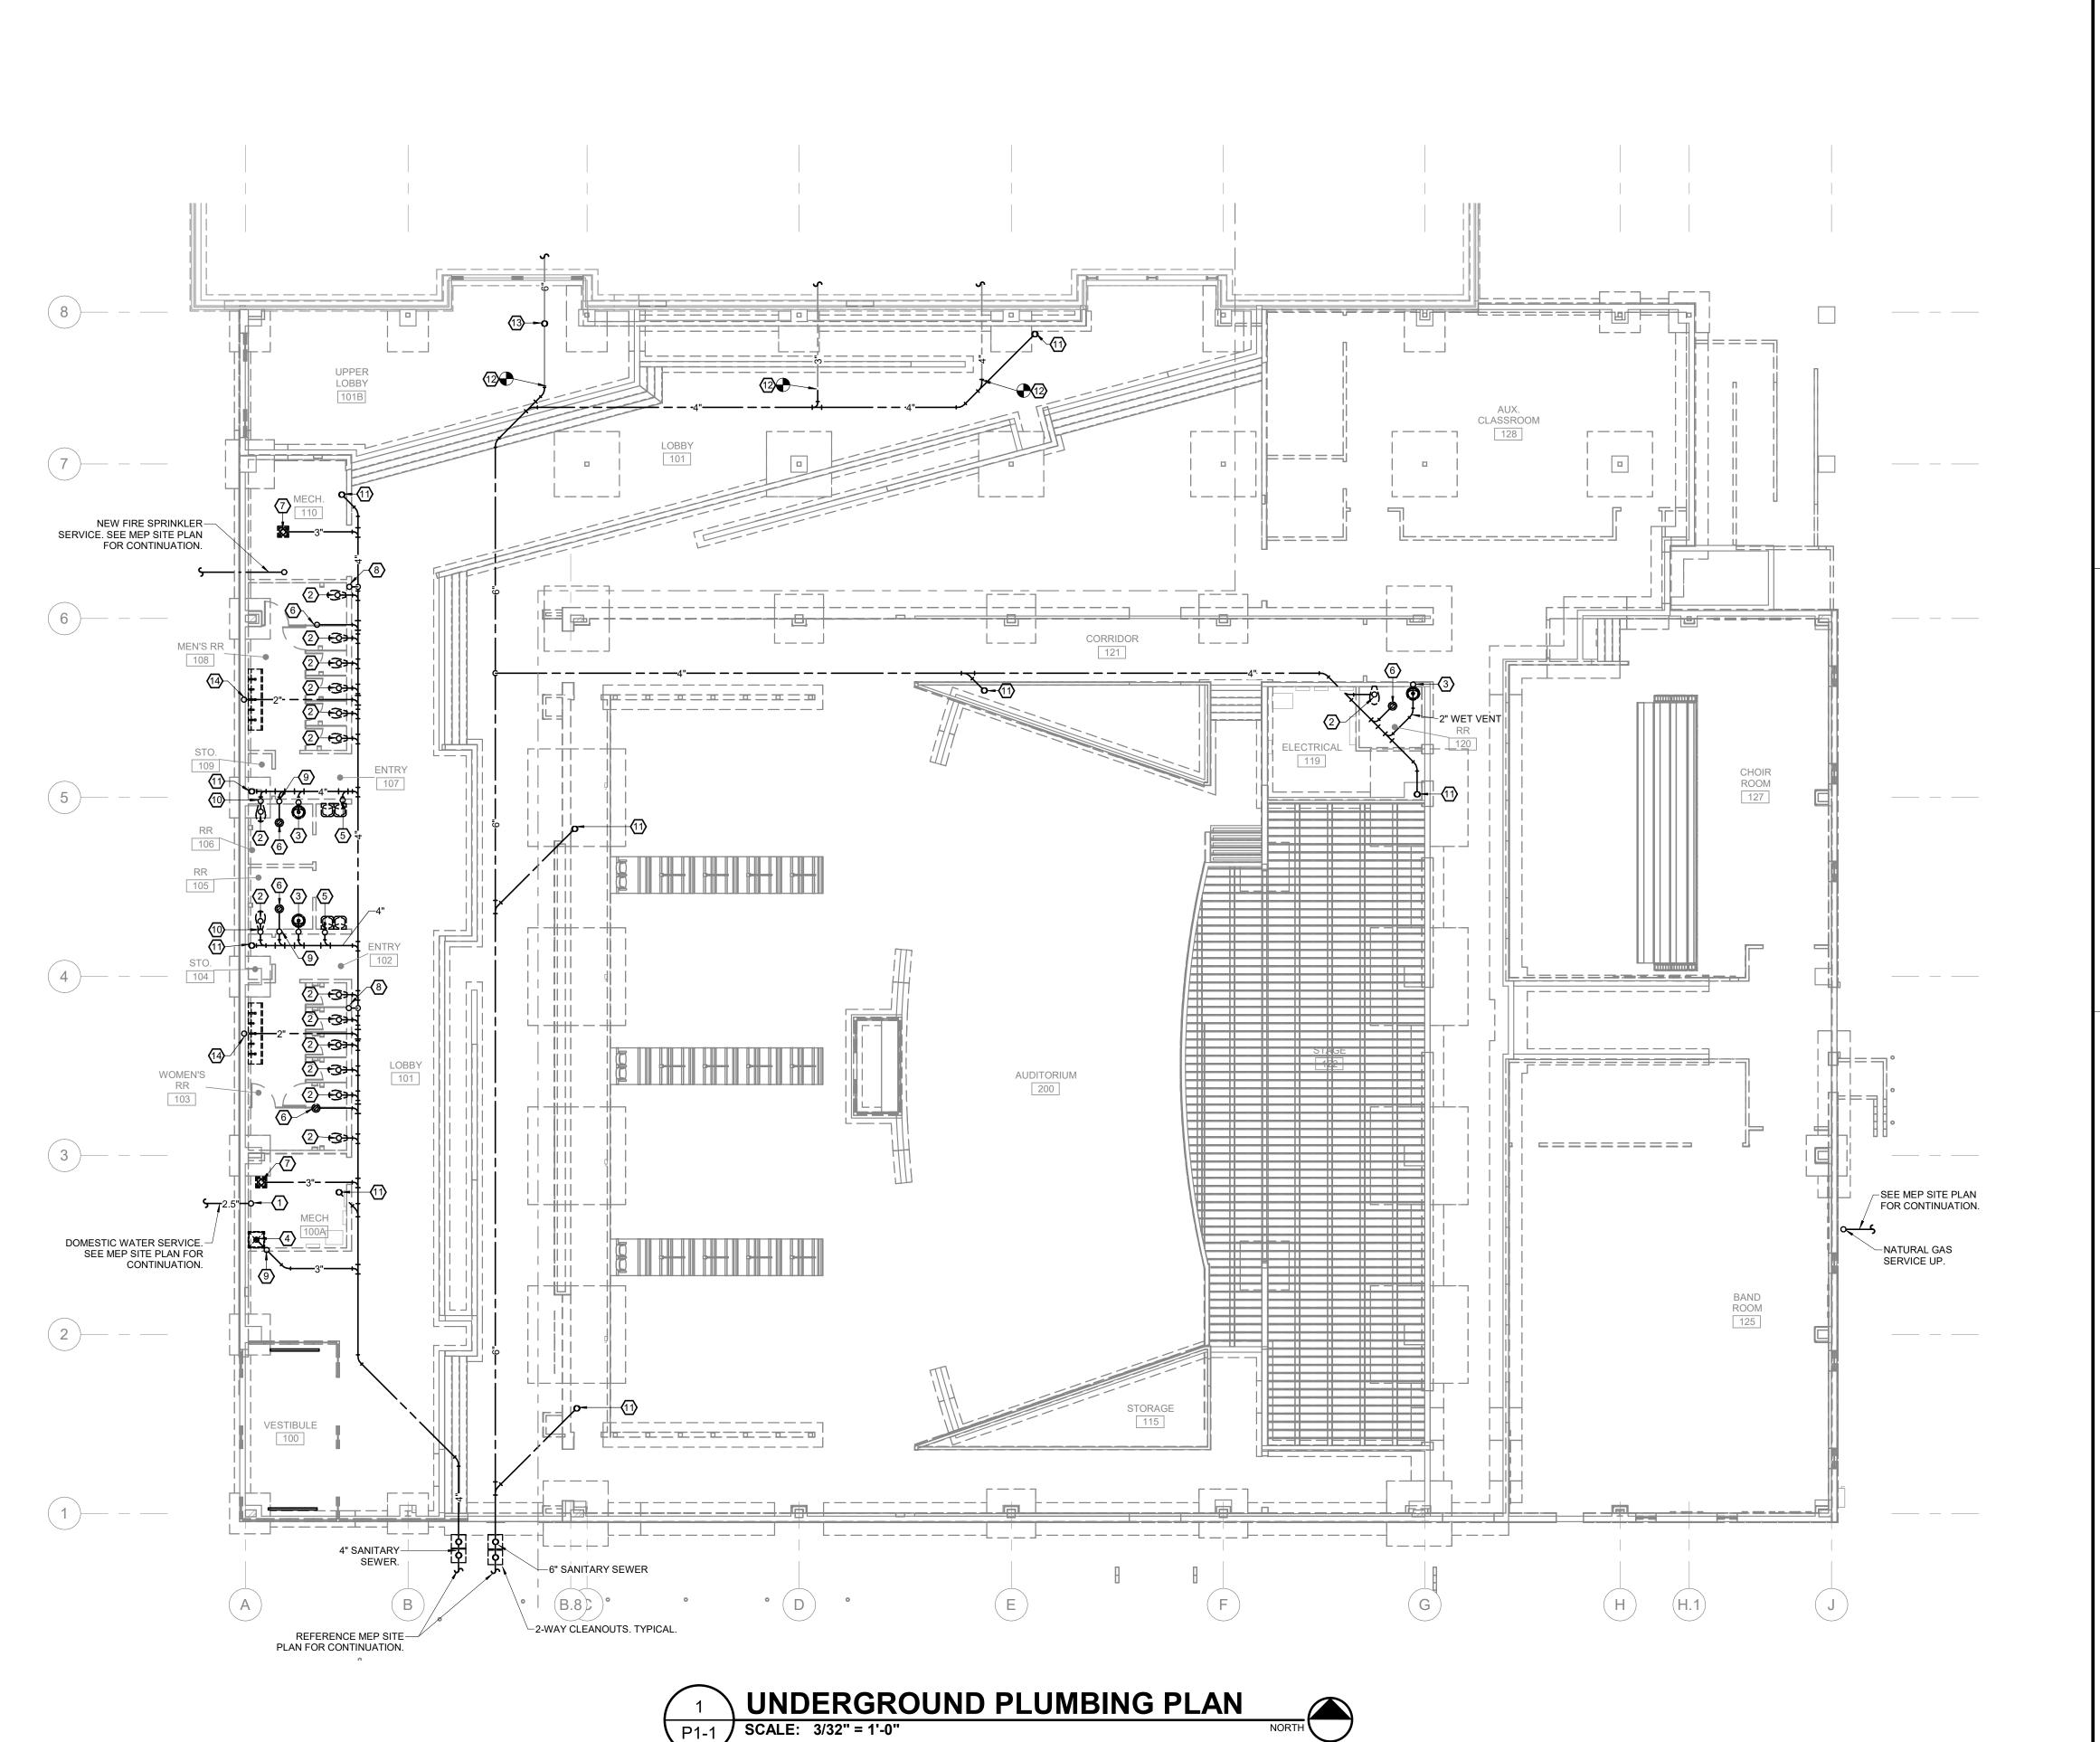

THIS WORK IS PROTECTED UNDER U.S. COPYRIGHT LAW AND THE ARCHITECT U.S. COPYRIGHT LAW AND THE ARCHITECT CONSTRUCTION MINIMUM IF CONTRACT AND RESULTS IN THE LOSS OF PERMISSION TO USE THESE DOCUMENTS FOR ANY PURPOSE, BY ANYONE. USE OF THESE DOCUMENTS FOR ANY PURPOSE, BY ANYONE. USE OF THESE DOCUMENTS CREATES AN IMPLIED CONTRACT ON FILE U.S. OF THE SECOND FOR THE LOSS OF PERMISSION TO USE THE SECOND FOR THE LOSS OF TH

GENERAL NOTES:

- ALL PLUMBING WORK SHALL BE IN ACCORDANCE WITH THE 2006 EDITION OF THE INTERNATIONAL PLUMBING
- CODE AS ADOPTED BY THE CITY OF CASSVILLE, MO. FOR ALL MECHANICAL QUESTIONS ON THIS PROJECT, CONTACT RTM ENGINEERING CONSULTANTS AT (417) 881-0020. CONTACT: TYLER ENSERRO.
- tyler.enserro@rtmec.com. CONTRACTOR SHALL SECURE AND PAY FOR NECESSARY MEP PERMITS AND CERTIFICATES OF INSPECTION
- REQUIRED BY GOVERNMENTAL ORDINANCES, LAWS, RULES, OR REGULATIONS.
- FINAL ACCEPTANCE OF WORK SHALL BE SUBJECT TO THE CONDITION THAT ALL SYSTEMS, EQUIPMENT, APPARATUS. AND APPLIANCES OPERATE SATISFACTORILY AS DESIGNED AND INTENDED; WORK SHALL INCLUDE REQUIRED REPLACEMENT, ADJUSTMENT OF SYSTEMS AND CONTROL EQUIPMENT AND ALL REQUIRED PROGRAMMING INSTALLED. PROVIDE FOR ALL WORK INDICATED ON DRAWINGS OR AS REASONABLY IMPLIED.
- PROVIDE NECESSARY MATERIALS AND ACCESSORIES FOR INSTALLATION OF FIXTURES, EQUIPMENT, ETC AS REQUIRED FOR COMPLETE AND FUNCTIONAL OPERATION AS NOTED ON DRAWINGS OR IN NOTES.
- ACCESS PANELS SHALL BE PROVIDED WHEREVER NECESSARY TO PROVIDE ACCESS TO VALVES, JUNCTION BOXES, ETC., LOCATED IN CONCEALED SPACES.
- ALL EQUIPMENT, FIXTURES, MATERIALS, ETC SHALL BE INSTALLED IN NEAT, PROFESSIONAL MANNER IN ACCORDANCE WITH MANUFACTURER RECOMMENDATIONS.
- THE CONTRACTOR SHALL CONTACT THE OWNER AND COORDINATE ALL OUTAGES 5 DAYS PRIOR TO ANY SHUT-OFF OF SERVICES.
- PROVIDE ALL FIRE RATED MATERIAL FOR PATCH AND REPAIR FOR ALL FIRE RATED ASSEMBLIES. ALL OPENINGS SHALL BE SEALED AND CLOSED IN APPROVED MANNER. PROVIDE SLEEVE WHERE NEEDED DUE TO SCOPE OF WORK.
- EXISTING CONDITIONS ON THIS SET OF BID DOCUMENTS WERE TAKEN FROM EXISTING DRAWINGS, LIMITED SITE VISITS, AND VISUAL OBSERVATIONS. FIELD VERIFY ALL EXISTING CONDITIONS PRIOR TO SUBMITTING FINAL BIDS. CHANGE ORDERS WILL NOT BE PAID DUE TO UNANTICIPATED CONDITIONS TO MEET INTENT OF WORK.
- CONTRACTOR SHALL SCHEDULE AND EXECUTE ALL WORK WITH REGARD TO THE OWNER'S USE OF THE BUILDING.
- PLANS ARE DIAGRAMMATIC AND SHALL NOT BE SCALED. REFER TO ARCHITECTURAL DRAWINGS FOR DIMENSIONS

PLAN HEX NOTES:

- 2.5" DOMESTIC WATER SERVICE UP
- 4" WASTE UP TO WATER CLOSET.
- 3 2" WASTE UP TO LAVATORY.
- 4 3" TRAPPED WASTE UP TO JANITOR'S BASIN.
- 5 2" WASTE UP TO WATER COOLER.
- 2" TRAPPED WASTE UP TO FLOOR DRAIN WITH TRAP GUARD
- 3" TRAPPED WASTE UP TO FLOOR DRAIN WITH TRAP GUARD
- 8 3" CIRCUIT VENT UP. OFFSET TO WALL AT A MINIMUM 45 DEGREE ANGLE FROM HORIZONTAL.
- 9 1.5" VENT UP.
- 10 2" VENT UP.
- 11 4" WASTE UP TO FINISHED FLOOR CLEANOUT.
- CONNECT NEW WASTE PIPING TO EXISTING. FIELD VERIFY EXISTING DEPTH AND LOCATION AND RE-ROUTE THE WASTE FROM THE EXISTING BUILDING AS SHOWN.
- 13 6" WASTE UP TO FINISHED FLOOR CLEANOUT.
- 14 2" WASTE UP TO HAND WASH BASIN. PROVIDE TRAPPED CONNECTION TO EACH

MISSOURI STATE CERTIFICATE OF AUTHORITY NUMBER A-2016000415 637 COLLEGE STREET SPRINGFIELD, MO 65806



PH: 417.885.0002 www.paragonarchitecture.com

engineering consultants 3333 E. Battlefield Rd | Suite 1000 Springfield, MO 65804 417.881.0020 | www.rtmec.com

STATE OF MISSOURI CERTIFICATE OF AUTHORITY: 2014035826 FOR ENGINEERING

JENNIFER A. LUCE E-2001018772



ESE PRINTS ARE THE PROPERTY OF PARAGON FECTURE, LLC AND SHALL BE USED ONLY FOR THE PROJECT REFERENCE BELOW

REVISION SCHEDULE

ORMING PERF S

PROJECT ENGINEER: JAL DRAWN BY: CHECKED BY:


PROJECT NUMBER: 21-620

05-17-2023

UNDERGROUND PLUMBING PLAN

SHEET NUMBER:

P1-1

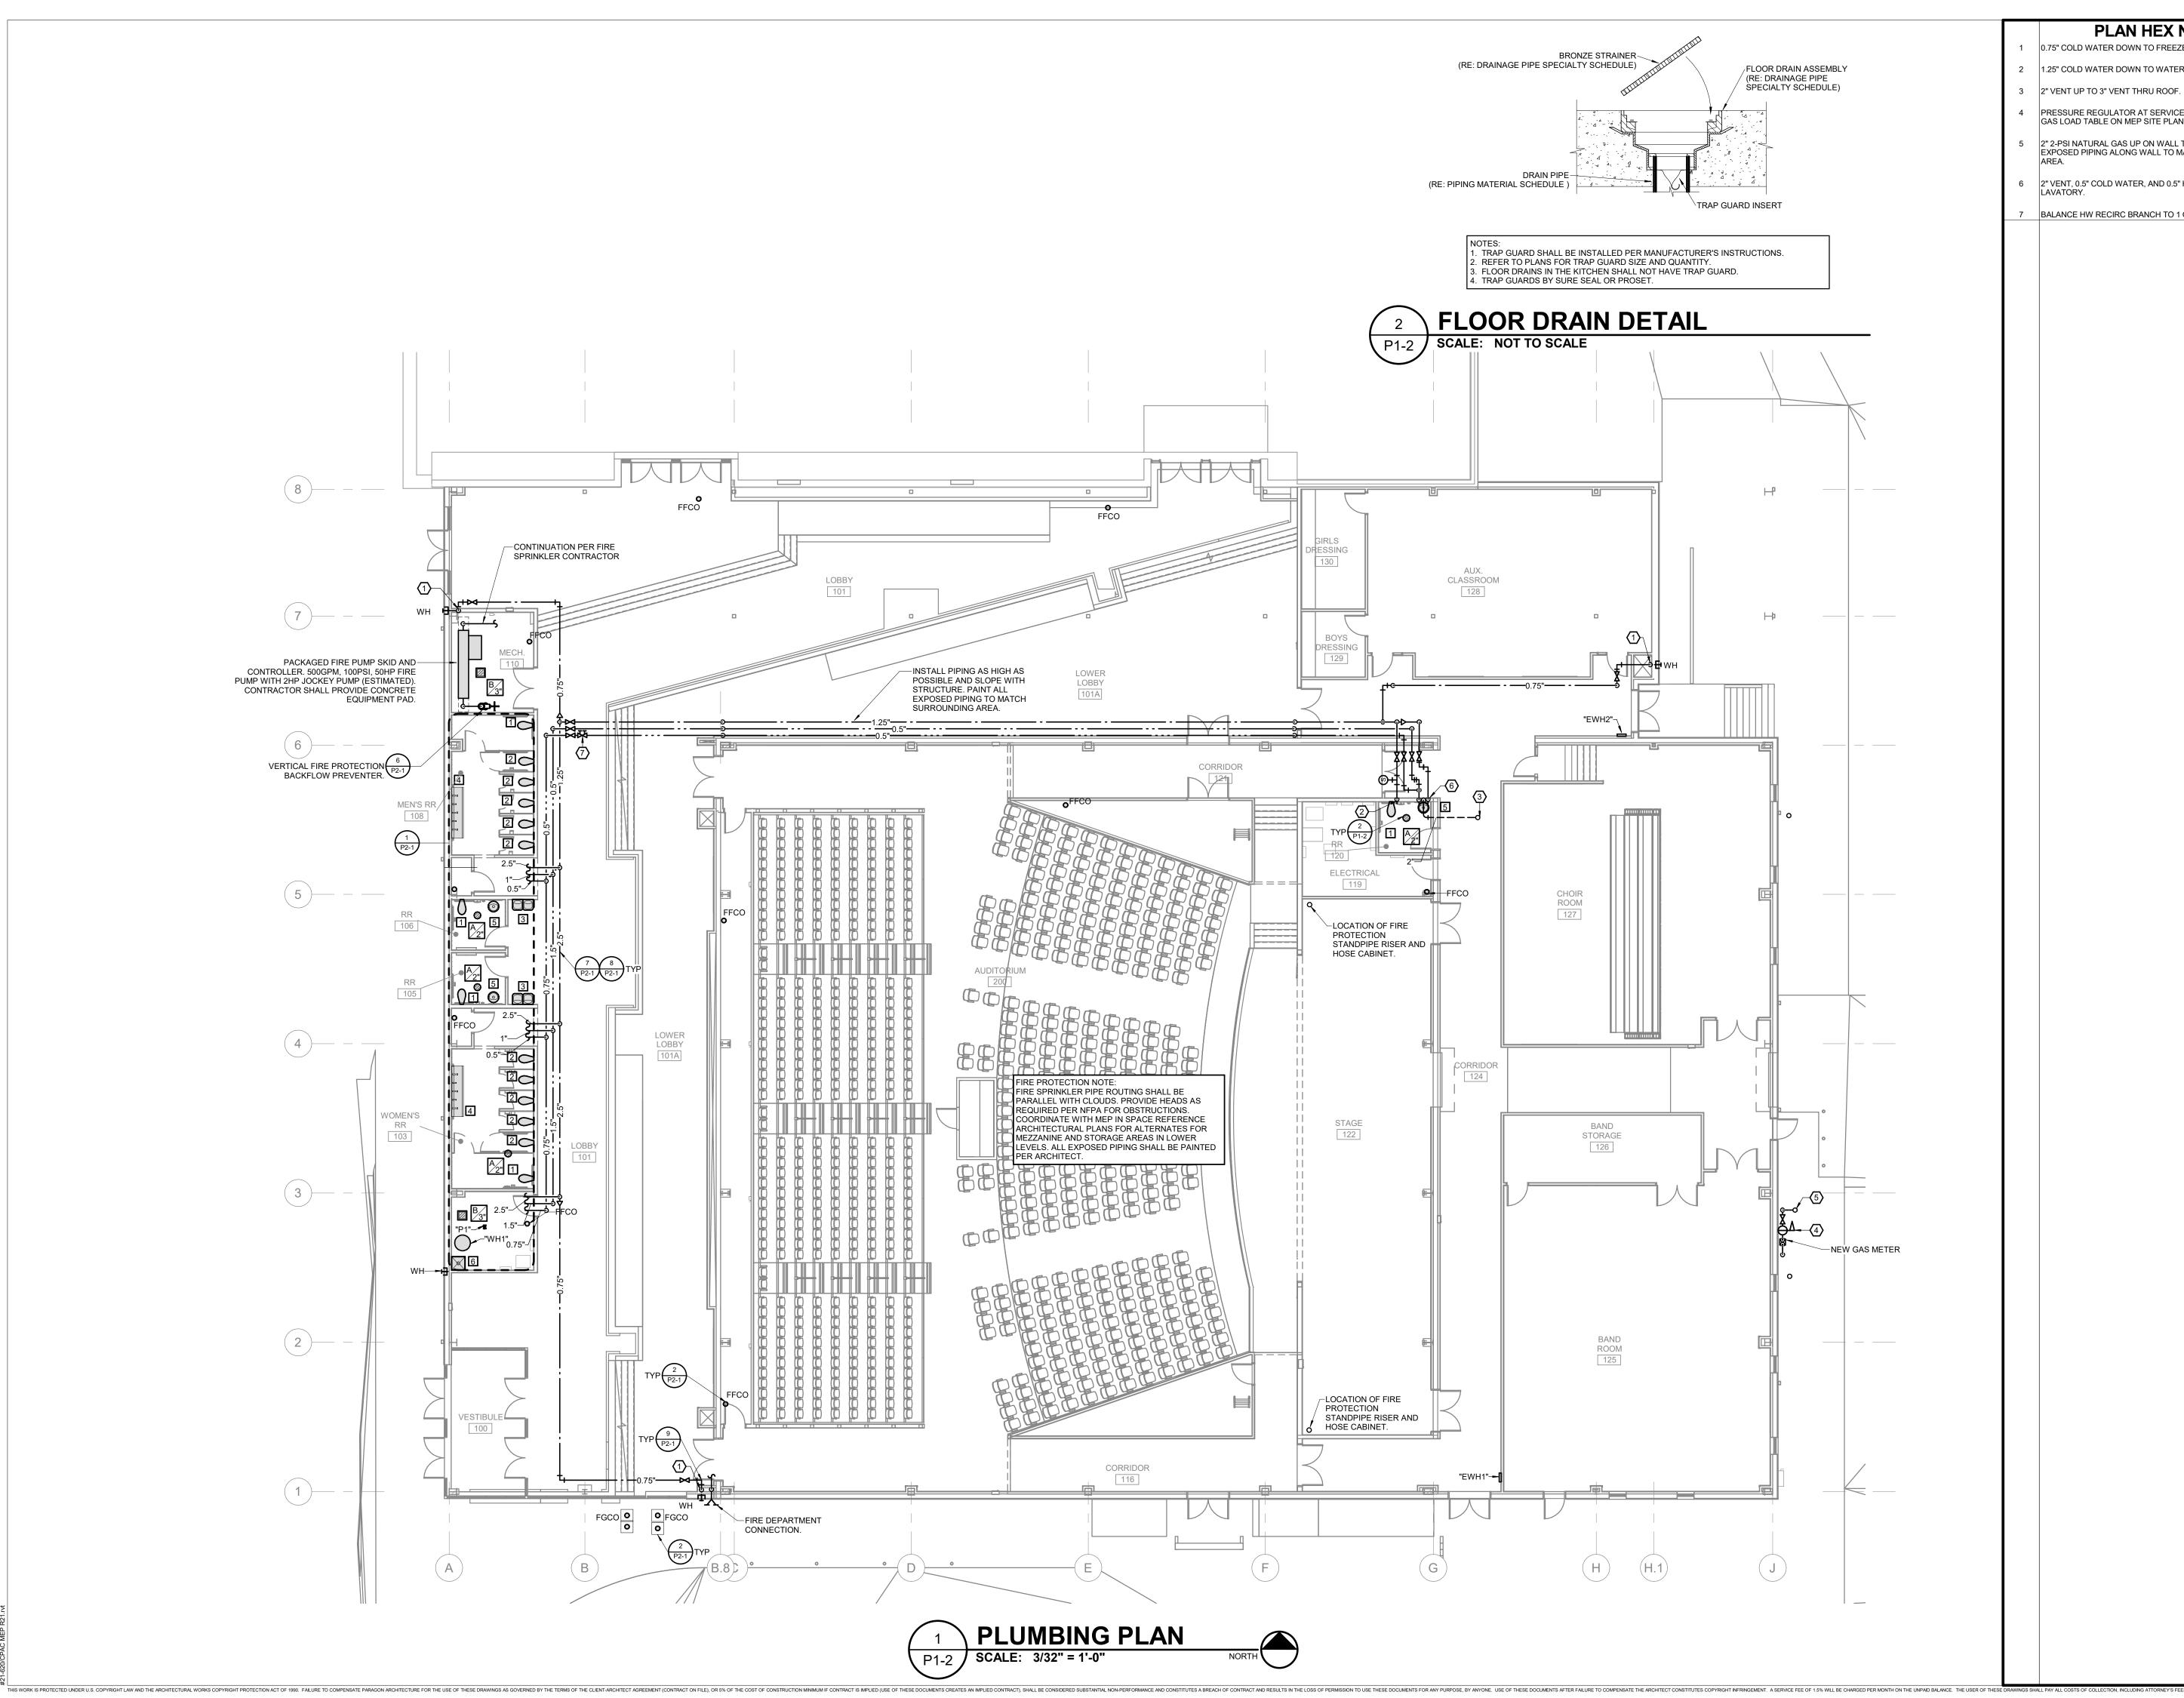

PLAN HEX NOTES:

- 0.75" COLD WATER DOWN TO FREEZE PROOF WALL HYDRANT.
- 1.25" COLD WATER DOWN TO WATER CLOSET.
- PRESSURE REGULATOR AT SERVICE. SET AT 2-PSI. REFERENCE GAS LOAD TABLE ON MEP SITE PLAN FOR ANTICIPATED LOAD.
- 2" 2-PSI NATURAL GAS UP ON WALL TO ROOF. PAINT ALL EXPOSED PIPING ALONG WALL TO MATCH SURROUNDING
- 2" VENT, 0.5" COLD WATER, AND 0.5" HOT WATER DOWN TO
- BALANCE HW RECIRC BRANCH TO 1 GPM.



637 COLLEGE STREET SPRINGFIELD, MO 65806


PH: 417.885.0002 www.paragonarchitecture.com



3333 E. Battlefield Rd | Suite 1000 Springfield, MO 65804 417.881.0020 | www.rtmec.com

STATE OF MISSOURI CERTIFICATE OF AUTHORITY: 2014035826 FOR ENGINEERING

JENNIFER A. LUCE E-2001018772

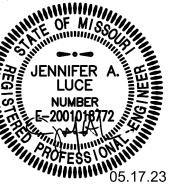

REVISION SCHEDULE

PERFORMING

HS


PROJECT NUMBER: 21-620

05-17-2023

FIRST FLOOR PLUMBING PLAN

SHEET NUMBER:

P1-2

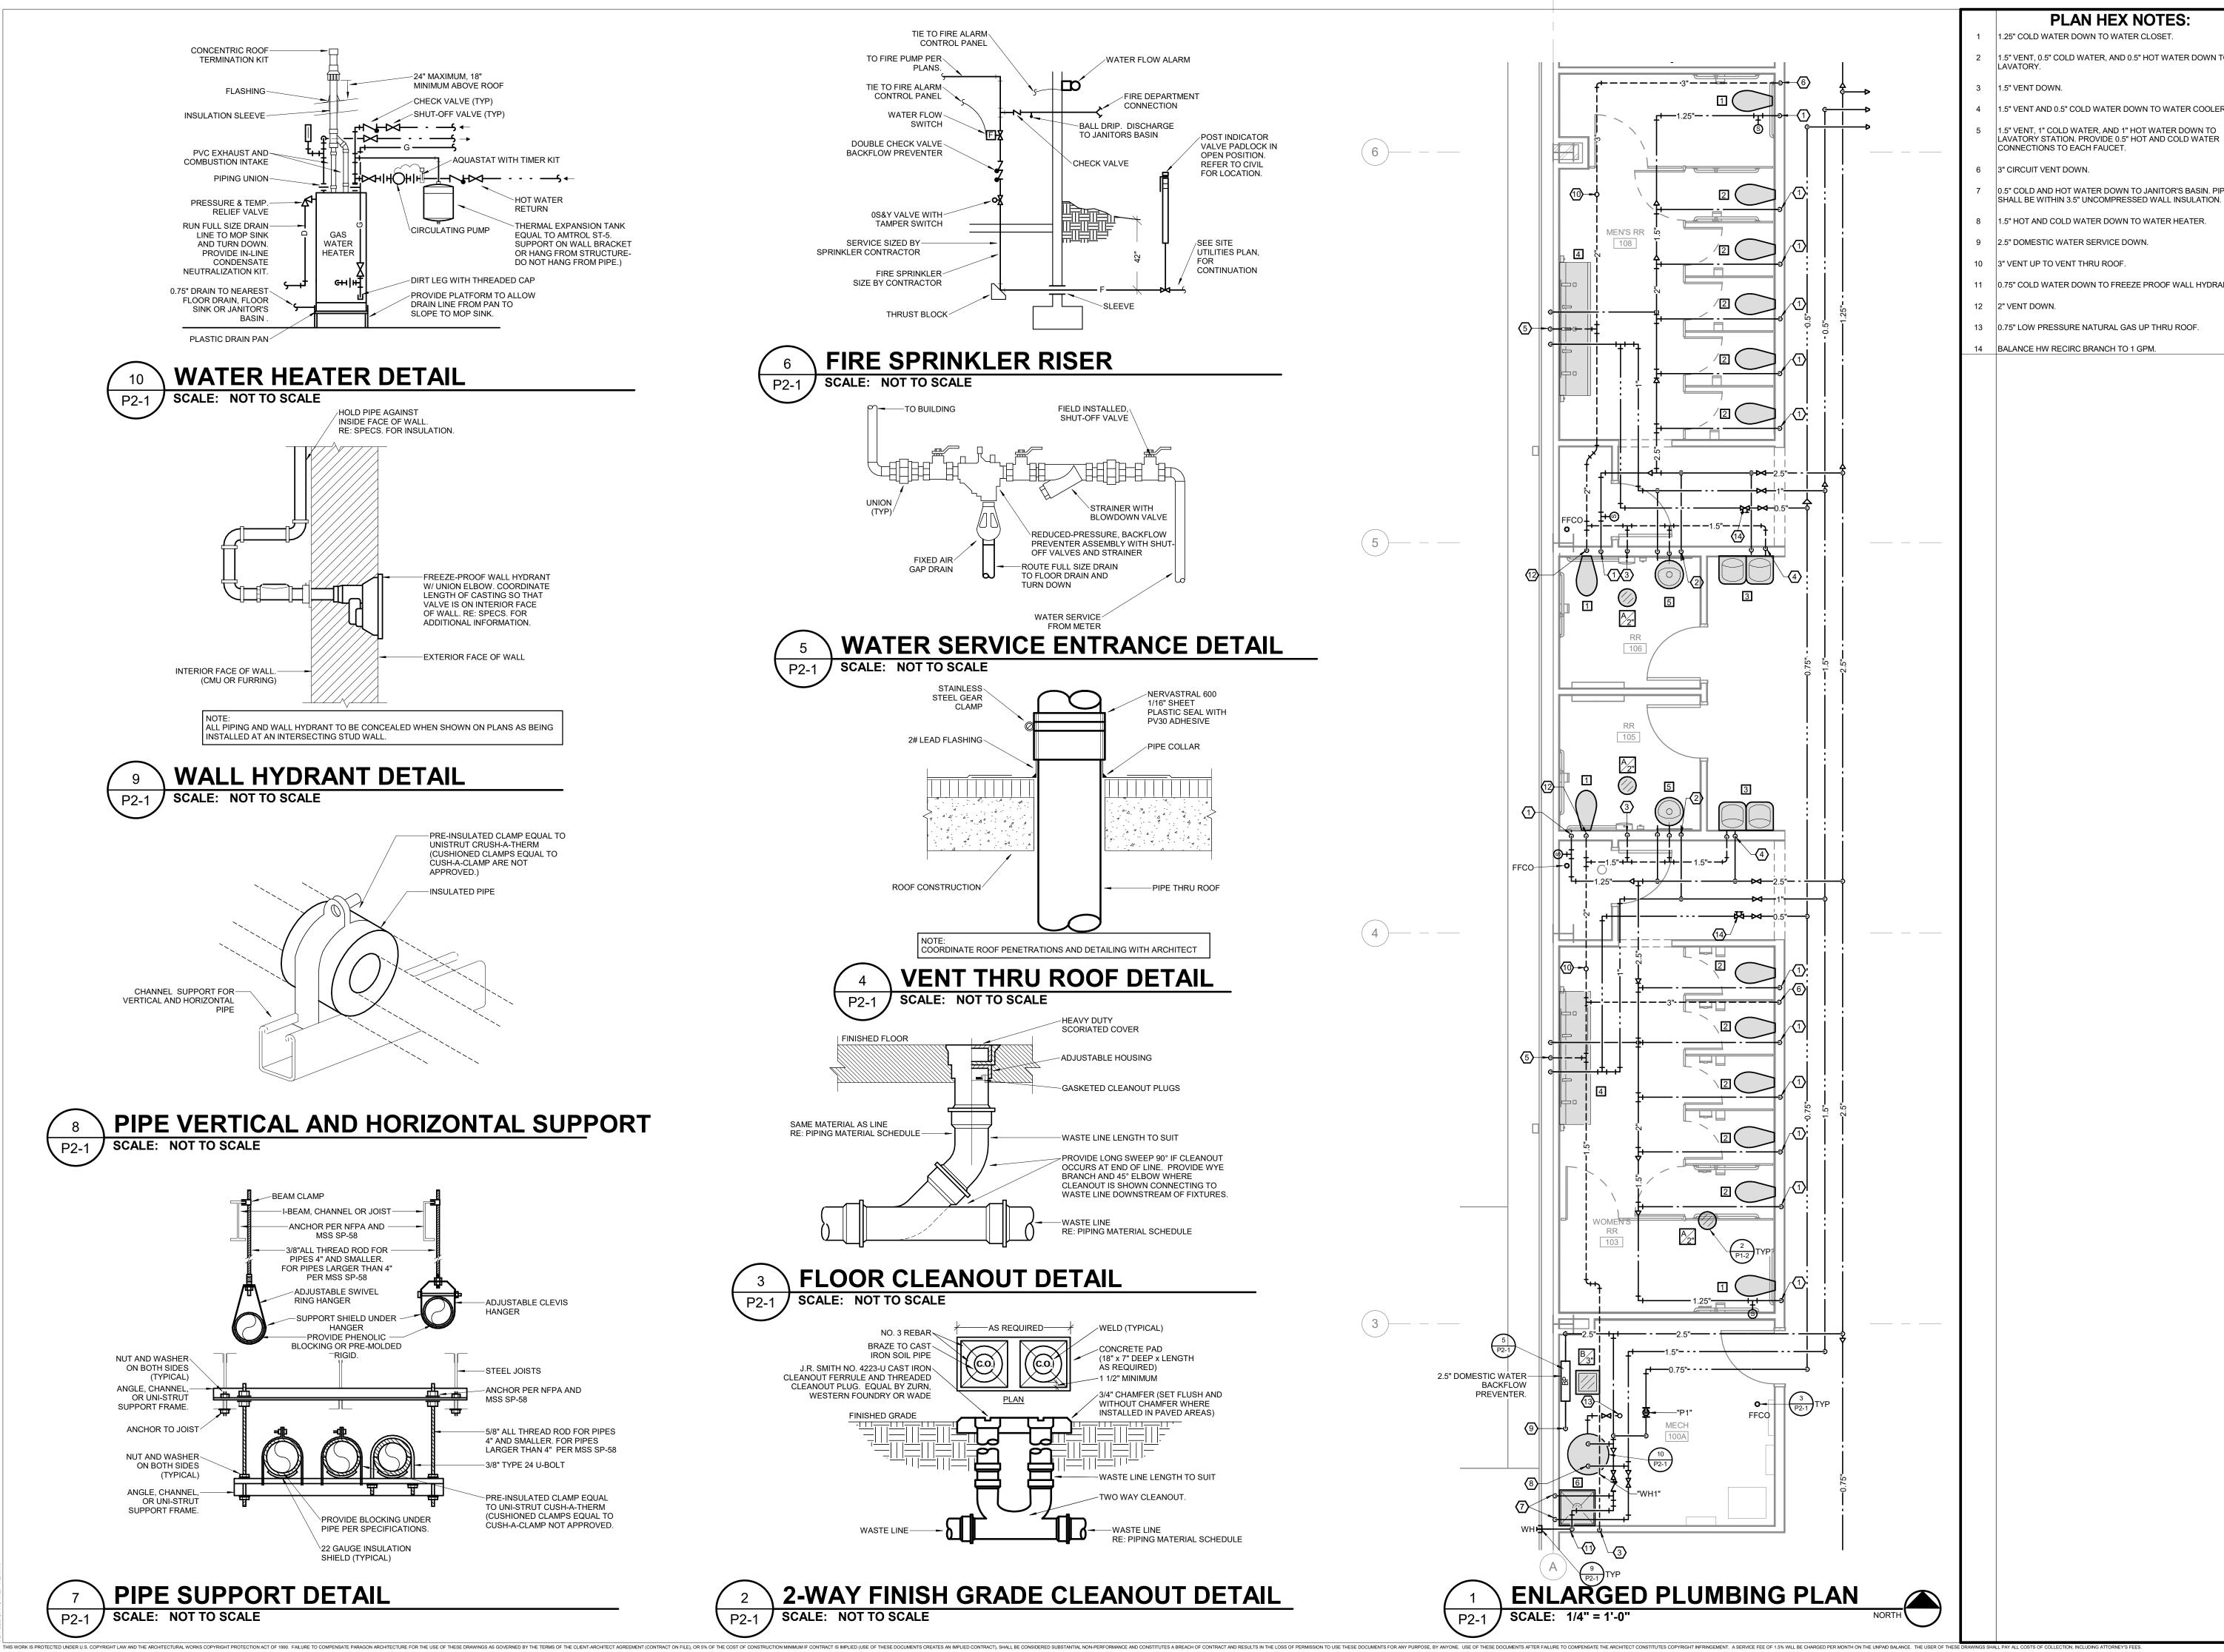

PLAN HEX NOTES:

1.25" COLD WATER DOWN TO WATER CLOSET

1.5" VENT, 0.5" COLD WATER, AND 0.5" HOT WATER DOWN TO

1.5" VENT AND 0.5" COLD WATER DOWN TO WATER COOLERS.

0.5" COLD AND HOT WATER DOWN TO JANITOR'S BASIN. PIPING SHALL BE WITHIN 3.5" UNCOMPRESSED WALL INSULATION.

1.5" HOT AND COLD WATER DOWN TO WATER HEATER.

11 0.75" COLD WATER DOWN TO FREEZE PROOF WALL HYDRANT.

637 COLLEGE STREET SPRINGFIELD, MO 65806

PH: 417.885.0002

www.paragonarchitecture.com

3333 E. Battlefield Rd | Suite 1000 Springfield, MO 65804 417.881.0020 | www.rtmec.com

CERTIFICATE OF AUTHORITY 2014035826 FOR ENGINEERING

STATE OF MISSOURI

JENNIFER A. LUCE E-2001018772

ESE PRINTS ARE THE PROPERTY OF PARAGON FECTURE, LLC AND SHALL BE USED ONLY FOR THE PROJECT REFERENCE BELOW

REVISION SCHEDULE

ORMING R

> PROJECT ENGINEER: JAL DRAWN BY: CHECKED BY:


PROJECT NUMBER: 21-620

05-17-2023

PLUMBING DETAILS

SHEET NUMBER:

P2-1

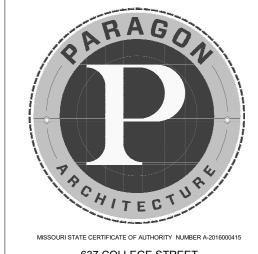

637 COLLEGE STREET SPRINGFIELD, MO 65806

PH: 417.885.0002 www.paragonarchitecture.com



STATE OF MISSOURI CERTIFICATE OF AUTHORITY: 2014035826 FOR ENGINEERING



REVISION SCHEDULE

W	ATER I	HEATE	ER SC	CHEC)UL	E.							
							GAS HEATIN	√G	ELI	ECTRICAL	DATA		
PLAN				GALLON	GPH @	INPUT	OUTPUT	EFFICIENCY				MOCP	
MARK	MANUFACTURER	MODEL	TYPE	CAPACITY	100 F	(BTU/H)	(BTU/H)	(%)	VOLTAGE	PHASE	MCA	(A)	NOTES
WH1	BRADFORD WHITE	LG2PDV50H603N	GAS	48	58	60000	57600	96	120	1	1	15	CNK, PTRV

Pl	JMP SC	CHEI	DU	LE													
									WORK		ELECT	RICAL DATA				FLUID	
PLAN				INLET		TOTAL HEAD				MOTOR				BODY	FLUID	TEMPERATURE	
MARK	MANUFACTURER	SERIES	SIZE	(IN)	(GPM)	(FT HD)	(FT HD)	TYPE	(PSI)	(HP)	RPM	VOLTAGE	PHASE	CONSTRUCTION	PUMPED	(°F)	NOTES
P1	BELL & GOSSETT	NFB	36	0.75"	10	25	10	IL	150	0.06	4600	120	1	AB	DHW	140	AB, AQ,T

DF	RAINAGE PIF	PE SP	ECIA	LTY SCHEDULE	
PLAN MARK	DESCRIPTION	MANUFACTUR ER	MODEL	TRIM	NOTES
Α	7" ROUND FLOOR DRAIN	J.R. SMITH	2010-A	NICKEL BRONZE STRAINER, DEEP SEAL TRAP, SURE SEAL WATERLESS TRAP PRIMER	DRAIN SIZE SHALL MATCH SANITARY BRANCH SERVING DRAIN. REFERENCE PLANS FOR SIZE.
В	HOPPER STYLE FLOOR DRAIN WITH SEDIMENT BUCKET AND GRATE.	J.R. SMITH	2630	FLANGE, CAST IRON BODY, GRATE, SEDIMENT BUCKET.	DRAIN SIZE SHALL MATCH SANITARY BRANCH SERVING DRAIN. REFERENCE PLANS FOR SIZE.
FFCO	FINISHED FLOOR CLEANOUT	J.R. SMITH	4023		VERIFY FLOOR MATERIALS USED FROM ARCHITECTURAL PLANS. CLEANOUT TO BE FULL SIZE OF SOIL PIPE UP TO AND INCLUDING 4-INCH ID. REFERENCE PLANS FOR SOIL PIPE SIZE.
FGCO	FINISHED GRADE CLEANOUT	J.R. SMITH	4223-U	EXTRA HEAVY DUTY CAST IRON VANDAL PROOF TOP.	IF NOT LOCATED IN CONCRETE, PROVIDE 18"x18"x7" CONCRETE PAD AROUND CLEANOUT WITH #3 REBAR AND CHAMFERED EDGES. CLEANOUT TO BE FULL SIZE OF SOIL PIPE UP TO AND INCLUDING 4-INCH ID. REFERENCE PLANS FOR SOIL PIPE SIZE.

					CC	CONNECTION SIZES			
PLAN MARK	DESCRIPTION	MANUFACTURER	MODEL	TRIM	CW (IN)	HW (IN)	W (IN)	V (IN)	NOTES
1	ADA FLOOR MOUNT, FLUSH VALVE, BOTTOM OUTLET, WATER CLOSET	ZURN	Z5665-BWL1	FLUSH VALVE: ZER6000-CPM SENSOR OPERATED BATTERY FLUSH VALVE, OLSONITE 95SSCT OPEN FRONT WHITE SEAT LESS COVER	1.25	-	4	2	COORDINATE SPUD SIZE WITH FLUSH VALVE SUPPLIED. FLUSH CONTROLS SHALL BE LOCATED ON OPEN SIDE OF ACCESSIBLE WATER CLOSETS.
2	FLOOR MOUNT, FLUSH VALVE, BOTTOM OUTLET, WATER CLOSET	ZURN	Z5654-BWL	FLUSH VALVE: ZER6000-CPM SENSOR OPERATED BATTERY FLUSH VALVE, OLSONITE 95SSCT OPEN FRONT WHITE SEAT LESS COVER	1.25	-	4		COORDINATE SPUD SIZE WITH FLUSH VALVE SUPPLIED. FLUSH CONTROLS SHALL BE LOCATED ON OPEN SIDE OF ACCESSIBLE WATER CLOSETS.
3	WALL HUNG BI-LEVEL BARRIER FREE ELECTRIC WATER COOLER	ELKAY	EZSTL8WSLK	BOTTLE FILLER, GRID DRAIN, SAFETY BUBBLER, TRAP, CORD SET	0.5	-	2		FIXTURE IS ADA COMPLIANT. REFER TO ARCHITECTURAL DRAWINGS FOR ACTUAL MOUNTING HEIGHT OF EACH COOLER. CAPACITY OF 8.0 GPH BASED UPON 80 DEGREE F. ROOM TEMPERATURE AND 50 DEGREE F. DRINKING WATER TEMPERATURE.
4	WALL MOUNT, THREE STATION LAVATORY	TRUEFORM	FLO-90V-TPL- CONTEMPO	FAUCET: (3) ZURN Z6950-XL-S BATTERY POWERED SENSOR FAUCETS, CONCEALED ARM CARRIER, PROVIDE ASSE 1070 MIXING VALVES SET TO 105°F IF NOT INTEGRAL TO FAUCETS, GRID DRAINS, TRAPS, SUPPLY STOPS, FLEXIBLE BRAIDED HOT AND COLD WATER LINES, STEEL WALL BRACKETS AND WALL GUARD.	-	-	-		STANDARD COLOR SELECTION BY ARCHITECT. PROVIDE GRID DRAINS, TRAPS, SUPPLIES, ETC. AS REQUIRED FOR EACH OF (3) STATIONS FOR THE MULTI-STATAION LAVATORY BASIN. INSTALLATION SHALL BE ADA COMPLIANT.
5	OVAL UNDERMOUNT LAVATORY	ZURN	Z5220	FAUCET: ZURN Z6950-XL-S BATTERY POWERED SENSOR FAUCET, PROVIDE ASSE 1070 MIXING VALVE SET TO 105°F IF NOT INTEGRAL TO FAUCET, GRID DRAIN, TRAP, SUPPLY STOPS, FLEXIBLE BRAIDED HOT AND COLD WATER LINES.	0.5	0.5	1.5		FAUCET HOLES TO MATCH FAUCET SPECIFIED. PROVIDE INSULATION KIT ON ALL ACCESSIBLE FIXTURES WITH EXPOSED TRAP AND SUPPLIES.
6	FLOOR MOUNT, 24X24X10, JANITOR'S BASIN	FIAT	MSB-2424	FAUCET: FIAT MODEL 830AA, 832-AA HOSE AND HOSE BRACKET, 889-CC MOP HANGER, QDC-35N QUICK DRAIN CONNECTOR, 3" GRID DRAIN. MOLDED STONE BASIN. STAINLESS STEEL WALL GUARDS.	0.5	0.5	3	1.5	MOP BASIN WITH STAINLESS STEEL WALL GUARDS AND CONTINUOUS STAINLESS STEEL CAPS ON ALL CURBS.
WH	FREEZE LESS WALL HYDRANT	WOODFORD	MODEL 67	LOOSE TEE HANDLE, MODEL 50H DOUBLE CHECK BACKFLOW PREVENTER. CHROME EXTERIOR FINISH.	0.75	-	-	-	PROVIDE OPERATING ROD ASSEMBLY PER MANUFACTURER'S RECOMMENDATIONS BASED ON WALL THICKNESS

THIS WORK IS PROTECTED UNDER U.S. COPYRIGHT LAW AND THE ARCHITECTURAL WORKS COPYRIGHT PROTECTION ACT OF 1990. FAILURE TO COMPENSATE PARAGON ARCHITECTURAL WORKS COPYRIGHT INFRINGEMENT. A SERVICE FEE OF 1.5% WILL BE CHARGED PER MONTH ON THE UISE OF THESE DOCUMENTS OF COLLECTION, INCLUDING ATTORNEY'S FEES.


			PIPING				FITT	INGS	MAX. W	VORKING	FIELD	TEST
OVOTEM	0175	TVDE	0011501115	ODD	AOTM	MATERIAL	MATERIAL	TVDE	PRESS.	TEMP.	PRESS.	TINAS
SYSTEM	SIZE	TYPE	SCHEDULE	GRD	ASTM	MATERIAL	MATERIAL	TYPE	(PSI)	(°F)	(PSI)	TIME
DOMESTIC WATER SERVICE	0.75" - 3"	PVC	40	-	D1785	PVC	PVC	SW	125	50-90	200	1 HR
DOMESTIC WATER ABOVE GRADE	ALL	L	-	-	B88	CP	CP	SJ	120	40-180	150	1 HR
FIRE SPRINKLER SERVICE	4" & UP	PVC	-	-	AWWA C900	PVC	DI	MJ	200	50-90	200	2 HR
FIRE PROTECTION	ALL	-	-	-	PER	NFPA	13	-	-	-	200	2 HR
FIRE PROTECTION & STANDPIPE	ALL	-	-	-	PER	NFPA	13	AND	14	-	200	2 HR
TEMPERATURE & PRESSURE RELIEF DRAIN	ALL	М	-	-	B88	CP	CP	DR\S	10 ft	140-210	10 ft	1 HR
WASTE & VENT BELOW GRADE	ALL	DWV	40	-	2665	PVC	PVC	DR\SW	10 ft	50-140	10 ft	1 HR
WASTE & VENT ABOVE GRADE	ALL	NH	SS	-	A74	CI	CI	DR\NH	10 FT	50-180	10 FT	1 HR
CONDENSATE DRAIN ABOVE GRADE	ALL	М	-	-	B88	CP	CP	DR\S	10 FT	40-70	10 FT	1 HR
NATURAL GAS ABOVE GRADE	0.5" - 2.5"	CW	40	Α	A53	CSBLK	MI	THRD	1	-	100	1 HR
NATURAL GAS BELOW GRADE	0.5" - 2"	PE	SDR11	3408	D2513	PE	PE	HF	80	-	100	1 HR

ABBREVIATED	SCHEDULE HEADINGS
EFFICIENCY	MINIMUM EFFICIENCY OF WATER HEATER
GPH	GALLONS PER HOUR
HP	HORSEPOWER
LOAD	NOMINAL CONNECTED GAS LOAD TO UNIT, USED TO SIZE GAS PIPING.
NPSH	NET POSITIVE SECTION HEAD
OUTPUT	MINIMUM REQUIRED OUTPUT TO MEET GPH RISE AS SCHEDULED
RPM	REVOLUTIONS PER MINUTE
PIPE MATERIA	AL SCHDULE
ATP	ARMCO TRUSS PIPE
BLK	BLACK
BS	BELL & SPIGOT
CF	CRIMPED FITTING
CI	CAST IRON
CP	COPPER
CS	CARBON STEEL
CTD	PIPE LINE SERVICE COMPANY X-TRU-COAT HIGH DENSITY POLYETHYLENE COATING EXTRUDED OVER PIPE
CW	CONTINOUS WELD
DI	DUCTILE IRON
DR	DRAINAGE FITTING
GLV	GALVANIZED
HF	HEAT FUSED
LC	LEAD CAULKING
MI	MALLEABLE IRON
MJ	MECHANICAL JOINT
NG	NEOPREME GASKET
NH	NO-HUB
PE	POLYETHYLENE
PVC	POLYVINYL CHLORIDE
S	BRAZED JOINT - SILVER BRAZING ALLOY
SJ	SPOLDER JOINT 95-5 TIN-ANTIMONY
SL	SEAMLESS STEEL
SS	STANDARD STRENGTH - SERVICE WEIGHT
SW	SOLVENT WELD
THRD	THREADED
TS	TY-SEAL
VCP	VITRIFIED CLAY PIPE
WELD	WELDED
XH	EXTRA HEAVY
PUMP SCHED	UIF
AB	ALL BRONZE
AQ	AQUASTAT
BMCCES	BASE MOUNTED CLOSED COUPLED END SUCTION
BMES	BASE MOUNTED END SUCTION
BMHSC	BASE MOUNTED HORIZONTAL SPLIT CASE
BMVSC	BASE MOUNTED VERTICAL SPLIT CASE
C	CONDENSER WATER
CH	CHILLED/HOT WATER
CW	CHILLED WATER
DCW	DOMESTIC COLD WATER
DHW	DOMESTIC COLD WATER DOMESTIC HOT WATER
HW	HEATING HOT WATER
IL T	IN-LINE
Т	TIMER KIT
WATER HEATE	ER SCHEDULE
	T
CNK	CONDENSATE NEUTRALIZATION KIT

ARTS CASSVILLE HS: PERFORMING CENTER PROJECT ENGINEER: JAL DRAWN BY: TSE DRAWN BY: TSE
CHECKED BY: JAL PROJECT NUMBER: 21-620 DATE: 05-17-2023

SHEET NUMBER:

PLUMBING SCHEDULES

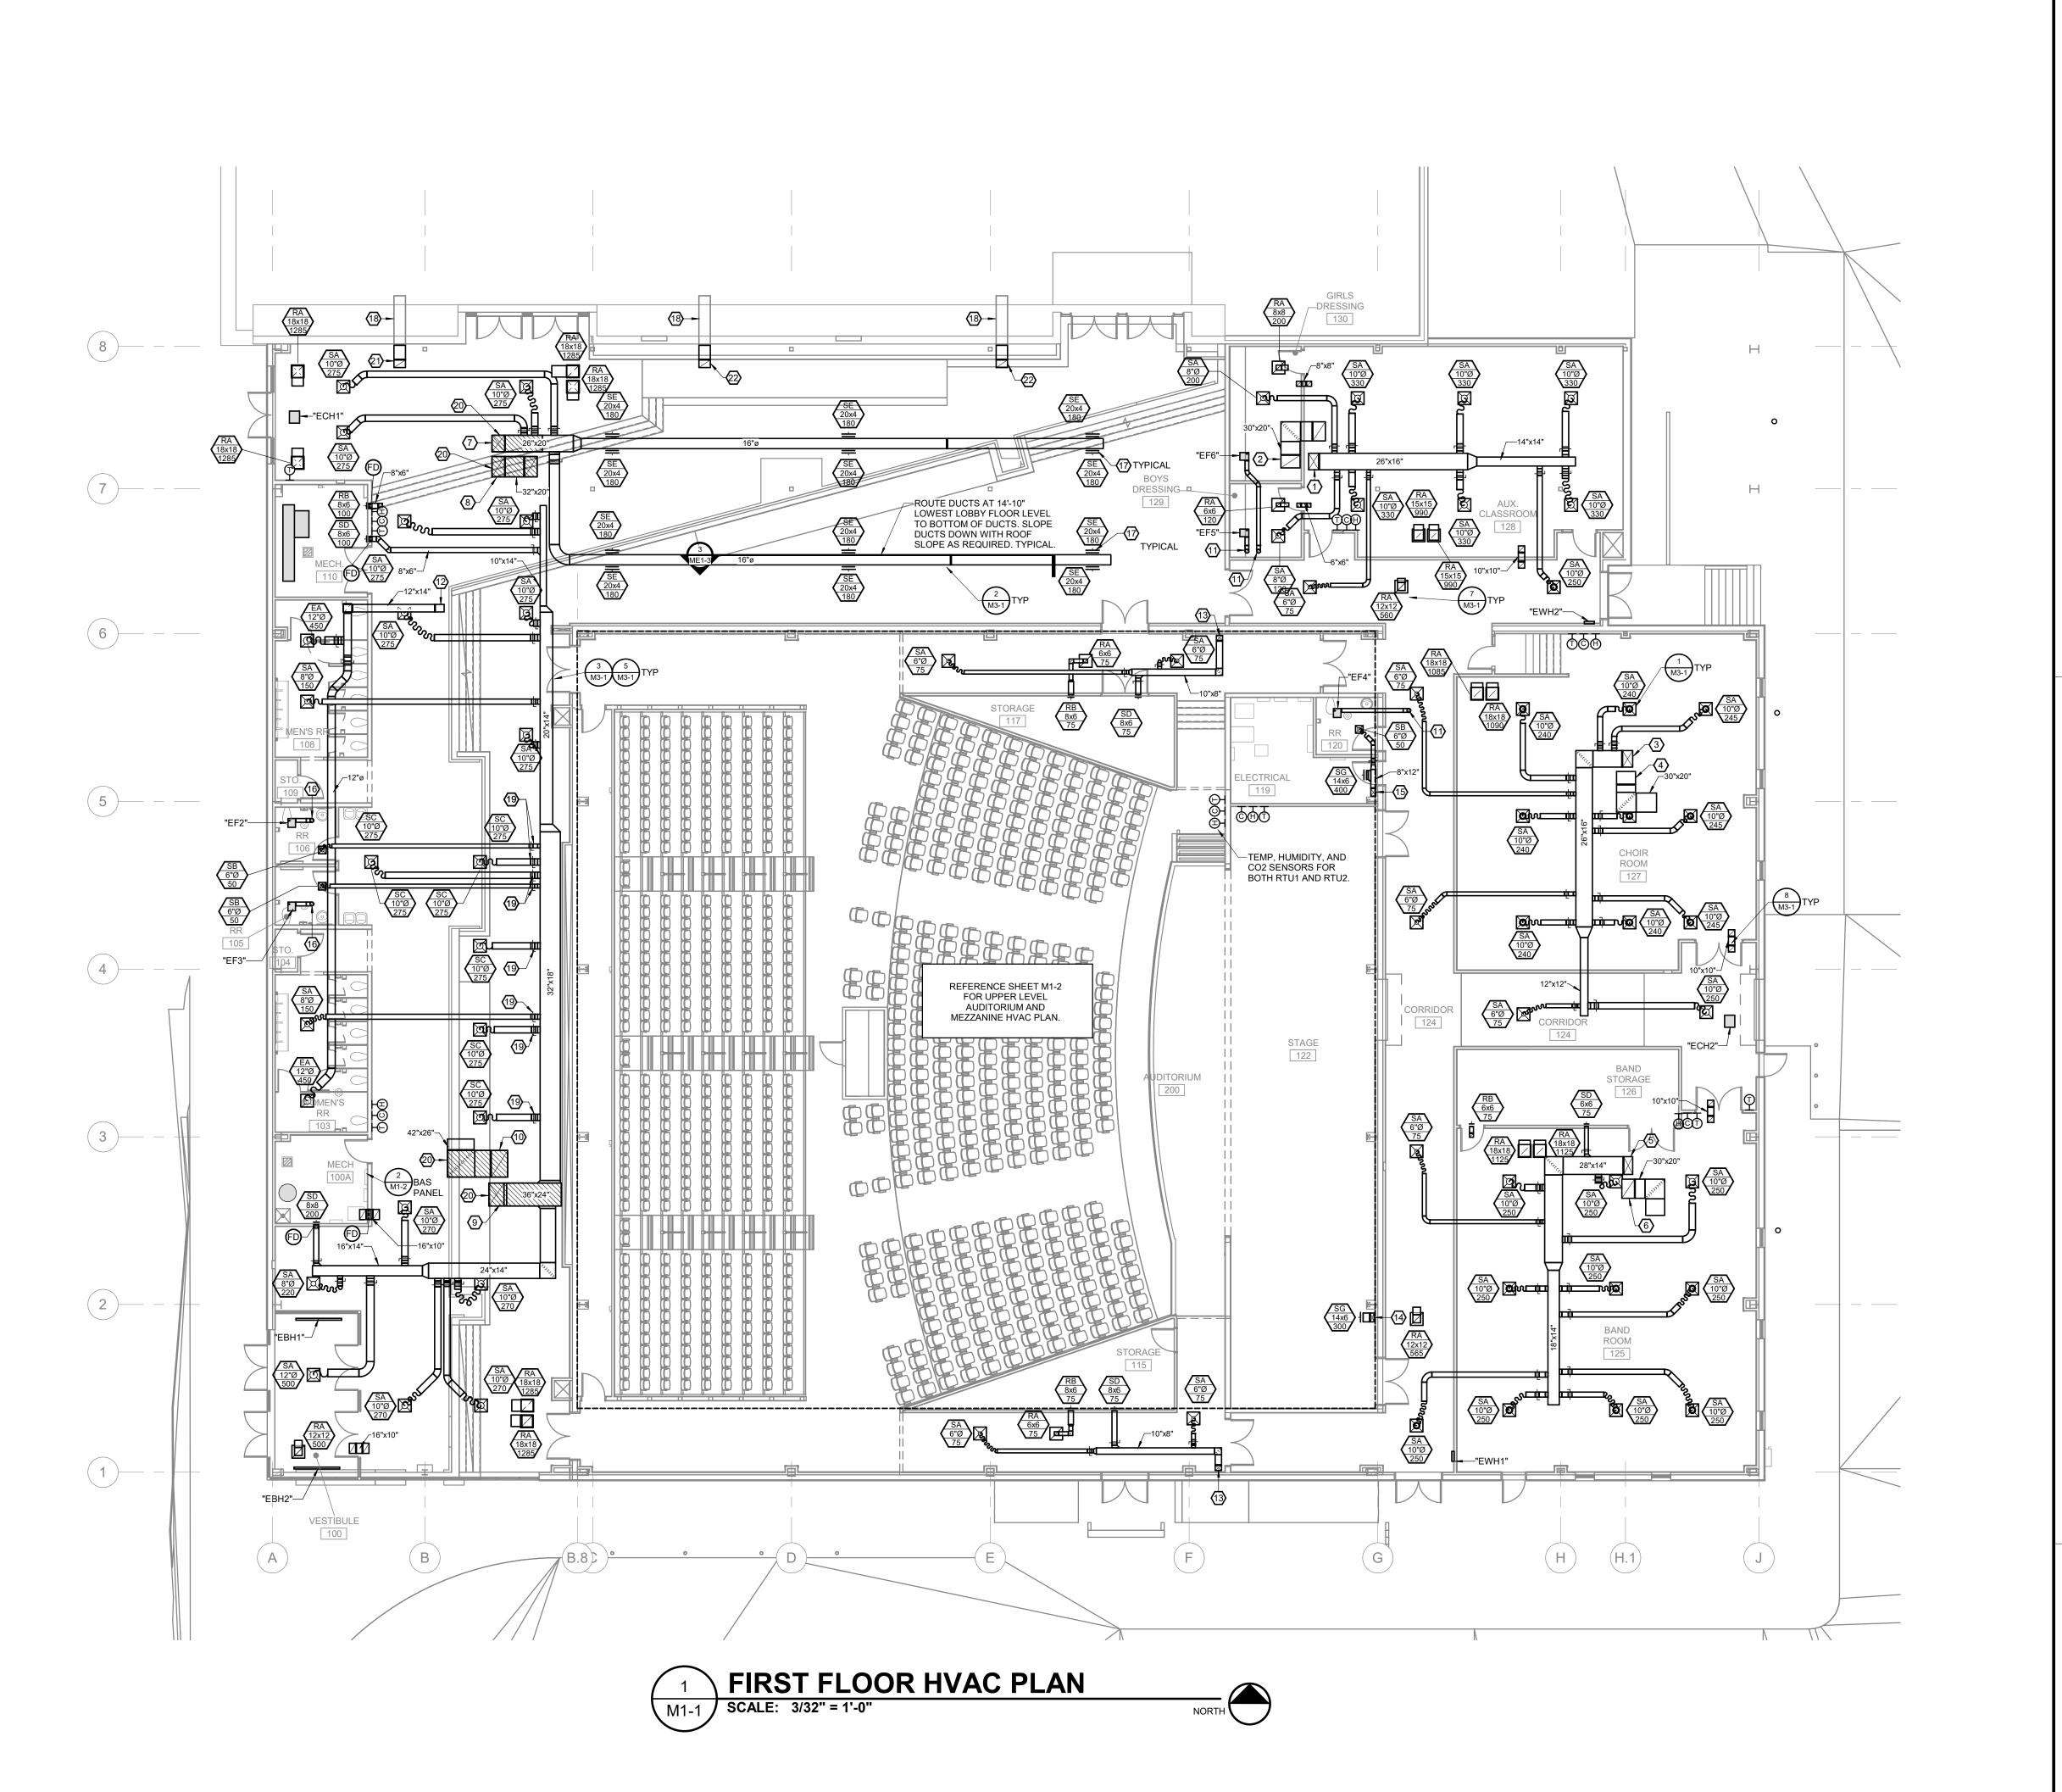

THIS WORK IS PROTECTED UNDER U.S. COPYRIGHT LAW AND THE ARCHITECT CONSTRUCTION ACT OF 1990. FAILURE TO COMPENSATE PARAGON ARCHITECT CONSTRUCTION MINIMUM IF CONTRACT ON FILES DOCUMENTS OF THE COST OF COLLECTION, INCLUDING ATTORNEY'S FEE

GENERAL NOTES:

- ALL MECHANICAL WORK SHALL BE IN ACCORDANCE WITH THE REQUIREMENTS OF THE 2006 INTERNATIONAL MECHANICAL CODE AS ADOPTED BY THE CITY OF CASSVILLE, MO.
- FOR ALL MECHANICAL QUESTIONS ON THIS PROJECT, CONTACT RTM ENGINEERING CONSULTANTS AT (417) 881-0020. CONTACT: TYLER ENSERRO. tyler enserro@ttmec.com
- tyler.enserro@rtmec.com.

 ACCESS PANELS SHALL BE PROVIDED WHEREVER
 NECESSARY TO PROVIDE ACCESS TO VALVES, JUNCTION
 BOXES, ETC., LOCATED IN CONCEALED SPACES. PROVIDE
- ACCESS DOOR FOR ALL FIRE DAMPERS AS REQUIRED FOR SERVICE.
- THE CONTRACTOR SHALL CONTACT THE OWNER AND COORDINATE ALL OUTAGES 5 DAYS PRIOR TO ANY SHUT-OFF OF SERVICES.
- OFF OF SERVICES.

 PROVIDE ALL FIRE RATED MATERIAL FOR PATCH AND REPAIR FOR ALL FIRE RATED ASSEMBLIES. ALL

MANNER. PROVIDE SLEEVE WHERE NEEDED DUE TO

OPENINGS SHALL BE SEALED AND CLOSED IN APPROVED

CONTRACTOR SHALL SCHEDULE AND EXECUTE ALL WORK WITH REGARD TO THE OWNER'S USE OF THE BUILDING.

SCOPE OF WORK.

- PLANS ARE DIAGRAMMATIC AND SHALL NOT BE SCALED.
 REFER TO ARCHITECTURAL DRAWINGS FOR DIMENSIONS
 BRANCH DUCTS SHALL BE THE SAME SIZE AS DIFFUSER
- NECK UNLESS NOTED OTHERWISE.

 PROVIDE TURNING VANES IN ALL RECTANGULAR MITERED
- ALL EQUIPMENT SHALL BE INSTALLED TO ALLOW FULL MAINTENANCE ACCESS PER MANUFACTURER'S RECOMMENDATIONS.
- PROVIDE BALANCE DAMPER ON ALL SUPPLY, EXHAUST, AND OUTSIDE AIR BRANCH DUCTS TO OUTLETS,
- WHETHER INDICATED IN PLANS OR NOT.

 MECHANICAL CONTRACTOR SHALL BE RESPONSIBLE FOR
- TRANSITIONS TO ALL EQUIPMENT OPENING SIZES.

 PAINT ALL EXPOSED PIPING, DUCTWORK, AND SUPPORTS PER ARCHITECT.
- EACH CONTRACTOR AND SUB CONTRACTOR OR TRADE SHALL REVIEW THE BID DOCUMENTS AS A WHOLE INCLUDING ALL OTHER TRADES' DRAWINGS AND PROVIDE ANY MISCELLANEOUS ITEMS, MATERIALS, WORK, ETC. REQUIRED TO COMPLETE THE WORK SHOWN ON ALL BID DOCUMENTS. THIS REQUIREMENT APPLIES TO ALL TRADES. STRUCTURAL, MECHANICAL, ELECTRICAL, PLUMBING, EQUIPMENT VENDORS, ETC. REQUIREMENTS AND RELATED WORK ARE INDICATED THROUGHOUT THE BID DOCUMENTS AND SHALL BE REVIEWED WITH THE SPECIFIC MEP, STRUCTURAL, ARCHITECTURAL, AND EQUIPMENT DRAWINGS FOR OVERALL SCOPE OF WORK.

PLAN HEX NOTES:

- 1 26 X 16 SA UP TO "RTU3" ON ROOF. PROVIDE FLEXIBLE CONNECTION AND DUCT TRANSITIONS TO UNIT CONNECTION SIZE AS REQUIRED.
- 30 X 20 RA UP TO "RTU3" ON ROOF. PROVIDE FLEXIBLE CONNECTION AND DUCT TRANSITIONS TO UNIT CONNECTION SIZE AS REQUIRED.
- 26 X 16 SA UP TO "RTU4" ON ROOF. PROVIDE FLEXIBLE CONNECTION AND DUCT TRANSITIONS TO UNIT CONNECTION SIZE AS REQUIRED.

30 X 20 RA UP TO "RTU4" ON ROOF. PROVIDE FLEXIBLE

- CONNECTION AND DUCT TRANSITIONS TO UNIT CONNECTION SIZE AS REQUIRED.

 5 26 X 16 SA UP TO "RTU5" ON ROOF, PROVIDE FLEXIBLE
- CONNECTION AND DUCT TRANSITIONS TO UNIT CONNECTION SIZE AS REQUIRED.
- 30 X 20 RA UP TO "RTU5" ON ROOF. PROVIDE FLEXIBLE CONNECTION AND DUCT TRANSITIONS TO UNIT CONNECTION SIZE AS REQUIRED.
- 26 X 20 SA UP TO "RTU6" ON ROOF. PROVIDE FLEXIBLE CONNECTION AND DUCT TRANSITIONS TO UNIT CONNECTION SIZE AS REQUIRED.
- 32 X 20 RA UP TO "RTU6" ON ROOF. PROVIDE FLEXIBLE CONNECTION AND DUCT TRANSITIONS TO UNIT CONNECTION SIZE AS REQUIRED.
- 36 X 24 SA UP TO "RTU7" ON ROOF. PROVIDE FLEXIBLE CONNECTION AND DUCT TRANSITIONS TO UNIT CONNECTION SIZE AS REQUIRED.
- SIZE AS REQUIRED.

 10 42 X 26 RA UP TO "RTU7" ON ROOF. PROVIDE FLEXIBLE CONNECTION AND DUCT TRANSITIONS TO UNIT CONNECTION
- 11 6" EXHAUST DUCT UP THRU ROOF TO ROOF JACK.
- 12 14 X 12 EA UP TO "EF1" ON ROOF.
- 13 10 X 8 SA UP TO MEZZANINE LEVEL.

SIZE AS REQUIRED.

- 14 X 6 SA UP TO MEZZANINE LEVEL.
- 15 12 X 8 SA UP TO MEZZANINE LEVEL.16 6" EA UP THRU ROOF TO ROOF JACK.
- 7 INSTALL SUPPLY GRILLE ON ROUND DUCT AT 30 DEGREES DOWN FROM HORIZONTAL.
- EXISTING EXHAUST DUCT INTO EXISTING BUILDING SHALL REMAIN.
 FOR BALANCING DAMPERS THAT ARE INSTALLED ABOVE NON-ACCESSIBLE CEILINGS, PROVIDE DAMPER REGULATORS
- WITH CABLES EXTENDED TO CABLE CONTROLLER INSTALLED ABOVE NEAREST ACCESSIBLE CEILING.

 PROVIDE ACOUSTICAL LAGGING WRAP AROUND PORTION OF DUCT AND FITTINGS SHOWN AS HATCHED. ENOISE CONTROL DL-10-LAG/Q1 OR EQUAL. LAGGING SHALL HAVE STC OF 30, 1"
- R-4, AND VINYL NOISE BARRIER.
- EXTEND EXHAUST DUCT FROM EXISTING BUILDING UP THRU ROOF TO ROOF JACK. MATCH EXISTING SIZE.
- 2 EXTEND EXHAUST DUCT FROM EXISTING BUILDING UP THRU ROOF TO ROOF JACK. MATCH EXISTING SIZE. PAINT EXPOSED DUCTWORK TO MATCH SURROUNDING AREAS.



MISSOURI STATE CERTIFICATE OF AUTHORITY NUMBER A-2016000415
637 COLLEGE STREET
SPRINGFIELD, MO 65806

PH: 417.885.0002 www.paragonarchitecture.com




3333 E. Battlefield Rd | Suite 1000 Springfield, MO 65804 417.881.0020 | www.rtmec.com STATE OF MISSOURI

CERTIFICATE OF AUTHORITY: 2014035826

FOR ENGINEERING

NNIFER A LLICE

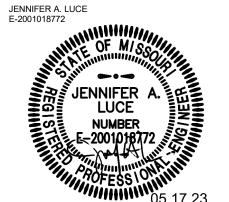

COPYRIGHT 2023 ©
THESE PRINTS ARE THE PROPERTY OF PARAGON
CHITECTURE, LIC AND SHALL BE USED ONLY FOR THE
PROJECT REFERENCE BELOW

REVISION SCHEDULE

IN TILE HS: PERFORMING AF

PROJECT ENGINEER: JAL
DRAWN BY: TSE
CHECKED BY: JAL

PROJECT NUMBER: 21-620


ATF:

05-17-2023

FIRST FLOOR HVAC PLAN

SHEET NUMBER:

M1-1

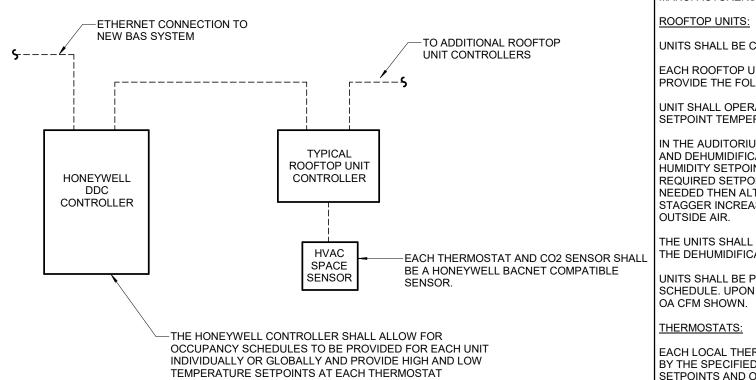

INDIVIDUALLY AND GLOBALLY.

THIS WORK IS PROTECTED UNDER U.S. COPYRIGHT LAW AND THE ARCHITECT U.S. COPYRIGHT INFRINGEMENT. A SERVICE FEE OF 1.5% WILL BE CONSTRUCTION MINIMUM IF CONTRACT ON FILES. OF THESE DOCUMENTS OF COLLECTION, END OF THE COST OF COLLECTION, END OF THE CONTRACT ON FILES. OF THE ARCHITECT CONSTITUTES OF THE USE OF THESE DOCUMENTS OF COLLECTION, END OF THE CONTRACT ON FILES. OF THE CONTRACT

HVAC SYSTEM CONTROL REQUIREMENTS:

GENERAL ITEMS:

CONTRACTOR SHALL PROVIDE ALL REQUIRED CONTROL DEVICES, THERMOSTATS, CO2 SENSORS, RELATIVE HUMIDITY SENSORS, ETC., AND ALL LINE VOLTAGE AND LOW VOLTAGE POWER, TRANSFORMERS, CONDUIT AND BOXES, CONTROL WIRING, RELAYS, CONTACTORS, ETC. AS REQUIRED TO PROVIDE A COMPLETE AND FULLY OPERATIONAL HVAC CONTROL SYSTEM AND AS REQUIRED TO MEET THE SEQUENCE OF OPERATION.

CONTRACTOR SHALL FULLY COORDINATE ALL HVAC CONTROL REQUIREMENTS WITH THE HVAC EQUIPMENT MANUFACTURERS.

UNITS SHALL BE CONTROLLED BY A LOCAL, BACNET COMPATIBLE UNIT CONTROLLER.

EACH ROOFTOP UNIT SHALL BE CONTROLLED BY THE UNIT MANUFACTURER'S UNITARY CONTROLLER TO PROVIDE THE FOLLOWING SEQUENCES OF OPERATION.

UNIT SHALL OPERATE IN AUTO MODE AND STAGE HEATING AND COOLING AS REQUIRED TO MAINTAIN SETPOINT TEMPERATURE. HEATING AND COOLING SHALL NOT OCCUR SIMULTANEOUSLY.

IN THE AUDITORIUM AREA, THE TWO UNITS SHALL ALTERNATE AS THE LEAD UNIT. THE HEATING, COOLING, AND DEHUMIDIFICATION CONTROLS SHALL FUNCTION AS REQUIRED TO MAINTAIN THE TEMPERATURE AND HUMIDITY SETPOINTS. THE SECOND UNIT SHALL ACTIVATE IF THE LEAD UNIT CANNOT MAINTAIN THE REQUIRED SETPOINTS. UNITS SHALL BOTH ENGAGE IF MORE THAN ONE STAGE OF HEATING/COOLING IS NEEDED THEN ALTERNATE ADDING ADDITIONAL STAGES. INTERLOCK OPERATION FOR BOTH UNITS. STAGGER INCREASING OUTSIDE AIR WITH UNIT. ENGAGE UNITIT WITH HOT GAS REHEAT FIRST TO INCREASE


THE UNITS SHALL OPERATE TO MAINTAIN 50% RH IN THE SPACE. IF THE RH IN THE SPACE RISES ABOVE 55%, THE DEHUMIDIFICATION SEQUENCE SHALL ENGAGE.

UNITS SHALL BE PROGRAMMED FOR DEMAND CONTROL VENTILATION. SET OA CFM TO MINIMUM SHOWN ON SCHEDULE. UPON CO2 LEVELS RISING ABOVE 1100PPM, THE OA DAMPER SHALL OPEN TO ALLOW THE MAX

THERMOSTATS:

EACH LOCAL THERMOSTAT SHALL BE SCHEDULED AND WITH SETPOINT LIMITATIONS, CONTROLLED LOCALLY BY THE SPECIFIED BAS SYSTEM VIA BACNET CONNECTION TO ALLOW GLOBAL AND INDIVIDUAL CONTROL OF SETPOINTS AND OCCUPANCY SCHEDULES. OCCUPANCY SCHEDULES SHALL BE PROGRAMMABLE TO NO LESS THAN 365 DAYS. ALL THERMOSTATS SHALL BE EQUIPPED WITH AN OVERRIDE FEATURE TO ALLOW FOR LOCAL OVERRIDE OF THE OCCUPANCY SCHEDULE AND BMS SETPOINTS FOR UP TO 4 HOURS.

REFERENCE ELECTRICAL PLANS FOR EXHAUST FAN CONTROLS.

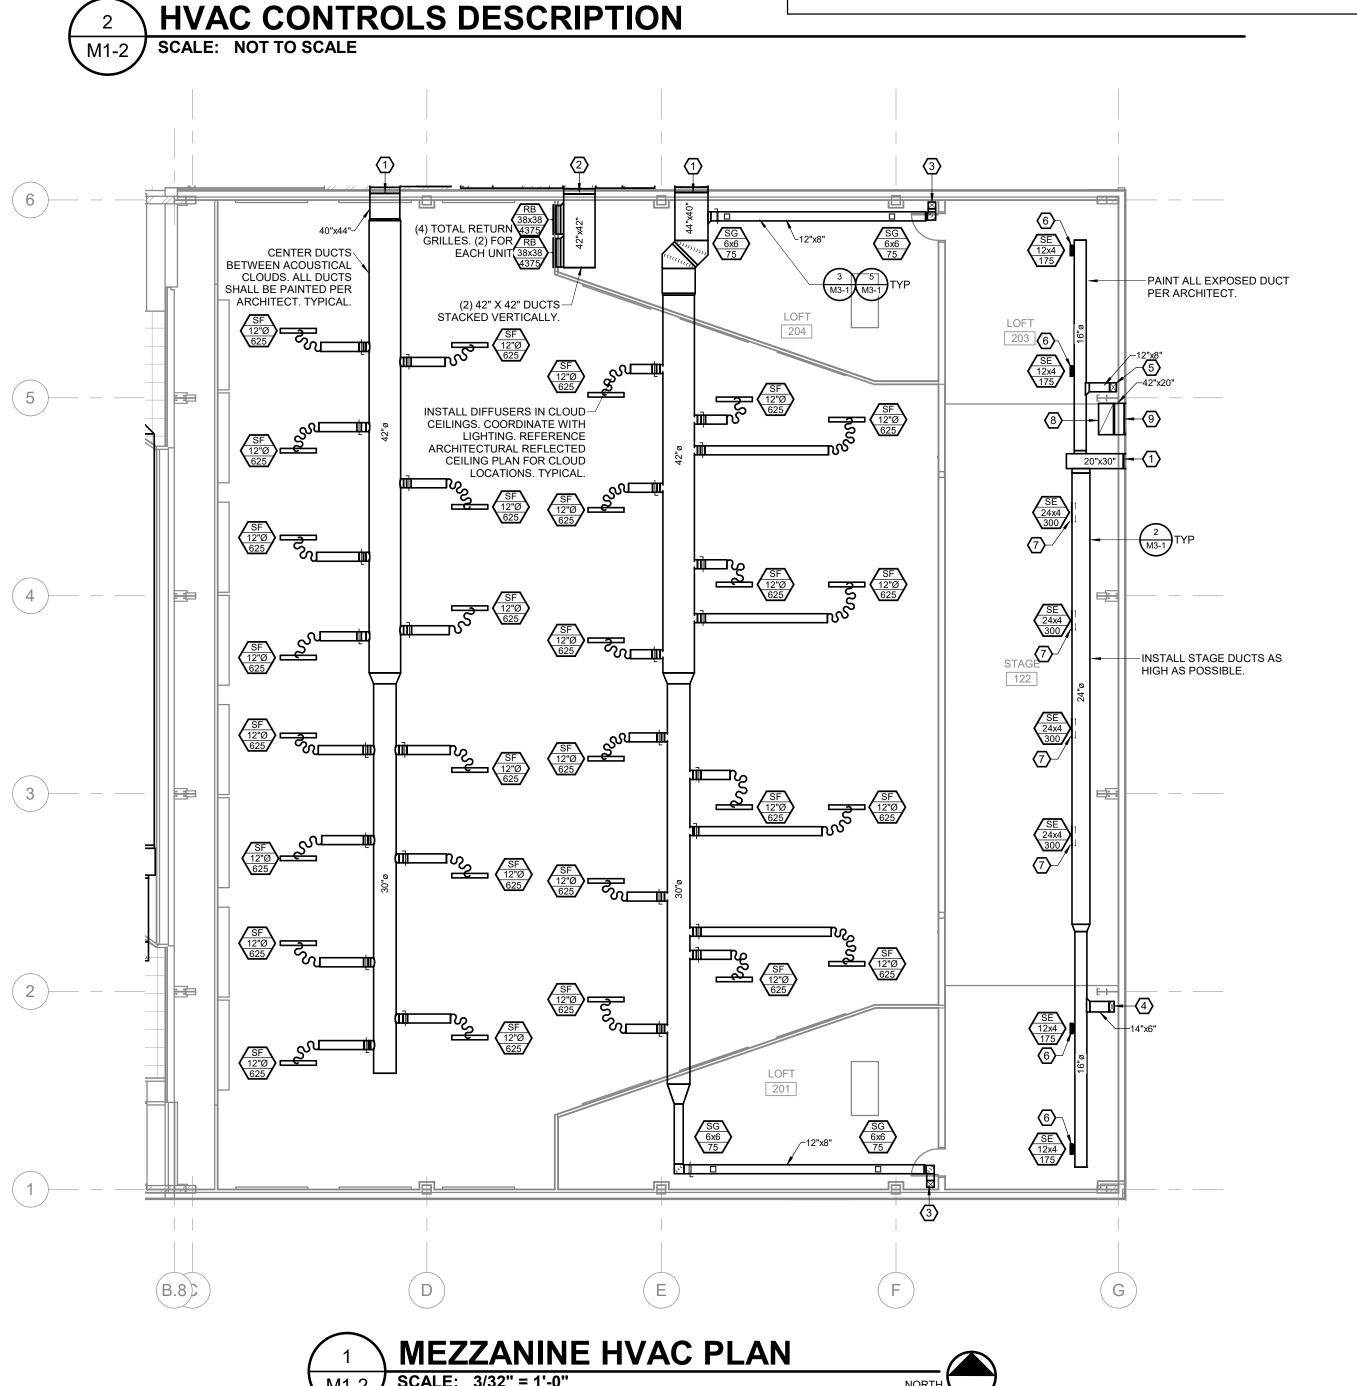

PLAN HEX NOTES:

- SUPPLY AIR DUCT THRU WALL TO HORIZONTAL DISCHARGE ROOFTOP UNIT. SEE MEP ROOF PLAN FOR CONTINUATION.
- RETURN AIR DUCTS STACKED VERTICALLY THRU WALL TO HORIZONTAL DISCHARGE ROOFTOP UNIT. SEE MEP ROOF PLAN FOR CONTINUATION.
- 10 X 8 SA DOWN TO FIRST FLOOR.
- 14 X 6 SA DOWN TO FIRST FLOOR
- 12 X 8 SA DOWN TO FIRST FLOOR.

DOWN FROM HORIZONTAL.

OVER DUCT OPENING.

- INSTALL SUPPLY GRILLE ON ROUND DUCT AT 30 DEGREES
- INSTALL SUPPLY GRILLE ON ROUND DUCT AT 75 DEGREES
- DOWN FROM HORIZONTAL. TURN RETURN AIR DUCT UP AND PROVIDE WIRE MESH SCREEN
- RETURN AIR DUCT THRU WALL TO HORIZONTAL DISCHARGE ROOFTOP UNIT. SEE MEP ROOF PLAN FOR CONTINUATION.






3333 E. Battlefield Rd | Suite 1000 Springfield, MO 65804 417.881.0020 | www.rtmec.com STATE OF MISSOURI CERTIFICATE OF AUTHORITY:

2014035826

FOR ENGINEERING

JENNIFER A. LUCE E-2001018772

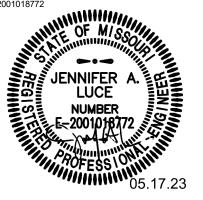

THESE PRINTS ARE THE PROPERTY OF PARAGON ARCHITECTURE, LLC AND SHALL BE USED ONLY FOR THE PROJECT REFERENCE BELOW

REVISION SCHEDULE

PERFORMING HS

PROJECT ENGINEER: JAL


PROJECT NUMBER: 21-620

05-17-2023

MEZZANINE HVAC PLAN

SHEET NUMBER:

M1-2

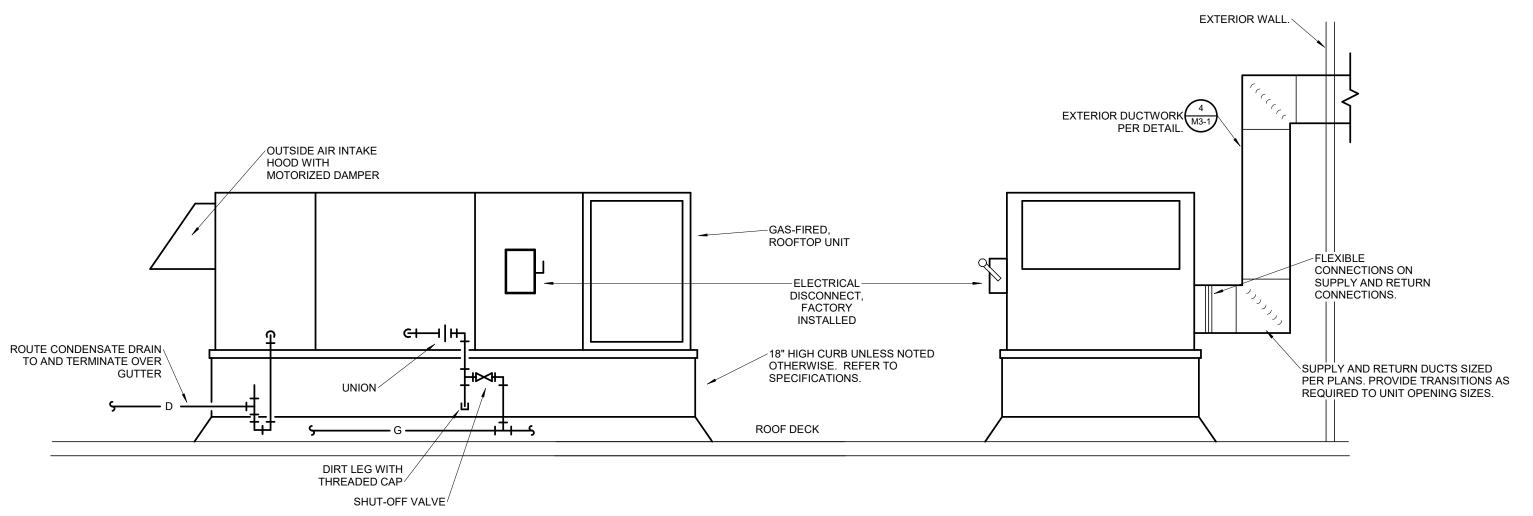


IF APPLICABLE, A FIELD INSTALLED DISCONNECT SHALL BE MOUNTED SO THAT IT DOES NOT VOID ANY WARRANTIES ON THE UNIT SERVED.

HORIZONTAL DISCHARGE ROOFTOP UNIT DETAIL

-EXHAUST FAN BACKDRAFT DAMPER AS REQ'D REF. FAN SCHEDULES BIRD SCREEN COUNTER FLASHING * PRE.FAB. INSULATED ROOF CURB FINISHED ROOF * -RIGID INSULATION * 45° DUCT FITTING ROOF DECK * FLEXIBLE CONNECTION -DUCT AS REQ'D REF. MECH. PLANS FOR SIZE BRANCH/ EXHAUST REFER TO ARCHITECTURAL FOR ROOFING DETAILS.

EXHAUST FAN DETAIL

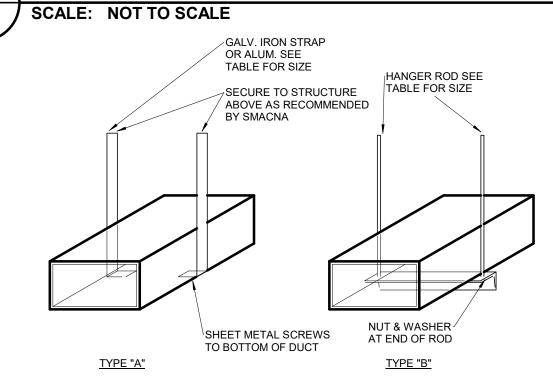

		DUCT I	HANGER SCH	EDULE	
DUCT SIZE (INCH)	TYPE OF HANGER	HANGER SPACING (FT)	STRAP SIZE	ROD SIZE (INCH)	ANGLE FOR BRACING
UP TO 12 13 TO 18 19 TO 30 31 TO 42 43 TO 54 55 TO 60 61 TO 84 85 TO 96 OVER 96	A A A/B B B B B	8'-0" 8'-0" 8'-0" 8'-0" 8'-0" 8'-0" 8'-0"	1"x16GA 1"x16GA 1"x16GA N.A. N.A. N.A. N.A. N.A. N.A.	N.A. N.A. 1/4" 1/4" 1/4" 1/4" 1/4" 1/4" 3/8"	N.A. N.A. 1-1/2"x1-1/2"x1/8" 1-1/2"x1-1/2"x1/8" 1-1/2"x1-1/2"x1/8" 1-1/2"x1-1/2"x1/8" 1-1/2"x1-1/2"x3/16" 1-1/2"x1-1/2"x3/16" 2"x2"x1/4"

1. FOR SEVERAL DUCTS ON ONE HANGER, TYPE "B" MAY BE USED. SIZE OF HANGER WILL BE

DUCT INSULATION

CONSTRUCTION.


NOTE:
ALL EXTERIOR SEAMS SHALL BE
SEALED WITH DUCTMATE WATERPROOF JOINTS

EXTERIOR ALUMINUM WRAP. REFERENCE

SPECIFICATIONS FOR ALTERNATE APPROVED

SELECTED ON THE SUM OF DUCT WIDTHS EQUAL TO MAX WIDTH OF DUCT SCHEDULE. 2. ON TYPE "A" HANGER, PROVIDE 3 HANGERS AT EACH TAKE-OFF OR BRANCH.


DUCT SUPPORT DETAIL

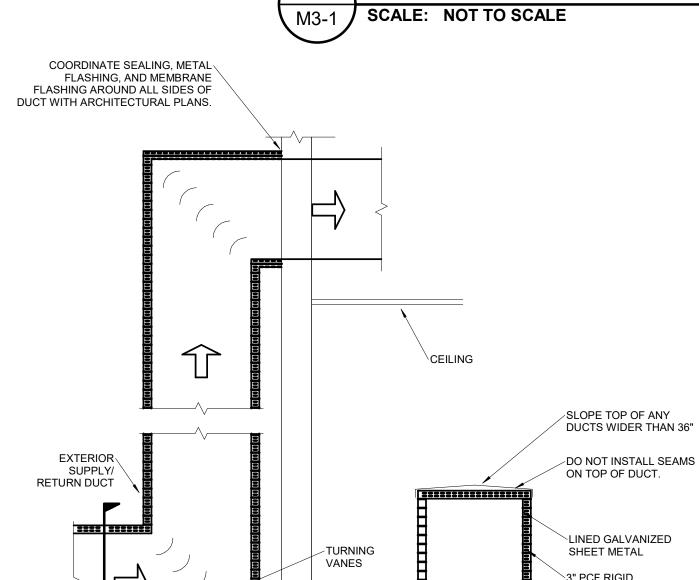


EXTERIOR SUPPLY AND RETURN AIR DUCT DETAIL SCALE: NOT TO SCALE


DUCT SIZED

PER PLAN

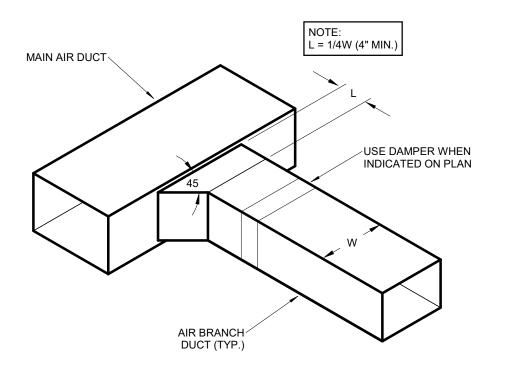


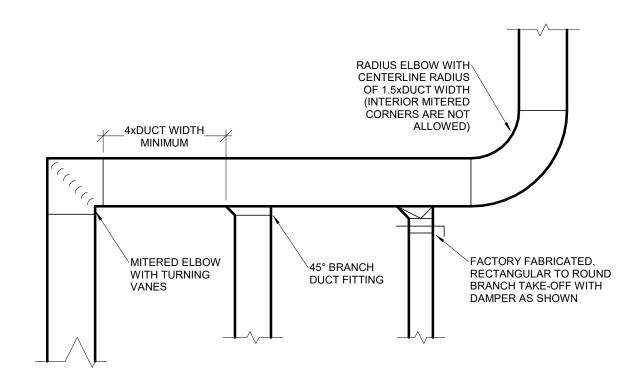

DUCTWORK CONSTRUCTION DETAIL SCALE: NOT TO SCALE

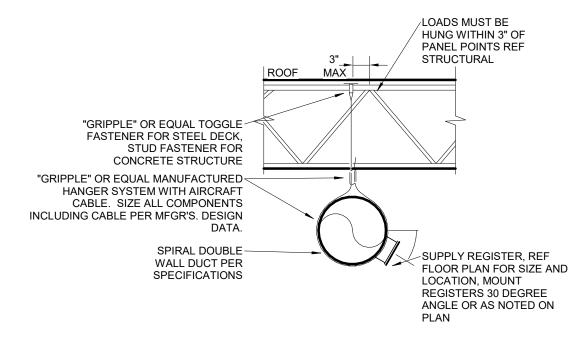

ROUND DUCT SUPPORT AND GRILLE SCALE: NOT TO SCALE

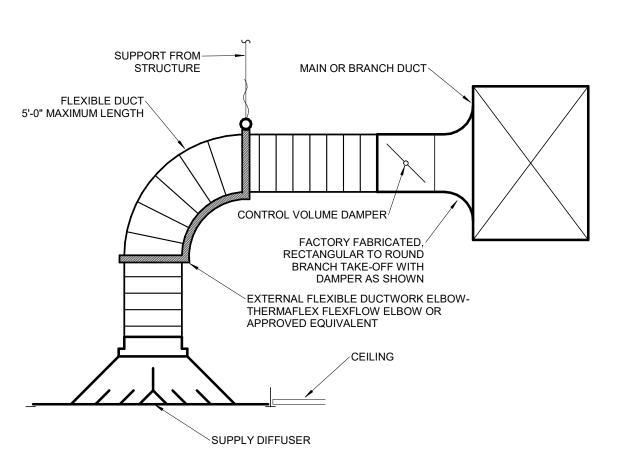

CEILING DIFFUSER DETAIL SCALE: NOT TO SCALE



PH: 417.885.0002 www.paragonarchitecture.com

3333 E. Battlefield Rd | Suite 1000 Springfield, MO 65804 417.881.0020 | www.rtmec.com STATE OF MISSOURI

CERTIFICATE OF AUTHORITY

2014035826

FOR ENGINEERING

JENNIFER A. LUCE E-2001018772

HESE PRINTS ARE THE PROPERTY OF PARAGON ITECTURE, LLC AND SHALL BE USED ONLY FOR THE PROJECT REFERENCE BELOW

REVISION SCHEDULE

ARTS **PERFORMING** S

PROJECT ENGINEER: JAL DRAWN BY: CHECKED BY:


PROJECT NUMBER: 21-620

DATE: 05-17-2023

MECHANICAL DETAILS

SHEET NUMBER:

M3-1

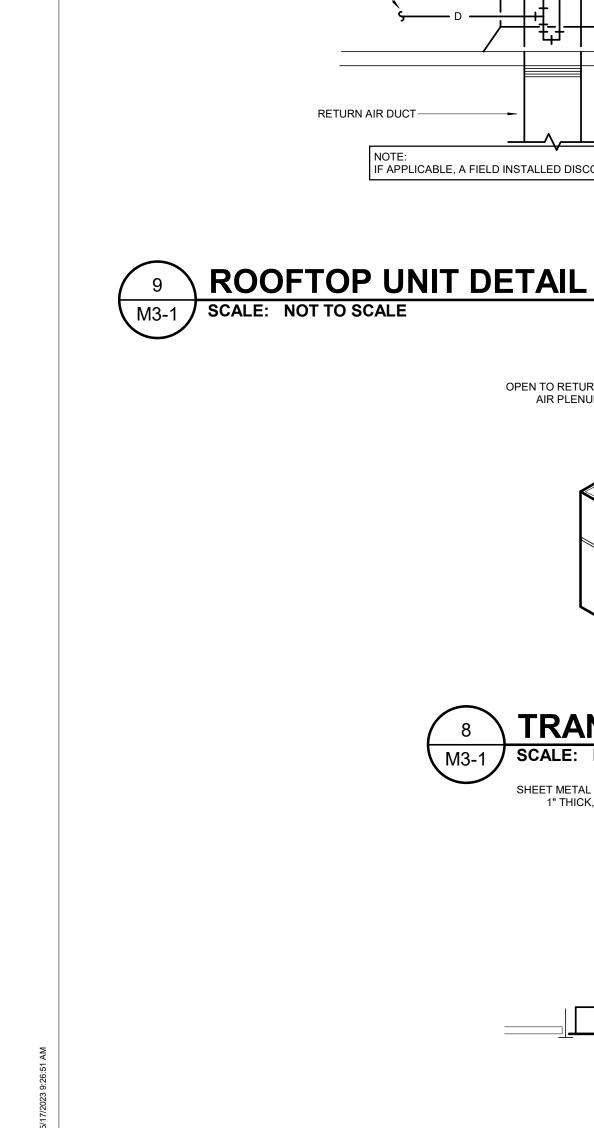

/LINED TRANSFER OPEN TO RETURN AIR BOOT

DIRT LEG WITH / THREADED CAP

SHUT-OFF VALVE

IF APPLICABLE, A FIELD INSTALLED DISCONNECT SHALL BE MOUNTED SO THAT IT DOES NOT VOID ANY WARRANTIES ON THE UNIT SERVED.

SIDE VIEW

M3-1 SCALE: NOT TO SCALE

OUTSIDE AIR INTAKE-

MOTORIZED DAMPER

ROUTE CONDENSATE DRAIN TO AND TERMINATE OVER

HOOD WITH

RETURN AIR DUCT-

TRANSFER AIR DUCT DETAIL SCALE: NOT TO SCALE SHEET METAL BOOT LINED WITH 1" THICK, 2 LB. DUCT LINER SIZED FOR 400 FPM RETURN GRILLE

DIMENSION "X"

RETURN AIR BOOT DETAIL SCALE: NOT TO SCALE

END VIEW

-GAS-FIRED,

-ELECTRICAL

INSTALLED

ROOF DECK

—FLEXIBLE CONNECTION (TYP)


-SUPPLY AIR DUCT

DISCONNECT, FACTORY

18" HIGH CURB UNLESS NOTED OTHERWISE. REFER TO **SPECIFICATIONS**

ROOFTOP UNIT

THIS WORK IS PROTECTED UNDER U.S. COPYRIGHT LAW AND THE ARCHITECT CONSTITUTES A COPYRIGHT INFRINGEMENT. A SERVICE FEE OF 1.5% WILL BE CHARGED PER MONTH ON THE USE OF THESE DOCUMENTS FOR ANY PURPOSE, BY ANYONE. USE OF THESE DOCUMENTS FOR ANY PURPOSE, BY ANYONE. USE OF THESE DOCUMENTS AFTER FAILURE TO COMPENSATE THE ARCHITECT CONSTITUTES A SERVICE FEE OF 1.5% WILL BE CHARGED PER MONTH ON THE USE OF THESE DOCUMENTS FOR ANY PURPOSE, BY ANYONE. USE OF THESE DOCUMENTS FOR ANY PURPOSE, BY ANYONE. USE OF THESE DOCUMENTS FOR ANY PURPOSE, BY ANYONE. USE OF THESE DOCUMENTS AND THE USE OF THESE DOCUMENTS FOR ANY PURPOSE, BY ANYONE. USE OF THESE DOCUMENTS FOR ANY PURPOSE, BY ANYONE. USE OF THESE DOCUMENTS FOR ANY PURPOSE, BY ANYONE. USE OF THESE DOCUMENTS FOR ANY PURPOSE, BY ANYONE. USE OF THESE DOCUMENTS FOR ANY PURPOSE, BY ANYONE. USE OF THESE DOCUMENTS FOR ANY PURPOSE, BY ANYONE. USE OF THESE DOCUMENTS FOR ANY PURPOSE, BY ANYONE. USE OF THESE DOCUMENTS FOR ANY PURPOSE, BY ANYONE. USE OF THESE DOCUMENTS FOR ANY PURPOSE, BY ANYONE. USE OF THESE DOCUMENTS FOR ANY PURPOSE, BY ANYONE. USE OF THESE DOCUMENTS FOR ANY PURPOSE, BY ANYONE. USE OF THESE DOCUMENTS FOR ANY PURPOSE, BY ANYONE. USE OF THESE DOCUMENTS FOR ANY PURPOSE, BY ANYONE. USE OF THESE DOCUMENTS FOR ANY PURPOSE, BY ANYONE. USE OF THESE DOCUMENTS FOR ANY PURPOSE, BY ANYONE. USE OF THESE DOCUMENTS FOR ANY PURPOSE, BY ANYONE. USE OF THESE DOCUMENTS FOR ANY PURPOSE, BY ANYONE. USE OF THESE DOCUMENTS FOR ANY PURPOSE, BY ANYONE. USE OF THESE DOCUMENTS FOR ANY PURPOSE, BY ANYONE. USE OF THESE DOCUMENTS FOR ANY PURPOSE, BY ANY PURPO

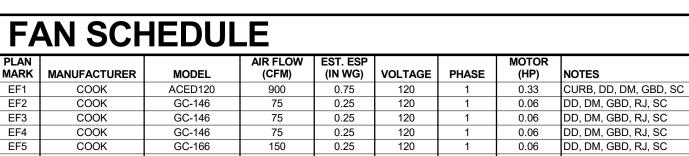


ELECTRIC WALL HEATER SCHEDULE SUPPLY HEATING ELECTRICAL DATA AIR FLOW (CFM) (WATTS) VOLTAGE PHASE FLA MCA (A) PLAN MARK MANUFACTURER MODEL NOTES 3,000 BERKO FRA4024F 208

El	ECTR	IC CEI	LIN	G HE	EATI	ER	SC	HE	EDI	JLE
			SUPPLY	HEATING		ELECT	RICAL DA	ATA		
PLAN			AIR FLOW	ELEMENT					MOCP	
MARK	MANUFACTURER	MODEL	(CFM)	(WATTS)	VOLTAGE	PHASE	FLA	MCA	(A)	NOTES
ECH1	BERKO	OFF4004	100	3,000	208	1	14	18	20	CMF, DS, T
ECH2	BERKO	OFF4004	100	3,000	208	1	14	18	20	CMF, DS, T

	ACKAG)ED	ROC	<u> </u>		JNI		JH		JLE NG CAPAC				GAS HEATI	NG			ELECT	RICAL D	ΔΤΔ		T
PLAN MARK	MANUFACTURER	MODEL	SUPPLY AIR FLOW (CFM)	EST. ESP (IN WG)		MIN (CFM)	E.A.T. DB (°F)	E.A.T. WB (°F)	MIN. SCC (MBH)	-		AMBIENT TEMPERATURE (°F)	GAS LOAD (BTU/H)		EFFICIENCY (%)	VOLTAGE			MCA	MOCP (A)	MIN. SCCR (A)	NOTES
RTU1	TRANE	SFHMF304	8,750	1	2,400	485	80	65	210	339	18.4	105	500,000	405,000	81	480	3	65	71	90	5000	BRD,CC, CCH, CO2, CR, CURB, DS, ECON, F, H, LC, MH, MHGR, PE, R410A, RMMC, ST, VIC, VSC
TU2	TRANE	YCH330	8,750	1	2,200	250	80	65	229	321	11.4	105	600,000	486,000	81	480	3	70	74	90	5000	BRD, CC, CCH, CR, CO2, CURB, DS, ECON, F, H, LC, MH, PE, R410A, RMMC, SD, T, V
U3	TRANE	YHJ102	2,625	1	575	200	80	65	69	95	12.1	105	200,000	162,000	81	480	3	22	28	35	5000	2SH, BRD, CC, CCH, CR, CO2, CURB, DS, ECON, F, H, LC, MHGR, PE, R410A, SD, T
U4	TRANE	YHJ102	2,625	1	615	270	80	65	73	95	12.1	105	200,000	162,000	81	480	3	22	28	35	5000	2SH, BRD, CC, CCH, CR, CO2, CURB, DS, ECON, F, H, LC, MHGR, PE, R410A, SD, T
U5	TRANE	YHJ102	2,625	1	635	290	80	65	73	95	12.1	105	200,000	162,000	81	480	3	22	28	35	5000	2SH, BRD, CC, CCH, CR, CO2, CURB, DS, ECON, F, H, LC, MHGR, PE, R410A, SD, T
U6	TRANE	YHJ102	2,625	1	490	140	80	65	73	95	12.1	105	200,000	162,000	81	480	3	22	28	35	5000	2SH, BRD, CC, CCH, CR, CO2, CURB, DS, ECON, F, H, LC, MHGR, PE, R410A, SD, T
U7	TRANE	YHJ180	5,250	1	845	180	80	65	141	173	11.9	105	400,000	324,000	81	480	3	31	45	50	5000	2SH, BRD, CC, CCH, CR, CO2, CURB, DS, ECON, F, H, LC, MHGR, PE, R410A, SD, T
TU8	TRANE	YHJ120	3,000	1	830	480	80	65	85	111	11.4	105	240,000	194,000	81	480	3	25	32	40	5000	2SH, BRD, CC, CCH, CR, CO2, CURB, DS, ECON, F, H, LC, MHGR, PE, R410A, SD, T

THIS WORK IS PROTECTED UNDER U.S. COPYRIGHT LAW AND THE ARCHITECT WARKS COPYRIGHT LAW AND THE ARCHITECT CONSTRUCTION ACT OF 1990. FAILURE TO COMPENSATE PARAGON ARCHITECT CONSTRUCTION MINIMUM IF CONTRACT ON FILE), OR 5% OF THESE DOCUMENTS FOR ANY PURPOSE, BY ANYONE. USE OF THESE DOCUMENTS FOR ANY PURPOSE, BY ANYONE. USE OF THESE DOCUMENTS FOR ANY PURPOSE, BY ANYONE. USE OF THESE DOCUMENTS FOR ANY PURPOSE, BY ANYONE. USE OF THESE DOCUMENTS FOR ANY PURPOSE, BY ANYONE. USE OF THESE DOCUMENTS FOR ANY PURPOSE, BY ANYONE. USE OF THESE DOCUMENTS FOR ANY PURPOSE, BY ANYONE. USE OF THESE DOCUMENTS FOR ANY PURPOSE, BY ANYONE. USE OF THESE DOCUMENTS FOR ANY PURPOSE, BY ANYONE. USE OF THESE DOCUMENTS AND THE CONSTRUCTION FINE CONSTRUCTION FOR ANY PURPOSE, BY ANYONE. USE OF THESE DOCUMENTS FOR ANY PURPOSE, BY ANYONE. USE OF THESE DOCUMENTS FOR ANY PURPOSE, BY ANYONE. USE OF THESE DOCUMENTS AND THE CONSTRUCTION FOR ANY PURPOSE, BY ANYONE. USE OF THESE DOCUMENTS AND THE CONSTRUCTION FOR ANY PURPOSE, BY ANYONE. USE OF THESE DOCUMENTS AND THE CONSTRUCTION FOR ANY PURPOSE, BY ANYONE. USE OF THESE DOCUMENTS AND THE CONSTRUCTION FOR ANY PURPOSE, BY ANYONE. USE OF THESE DOCUMENTS AND THE CONSTRUCTION FOR ANY PURPOSE, BY ANYONE. USE OF THESE DOCUMENTS AND THE CONSTRUCTION FOR ANY PURPOSE, BY ANYONE. USE OF THESE DOCUMENTS AND THE CONSTRUCTION FOR ANY PURPOSE, BY ANYONE. USE OF THE CONSTRUCTION FOR ANY PURPOSE AND THE

GR	ILLE, F	REGIS	STER	AND) DIF	FUS	SER	SCH	EDUI	LE	
PLAN MARK	MANUFACTURER	MODEL	APPLICATION	FINISH	FRAME TYPE	VOLUME DAMPER	MAXIMUM NC	MINIMUM THROW (FT)	MAXIMUM THROW (FT)	MAXIMUM ΔP (IN WG)	NOTES
EA	TITUS	PAR-24 x 24	EXHAUST	BY ARCH	GRID	No	30	0	0	0.10	24x24 SQUARE PERFORATED FACE WITH ROUND DUCT CONNECTION
RA	TITUS	PAR-24 x 24	RETURN	BY ARCH	GRID	No	30	0	0	0.10	24X24 SQUARE PERFORATED FACE WITH SQUARE DUCT CONNECTION
RB	TITUS	350-RL	RETURN	BY ARCH	SURFACE	No	30	0	0	0.10	WALL GRILLE - DOUBLE DEFLECTION - ALUMINUM
SA	TITUS	TDCA-24 x 24	SUPPLY	BY ARCH	GRID	Yes	30	7	17	0.10	24x24 SQUARE LOUVER FACE WITH ROUND DUCT CONNECTION
SB	TITUS	TDCA-12 x 12	SUPPLY	BY ARCH	SURFACE	Yes	30	7	17	0.10	12x12 SQUARE LOUVER FACE WITH ROUND DUCT CONNECTION
SC	TITUS	TDCA-24 x 24	SUPPLY	BY ARCH	GYP	Yes	30	7	17	0.10	24x24 SQUARE LOUVER FACE WITH ROUND DUCT CONNECTION
SD	TITUS	300-FL	SUPPLY	BY ARCH	SURFACE	No	30	7	17	0.10	WALL GRILLE - DOUBLE DEFLECTION - ALUMINUM
SE	TITUS	S300-FL	SUPPLY	BY ARCH	DUCT	No	30	7	17	0.10	DUCT GRILLE - DOUBLE DEFLECTION - ALUMINUM
SF	TITUS	FL-10-2CRB-F BPI	SUPPLY	BY ARCH	GYP	No	25	12	30	0.10	48" CONTINUOUS FLOWBAR LINEAR SLOT DIFFUSER W/ (2) 1" SLOTS SET TO JET FLOW (0 DEGREE DEFLECTION) & INSULATED PLENUM BOX
SG	TITUS	300-FL	SUPPLY	BY ARCH	DUCT	No	30	7	17	0.10	DUCT GRILLE - DOUBLE DEFLECTION - ALUMINUM

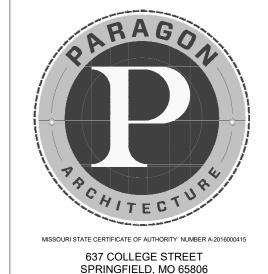

PH: 417.885.0002 www.paragonarchitecture.com



SCHEDULE LEGEND

E.S.P. EXTERNAL STATIC PRESSURE INCLUDES ALL WORK

ENTERING WATER TEMPERATURE

GPH GALLONS PER HOUR

GPM GALLONS PER MINUTE

GR/LB GRAINS OF MOISTURE PER POUND OF DRY AIR

HP HORSEPOWER

IN INCH

ISP INLET STATIC PRESSURE

LBS POUNDS

LOAD NOMINAL CONNECTED GAS LOAD TO UNIT, USED TO SIZE

OUTPUT MINIMUM REQUIRED OUTPUT TO SATIFY SCHEDULED

LEAVING AIR TEMPERATURE L.W.T. LEAVING WATER TEMPERATURE

MINIMUM CIRCUIT AMPACITY

MOCP MAXIMUM OVERCURRENT PROTECTION MAXIMUM NOISE CRITERIA RATING NET PRESSURE SUCTION HEAD

HEATING REQUIREMENTS

SEER SEASONAL ENERGY EFFICIENCY RATIO
SHC SENSIBLE HEAT CAPACITY
TCC TOTAL COOLING CAPACITY

DS ELECTRICAL DISCONNECTING MEANS
T INTEGRAL THERMOSTAT

ELECTRICAL DISCONNECTING MEANS WALL THERMOSTAT THERMOSTAT

ELECTRICAL DISCONNECT SWITCH

PARTS EXPOSED TO AIR STREAM

GRAVITY BACKDRAFT DAMPER

2SH 2-STAGE BURNER FOR HEAT EXCHANGER

FIELD PAINTED CUSTOM COLOR

BAROMETRIC RELIEF DAMPER WITH HOOD

WITH OVERRIDE AS NOTED ON THE PLANS.

MANUFACTURER MOUNTED GFCI CONVENIENCE

HEIGHT) WITH (2) LAYERS OF 0.5" GYP BOARD.

WITH OVERRIDE AS NOTED ON THE PLANS.

HOT GAS REHEAT DEHUMIDIFICATION CYCLE LOW AMBIENT COOLING CONTROLS CAPABLE OF OPERATING IN COOLING MODE DOWN TO 0°F LOW AMBIENT COOLING CONTROLS CAPABLE OF OPERATING IN COOLING MODE DOWN TO 32°F

MODULATING NATURAL GAS HEATING

SINGLE POINT MEANS OF DISCONNECT

INDUSTRIAL STRENGTH EPOXY POWDER COAT FOR ALL

SPACE MOUNTED CO2 SENSOR FOR DDC OPEREATION

ACOUSTICAL INSULATED FULL ROOF CURB (MINIMUM 18"

0-100% MODULATING OUTDOOR AIR ECONOMIZER WITH

PROVIDE 2" MERV 13 PLEATED FILTER WITH HOLDING

SPACE MOUNTED HUMIDITY SENSOR FOR DDC OPEREATION

LOCKABLE COVERS FOR ALL SPACE MOUNTED SENSORS

0-100% MODULATING OUTDOOR AIR ECONOMIZER WITH

PROVIDE MICROPROCESSOR CONTROLS AND DIGITAL

POWER EXHAUST FAN TO RUN IN CONJUNCTION WITH

SMOKE DETECTORS IN SUPPLY AND RETURN WIRED TO

SPACE MOUNTED TEMPERATURE SENSOR FOR DDC OPEREATION WITH OVERRIDE AS NOTED ON THE PLANS.

RECESSED MOUNTING BOX

INTEGRAL THERMOSTAT

BELT DRIVE MOTOR

DIRECT DRIVE MOTOR

DISCONNECT MEANS

SPEED CONTROLLER

CRANKCASE HEATER

BAROMETRIC RELIEF

HOT GAS BYPASS

MHGR MODULATING HOT GAS REHEAT

BAROMETRIC RELIEF

R410A PROVIDE UNIT WITH R410 REFRIGERANT

RMMC REMOTE MOUNT MINI CONTROLLER BY UNIT

BMCCES BASE MOUNTED CLOSED COUPLED END SUCTION

BMHSC BASE MOUNTED HORIZONTAL SPLIT CASE BMVSC BASE MOUNTED VERTICAL SPLIT CASE

ROOM SENSOR

ECONOMIZER

MANUFACTURER

SHUT UNIT DOWN

VIC VIBRATION ISOLATION CURB.

BMES BASE MOUNTED END SUCTION

CONDENSER WATER

HEATING HOT WATER

CH CHILLED/HOT WATER
CW CHILLED WATER
DCW DOMESTIC COLD WATER
DHW DOMESTIC HOT WATER

IN-LINE

AB ALL BRONZE
AI ALL IRON
BF BRONZE FITTED

RECEPTACLE

ROOF JACK

PACKAGED ROOFTOP UNIT SCHEDULE

POUNDS PER HOUR PSI POUNDS PER SQUARE INCH RPM REVOLUTIONS PER MINUTE

MINIMUM

OUTSIDE AIR

TEMP. TEMPERATURE
THC TOTAL HEAT CAPACITY
WB WET BULB
WPD WATER PRESSURE DROP

CMF CEILING MOUNTING FRAME
DS ELECTRICAL DISCONNECTING
T WALL THERMOSTAT THERMO

ELECTRIC BASEBOARD HEATER

ELECTRIC CEILING HEATER

ELECTRIC WALL HEATER

EXHAUST FAN SCHEDULE

GBD RJ SC

CCH

CO2

ECON

MOAE

PUMP SCHEDULE

HW

CURB ROOF CURB
DD DIRECT DRIVE

ABBREVIATED SCHEDULE HEADINGS

A AMPS
CAP CAPACITY
CFM CUBIC FEET PER MINUTE
DB DRY BULB
E.A.T. ENTERING AIR TEMPERATURE


EXTERNAL TO UNIT

EER ENERGY EFFICIENCY RATIO
EST. ESTIMATED
FLA FULL LOAD AMPS
FPM FEET PER MINUTE

MCA MIN.

3333 E. Battlefield Rd | Suite 1000 Springfield, MO 65804 417.881.0020 | www.rtmec.com STATE OF MISSOURI

CERTIFICATE OF AUTHORITY: 2014035826 FOR ENGINEERING

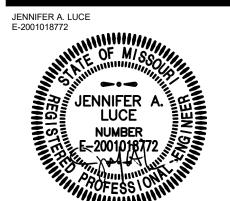

THESE PRINTS ARE THE PROPERTY OF PARAGON
ARCHITECTURE, LLC AND SHALL BE USED ONLY FOR THE
PROJECT REFERENCE BELOW

REVISION SCHEDULE

ORMING RF Ш Ω S

PROJECT ENGINEER: JAL DRAWN BY: CHECKED BY: JAL

PROJECT NUMBER: 21-620

DATE: 05-17-2023

MECHANICAL SCHEDULES

SHEET NUMBER:

M4-1

(HP) NOTES


0.33 CURB, DD, DM, GBD, SC

0.06 DD, DM, GBD, RJ, SC MARK | MANUFACTURER | DD, DM, GBD, RJ, SC

El	LECTR	IC CEI	LING	G HE	EATI	ER	SC	HE	EDI	JLE
			SUPPLY	HEATING		ELECTI	RICAL DA	ATA		
PLAN			AIR FLOW	ELEMENT					MOCP	
MARK	MANUFACTURER	MODEL	(CFM)	(WATTS)	VOLTAGE	PHASE	FLA	MCA	(A)	NOTES
ECH1	BERKO	OFF4004	100	3,000	208	1	14	18	20	CMF, DS, T
FCH2	BERKO	OFF4004	100	3 000	208	1	14	18	20	CME DS T

EI	LECTR	IC BAS	SEBO	DAR	D HE	AT	ER			
				HEATING		ELECTRI	CAL DA	ГА		
PLAN			LENGTH	ELEMENT					MOCP	
MARK	MANUFACTURER	MODEL	(IN)	(WATTS)	VOLTAGE	PHASE	FLA	MCA	(A)	NOTES
EBH1	BERKO	BKO2508W	72	2,000	120	1	10	12	15	DS, T
EBH2	BERKO	BKO2508W	72	2,000	120	1	10	12	15	DS, T

80 6	5 85 11	11.4	105	240,000	194,000	81	480	3 25	32 40	5000	2SH, BRD, CC, CCH, CR, CO2, CURB, DS, ECON, F, H, LC, MHGR, PE, R410A, SD, T
GR	RILLE, F	REGIS	STER	AND	DIF	FUS	SER	SCH	EDUI	LE	
PLAN MARK	MANUFACTURER	MODEL	APPLICATION	FINISH	FRAME TYPE	VOLUME DAMPER	MAXIMUM NC	MINIMUM THROW (FT)	MAXIMUM THROW (FT)	MAXIMUM ΔP (IN WG)	NOTES
EA	TITUS	PAR-24 x 24	EXHAUST	BY ARCH	GRID	No	30	0	0	0.10	24x24 SQUARE PERFORATED FACE WITH ROUND DUCT CONNECTION
RA	TITUS	PAR-24 x 24	RETURN	BY ARCH	GRID	No	30	0	0	0.10	24X24 SQUARE PERFORATED FACE WITH SQUARE DUCT CONNECTION
RB	TITUS	350-RL	RETURN	BY ARCH	SURFACE	No	30	0	0	0.10	WALL GRILLE - DOUBLE DEFLECTION - ALUMINUM
SA	TITUS	TDCA-24 x 24	SUPPLY	BY ARCH	GRID	Yes	30	7	17	0.10	24x24 SQUARE LOUVER FACE WITH ROUND DUCT CONNECTION
SB	TITUS	TDCA-12 x 12	SUPPLY	BY ARCH	SURFACE	Yes	30	7	17	0.10	12x12 SQUARE LOUVER FACE WITH ROUND DUCT CONNECTION
SC	TITUS	TDCA-24 x 24	SUPPLY	BY ARCH	GYP	Yes	30	7	17	0.10	24x24 SQUARE LOUVER FACE WITH ROUND DUCT CONNECTION
SD	TITUS	300-FL	SUPPLY	BY ARCH	SURFACE	No	30	7	17	0.10	WALL GRILLE - DOUBLE DEFLECTION - ALUMINUM
SE	TITUS	S300-FL	SUPPLY	BY ARCH	DUCT	No	30	7	17	0.10	DUCT GRILLE - DOUBLE DEFLECTION - ALUMINUM
SF	TITUS	FL-10-2CRB-F BPI	SUPPLY	BY ARCH	GYP	No	25	12	30		48" CONTINUOUS FLOWBAR LINEAR SLOT DIFFUSER W/ (2) 1" SLOTS SET TO JET FLOW (0 DEGREE DEFLECTION) & INSULATED PLENUM BOX
SG	TITUS	300-FI	SUPPLY	BY ARCH	DUCT	No	30	7	17	0.10	DUCT GRILLE - DOUBLE DEELECTION - ALLIMINIUM

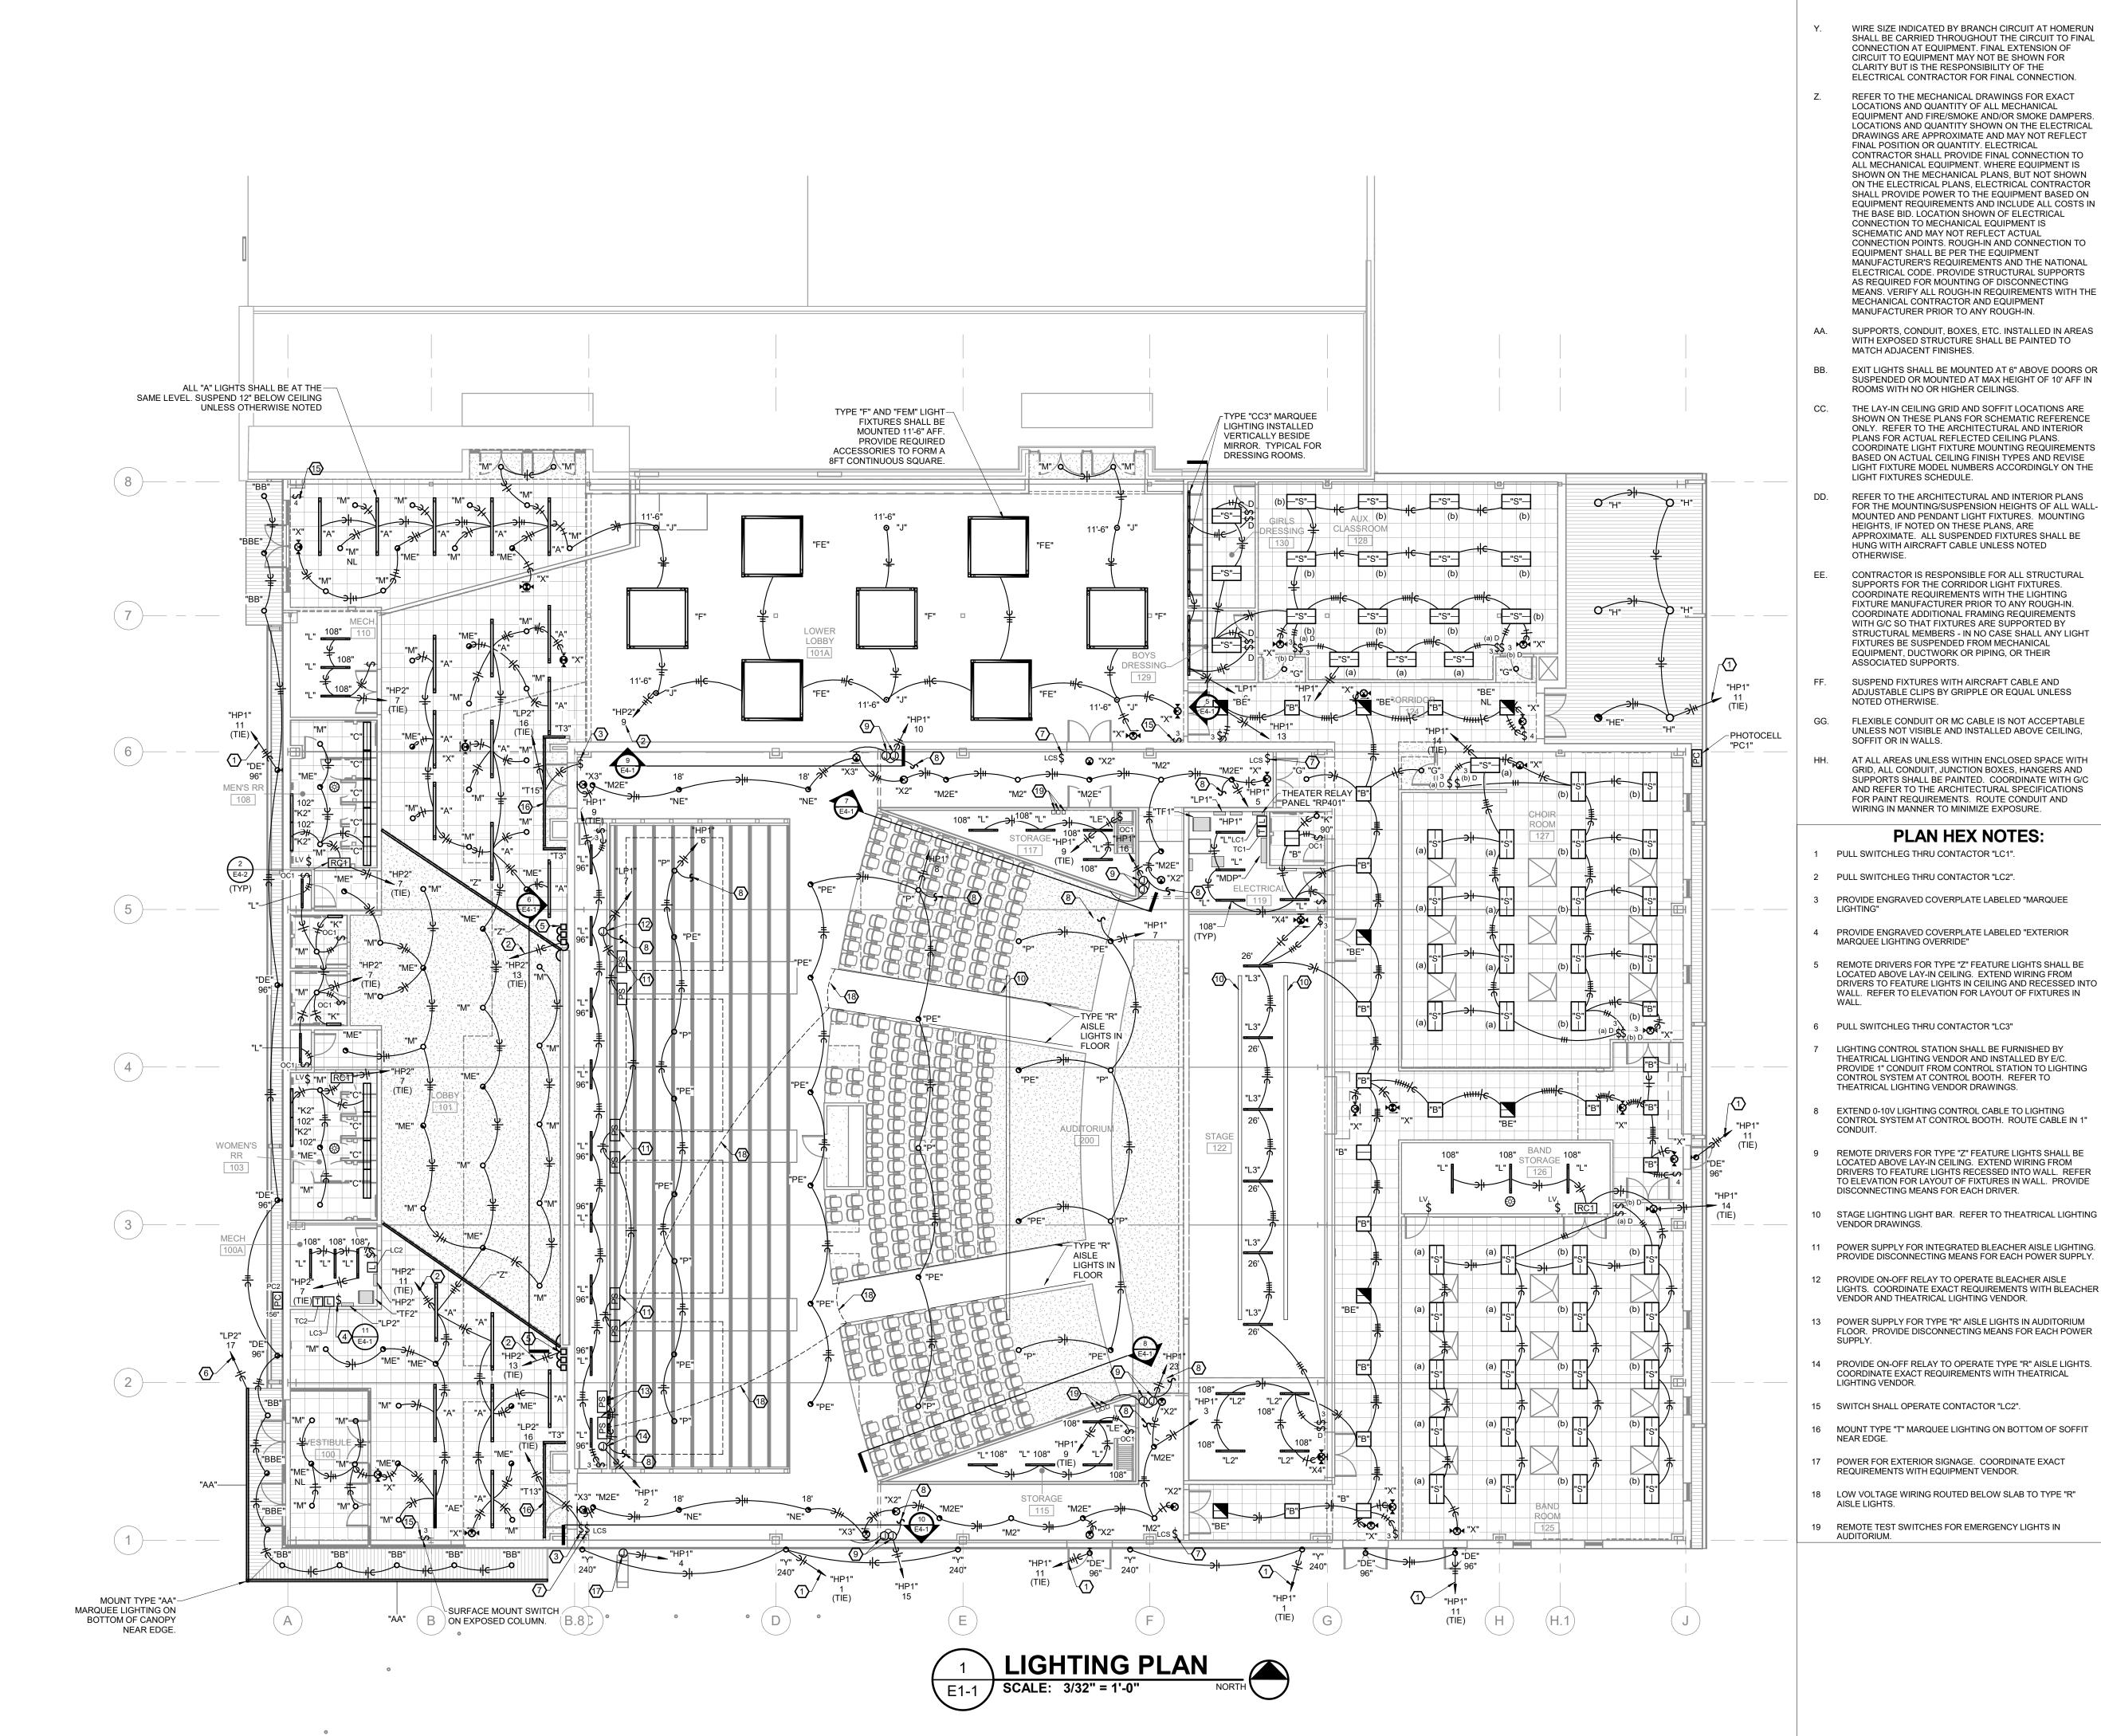

THIS WORK IS PROTECTED UNDER U.S. COPYRIGHT LAW AND THE ARCHITECT CONSTITUTES A SERVICE FEE OF 1.5% WILL BE CHARGED PER MONTH ON THE USE OF THESE DOCUMENTS FOR ANY PURPOSE, BY ANYONE. USE OF THE USE OF THESE DOCUMENTS FOR ANY PURPOSE, BY ANYONE. USE OF THESE DOCUMENTS FOR ANY PURPOSE, BY ANYONE. USE OF THESE DOCUMENTS FOR ANY PURPOSE, BY ANYONE. USE OF THESE DOCUMENTS FOR ANY PURPOSE, BY ANY PURPOSE

- THESE GENERAL NOTES APPLY TO ALL ELECTRICAL AND SPECIAL SYSTEMS DRAWINGS. REFER TO DIVISION 26, 27 AND 28 SPECIFICATIONS FOR ADDITIONAL ELECTRICAL AND SPECIAL SYSTEMS SPECIFICATIONS AND REQUIREMENTS.
- FINAL ACCEPTANCE OF WORK SHALL BE SUBJECT TO THE CONDITION THAT ALL SYSTEMS, EQUIPMENT, APPARATUS, AND APPLIANCES OPERATE SATISFACTORILY AS DESIGNED AND INTENDED; WORK SHALL INCLUDE REQUIRED REPLACEMENT, ADJUSTMENT OF SYSTEMS AND CONTROL EQUIPMENT AND ALL REQUIRED PROGRAMMING INSTALLED. PROVIDE FOR ALL
- PROVIDE NECESSARY MATERIALS AND ACCESSORIES FOR INSTALLATION OF FIXTURES, EQUIPMENT, ETC AS REQUIRED FOR COMPLETE AND FUNCTIONAL OPERATION
- AS NOTED ON DRAWINGS OR IN NOTES.
- ALL EQUIPMENT, FIXTURES, MATERIALS, ETC SHALL BE INSTALLED IN NEAT, PROFESSIONAL MANNER IN ACCORDANCE WITH MANUFACTURER
- PROVIDE ALL FIRE RATED MATERIAL FOR PATCH AND REPAIR FOR ALL FIRE RATED ASSEMBLIES. ALL
- THE CONTRACTOR SHALL VERIFY ALL EXISTING CONDITIONS PRIOR TO SUBMITTING BID. NO EXTRAS WILL BE PAID DUE TO UNANTICIPATED EXISTING
- THE CONTRACTOR SHALL SCHEDULE AND EXECUTE ALL
- PLANS ARE DIAGRAMMATIC AND SHALL NOT BE SCALED.
- ROUGH-IN
- COORDINATE ADDITIONAL FRAMING REQUIREMENTS WITH G/C SO THAT FIXTURES ARE SUPPORTED BY STRUCTURAL MEMBERS - IN NO CASE SHALL ANY LIGHT FIXTURES BE SUSPENDED FROM MECHANICAL EQUIPMENT, DUCTWORK OR PIPING, OR THEIR ASSOCIATED SUPPORTS.
- NOTED OTHERWISE. FLEXIBLE CONDUIT OR MC CABLE IS NOT ACCEPTABLE
- SOFFIT OR IN WALLS. AT ALL AREAS UNLESS WITHIN ENCLOSED SPACE WITH GRID, ALL CONDUIT, JUNCTION BOXES, HANGERS AND SUPPORTS SHALL BE PAINTED. COORDINATE WITH G/C

PLAN HEX NOTES:

- PULL SWITCHLEG THRU CONTACTOR "LC1".
- 2 PULL SWITCHLEG THRU CONTACTOR "LC2".
- 3 PROVIDE ENGRAVED COVERPLATE LABELED "MARQUEE
- PROVIDE ENGRAVED COVERPLATE LABELED "EXTERIOR MARQUEE LIGHTING OVERRIDE"
- REMOTE DRIVERS FOR TYPE "Z" FEATURE LIGHTS SHALL BE LOCATED ABOVE LAY-IN CEILING. EXTEND WIRING FROM DRIVERS TO FEATURE LIGHTS IN CEILING AND RECESSED INTO WALL. REFER TO ELEVATION FOR LAYOUT OF FIXTURES IN
- 6 PULL SWITCHLEG THRU CONTACTOR "LC3"
- LIGHTING CONTROL STATION SHALL BE FURNISHED BY THEATRICAL LIGHTING VENDOR AND INSTALLED BY F/C. PROVIDE 1" CONDUIT FROM CONTROL STATION TO LIGHTING CONTROL SYSTEM AT CONTROL BOOTH. REFER TO THEATRICAL LIGHTING VENDOR DRAWINGS.
- EXTEND 0-10V LIGHTING CONTROL CABLE TO LIGHTING CONTROL SYSTEM AT CONTROL BOOTH. ROUTE CABLE IN 1"
- REMOTE DRIVERS FOR TYPE "Z" FEATURE LIGHTS SHALL BE LOCATED ABOVE LAY-IN CEILING. EXTEND WIRING FROM DRIVERS TO FEATURE LIGHTS RECESSED INTO WALL. REFER TO ELEVATION FOR LAYOUT OF FIXTURES IN WALL. PROVIDE
- 10 STAGE LIGHTING LIGHT BAR. REFER TO THEATRICAL LIGHTING VENDOR DRAWINGS.
- POWER SUPPLY FOR INTEGRATED BLEACHER AISLE LIGHTING. PROVIDE DISCONNECTING MEANS FOR EACH POWER SUPPLY.
- 12 PROVIDE ON-OFF RELAY TO OPERATE BLEACHER AISLE LIGHTS. COORDINATE EXACT REQUIREMENTS WITH BLEACHER VENDOR AND THEATRICAL LIGHTING VENDOR.
- 13 POWER SUPPLY FOR TYPE "R" AISLE LIGHTS IN AUDITORIUM FLOOR. PROVIDE DISCONNECTING MEANS FOR EACH POWER
- 14 PROVIDE ON-OFF RELAY TO OPERATE TYPE "R" AISLE LIGHTS. COORDINATE EXACT REQUIREMENTS WITH THEATRICAL LIGHTING VENDOR.
- 15 SWITCH SHALL OPERATE CONTACTOR "LC2".
- 16 MOUNT TYPE "T" MARQUEE LIGHTING ON BOTTOM OF SOFFIT
- 17 POWER FOR EXTERIOR SIGNAGE. COORDINATE EXACT REQUIREMENTS WITH EQUIPMENT VENDOR.
- 18 LOW VOLTAGE WIRING ROUTED BELOW SLAB TO TYPE "R"
- 19 REMOTE TEST SWITCHES FOR EMERGENCY LIGHTS IN

- **GENERAL NOTES:**
- WORK INDICATED ON DRAWINGS OR AS REASONABLY
- ACCESS PANELS SHALL BE PROVIDED WHEREVER NECESSARY TO PROVIDE ACCESS TO VALVES, JUNCTION BOXES, ETC., LOCATED IN CONCEALED SPACES.
- RECOMMENDATIONS.
- THE CONTRACTOR SHALL CONTACT THE OWNER AND COORDINATE ALL OUTAGES 5 DAYS PRIOR TO ANY SHUT-OFF OF SERVICES.
- OPENINGS SHALL BE SEALED AND CLOSED IN APPROVED MANNER. PROVIDE SLEEVE WHERE NEEDED DUE TO SCOPE OF WORK.
- WORK WITH REGARD TO THE OWNER'S USE OF THE
- REFER TO ARCHITECTURAL DRAWINGS FOR
- REFER TO ARCHITECTURAL DRAWINGS FOR TYPICAL ROOM INTERIOR ELEVATIONS. COORDINATE EXACT DEVICE LOCATIONS AND MOUNTING HEIGHTS WITH ARCHITECT PRIOR TO
- COORDINATE ALL WIRING DEVICE LOCATIONS SHOWN AT MILLWORK LOCATIONS WITH THE MILLWORK CONTRACTOR AND GENERAL CONTRACTOR PRIOR TO ANY ROUGH-IN OR INSTALLATION. ALL WIRING DEVICES SHALL BE INSTALLED IN ACCESSIBLE LOCATIONS AND SHALL NOT BE CONCEALED.
- PROVIDE PULL BOXES AS REQUIRED TO PROPERLY INSTALL THE RACEWAYS AND CIRCUITS INDICATED.
- ALL EMPTY CONDUITS SHALL BE PROVIDED WITH ROT-PROOF PULL-TAPE, LABELED AT EACH END. ALL CONDUITS SHALL BE PROVIDED WITH PLASTIC BUSHINGS WHERE TERMINATED OPEN-ENDED.
- SEAL ALL PENETRATIONS THROUGH FIRE-RATED ASSEMBLIES AS NECESSARY TO RESTORE FIRE-RESISTANCE RATING OF ASSEMBLY. REFER TO ARCHITECTURAL PLANS AND SPECIFICATIONS FOR RATED ASSEMBLIES, FIRE STOPPING MATERIALS, AND REQUIREMENTS.
- EACH CONTRACTOR AND SUB-CONTRACTOR OR TRADE SHALL REVIEW THE BID DOCUMENTS AS A WHOLE. INCLUDING ALL OTHER TRADES' DRAWINGS AND PROVIDE ANY MISC. ITEMS, MATERIALS, WORK, ETC. REQUIRED TO COMPLETE THE WORK AS SHOWN ON ALL BID DOCUMENTS. THIS REQUIREMENT APPLIES TO ALL TRADES, STRUCTURAL, MECHANICAL, ELECTRICAL. PLUMBING, EQUIPMENT VENDORS, ETC. REQUIREMENTS AND RELATED WORK ARE INDICATED THROUGHOUT THE BID DOCUMENTS AND SHALL BE REVIEWED WITH THE SPECIFIC MEP, STRUCTURAL, ARCHITECTURAL, AND EQUIPMENT DRAWINGS FOR OVERALL SCOPE OF WORK.
- ELECTRICAL CONTRACTOR SHALL PROVIDE FINAL CONNECTION TO ALL MECHANICAL EQUIPMENT. WHERE EQUIPMENT IS SHOWN ON THE MECHANICAL PLANS, BUT NOT SHOWN ON THE ELECTRICAL PLANS, ELECTRICAL CONTRACTOR SHALL PROVIDE POWER TO THE EQUIPMENT BASED ON EQUIPMENT REQUIREMENTS AND INCLUDE ALL COSTS IN THE BASE BID.
 - LOCATION SHOWN OF ELECTRICAL CONNECTION TO MECHANICAL EQUIPMENT IS SCHEMATIC AND MAY NOT REFLECT ACTUAL CONNECTION POINTS, ROUGH-IN AND CONNECTION TO EQUIPMENT SHALL BE PER THE **EQUIPMENT MANUFACTURER'S REQUIREMENTS** AND THE NATIONAL ELECTRICAL CODE. PROVIDE STRUCTURAL SUPPORTS AS REQUIRED FOR MOUNTING OF DISCONNECTING MEANS. VERIFY ALL ROUGH-IN REQUIREMENTS WITH THE MECHANICAL CONTRACTOR AND EQUIPMENT MANUFACTURER PRIOR TO ANY
- PROVIDE FINAL CONNECTION TO ALL EQUIPMENT, INCLUDING ANY CORD AND PLUG SETS FOR EQUIPMENT NOT PROVIDED WITH IT (WHETHER SPECIFICALLY NOTED OR NOT). COORDINATE ALL WORK WITH THE EQUIPMENT SUPPLIER AND OWNER: AND VERIFY ALL ROUGH-IN LOCATIONS AND REQUIREMENTS PRIOR TO ANY ROUGH-
- THERMOSTATS AND ALL ASSOCIATED LOW VOLTAGE CONTROL WIRING SHALL BE SUPPLIED AND INSTALLED BY THE HVAC CONTRACTOR. THE ELECTRICAL CONTRACTOR SHALL FURNISH AND INSTALL THE NECESSARY CONDUIT, BOXES, ETC. FOR THE INSTALLATION OF THERMOSTATS. THE HVAC CONTRACTOR SHALL BE RESPONSIBLE FOR THE INSTALLATION AND CONNECTION OF THE THERMOSTATS AND ALL CONTROL WIRING. REFER TO MECHANICAL PLANS FOR THERMOSTAT LOCATIONS.
 - PROVIDE BACK BOX AND CONDUIT TO ACCESSIBLE CEILING AS REQUIRED FOR THE **DIVISION 23 WALL MOUNTED CONTROL DEVICES** FOR BUILDING AUTOMATION SYSTEM DEVICES COORDINATE EXACT LOCATIONS AND OTHER REQUIREMENTS WITH MECHANICAL DRAWINGS AND THE TEMPERATURE CONTROLS CONTRACTOR PRIOR TO ROUGH-IN. THERMOSTATS, TEMPERATURE SENSORS, STATIC PRESSURE SENSORS, HUMIDISTATS, ETC. SHALL BE INSTALLED AT THE SAME **ELEVATION AS THE LIGHT SWITCHES UNLESS** REQUIRED OTHERWISE.
- PROVIDE UNSWITCHED/UNCONTROLLED HOT FROM NEAREST CIRCUIT TO EXIT SIGNS AND EMERGENCY FIXTURES WITH INTEGRAL BATTERIES.
- PROVIDE A SEPARATE CODE SIZED GREEN EQUIPMENT GROUND CONDUCTOR IN ALL CONDUITS AND RACEWAYS CONTAINING LINE VOLTAGE CIRCUITS (120V OR HIGHER).
- REFER TO SPECIAL SYSTEMS SHEETS FOR APPROXIMATE LOCATIONS OF ALL DATA, TELEPHONE, TV NURSE CALL, ETC. DEVICES. COORDINATE LOCATION OF ALL ELECTRICAL EQUIPMENT WITH SPECIAL SYSTEMS
- PROVIDE ALL RACEWAYS, SLEEVES, BOXES, CABLE TRAY, ETC. AS INDICATED FOR THE OWNER PROVIDED DATA, PHONE, TV CABLING SYSTEM. COORDINATE EXACT REQUIREMENTS WITH OWNER AND OWNER CABLING CONTRACTOR.
- SYSTEM RACEWAYS AND PULL BOX LOCATIONS WITH THE OWNER AND CABLING CONTRACTOR.

COORDINATE EXACT ROUTE FOR ALL COMMUNICATIONS

- REFER TO ARCHITECTURAL EQUIPMENT DRAWINGS FOR EXACT LOCATIONS OF EQUIPMENT. COORDINATE EXACT REQUIREMENTS WITH EQUIPMENT SUPPLIER.
- NEUTRALS SHALL NOT BE SHARED FOR ANY CIRCUIT UNLESS SPECIFICALLY NOTED ON PLANS.



637 COLLEGE STREET SPRINGFIELD, MO 65806

PH: 417.885.0002 www.paragonarchitecture.com



engineering consultants 3333 E. Battlefield Rd | Suite 1000 Springfield, MO 65804 417.881.0020 | www.rtmec.com STATE OF MISSOURI

CERTIFICATE OF AUTHORITY:

2014035826

FOR ENGINEERING

JENNIFER A. LUCE



SE PRINTS ARE THE PROPERTY OF PARAGON CTURE, LLC AND SHALL BE USED ONLY FOR THE PROJECT REFERENCE BELOW

REVISION SCHEDULE

RMING $\overline{\mathbf{C}}$ Ш

PROJECT ENGINEER: JAL DRAWN BY: AGB CHECKED BY:

PROJECT NUMBER: 21-620

05-17-2023


LIGHTING PLAN

SHEET NUMBER:

PLAN I	HEX NO	TES
--------	--------	-----

	C	IRC	UI	T	BF	RE	Α	KER	P	AN	ELF	30	AF	RD	S	CH	ΙE	DU	LE			С	RC	Uľ	ΤВ	RI	EΑ	KE	R F	PAN	ELI	BC) A	RD	SC	H	ΞD	ULE
PANEL "LP				FE	TION: D BY: TING:	"TF3	3"	CAL 119		MANU	VOLTA ENCLOS UFACTUI PANEL T	URE: N	IEMA [^]	1	h, 4W		1	BUS R MCB R	IAIN TYPE: MCB ATING (A): 100 A ATING (A): 50 A ATING (A): 10000			PANEL NAME: "RP401"			OCATIO FED E OUNTIN	BY: "LI	P1"	CAL 119		MAN	VOLT ENCLOS IUFACTU PANEL 1	SURE: JRER:	NEMA ETC		, 4W	ı	MCE	MAIN TYPE: MERING (A): 2 B RATING (A): 2 C RATING (A): 1
CKT LOAD	D DESCRIPTION	С	w	(з Св	3 Р	TYPE	Α		В		С	TY	PE P	СВ	G	w	С	LOAD DESCRIPTION	СКТ	СКТ	LOAD DESCRIPTION	С	w	G	СВ Г	TYPE	I	4	В		С	-	TYPE P	СВ С	e w	, (C LOA
1 5	SOUND RACK	3/4"	#12	! #	12 20	1		1000 10	000					1	20 #	12	#12	3/4"	SOUND RACK	2	1	FRONT OF HOUSE LIGHTING	3/4"	#12	#12	20 1	1	480	480					1	20 #12	12 #1:	2 3/	4" FRONT
3 8	SOUND RACK	3/4"	#12	! #	12 20	1				1000 10	J00			1	20 #	12	#12	3/4"	SOUND RACK	4	3	FRONT OF HOUSE LIGHTING	3/4"	#12	#12	20 1	1			480	480			1	20 #12	12 #1:	2 3/	4" FRONT
5 5	SOUND RACK	3/4"	#12	! #	12 20	1					100	0 100	00	1	20 #	12	#12	3/4"	SOUND RACK	6	5	FRONT OF HOUSE LIGHTING	3/4"	#12	#12	20 1	1				45	80 4	480	1	20 #12	12 #1:	2 3/	4" FRONT
7	SPARE			-	- 20	1		0	0				-	- 1	20	-			SPARE	8	7	FRONT OF HOUSE LIGHTING	3/4"	#12	#12	20 1	1	480	480					1	20 #12	12 #1:	2 3/	4" FRONT
9	SPARE			-	- 20	1				0 (0		-	1	20				SPARE	10	9	FRONT OF HOUSE LIGHTING	3/4"	#12	#12	20 1	1			480	480			1	20 #12	12 #1:	2 3/	4" FRONT
11	SPARE			-	- 20	1					0	0	-	1	20				SPARE	12	11	STAGE LIGHTING #1	3/4"	#12	#12	20 1	1				44	45 4	445	1	20 #12	12 #1:	2 3/	/4" ST.
13	SPARE			-	- 20	1		0	0				-	1	20				SPARE	14	13	STAGE LIGHTING #1	3/4"	#12	#12	20 1	1	445	445					1	20 #12	12 #1:	2 3/	/4" ST.
15	SPARE			-	- 20	1				0 (0		-	- 1	20				SPARE	16	15	STAGE LIGHTING #1	3/4"	#12	#12	20 1	1			445	445			1	20 #12	2 #1:	2 3/	'4" ST
17	SPARE			-	20	1					0	0	-	- 1	20				SPARE	18	17	STAGE LIGHTING #2	3/4"	#12	#12	20 1	1				3f	62 3	362	1	20 #12	12 #1:	2 3/	'4" ST.
		(CONN	ECTE	D PH	ASE I	LOAD	2000 V	4	2000 VA	A 2	000 VA						SAL CIL	LATED PANEL AMPS:		19	STAGE LIGHTING #2	3/4"	#12	#12	20 1	1	362	362					1	20 #12	12 #1:	2 3/	/4" ST.
		*	PHASI	E DIV	ERSIF	IED I	LOAD	2000 V	4	2000 VA	A 2	000 VA					,	ALCU	LATED PANEL AIMPS:		21	STAGE LIGHTING #2	3/4"	#12	#12	20 1	1			362	362			1	20 #12	12 #1:	2 3/	'4" ST.
		*	PHASI	E DIV	ERSIF	IED /	AMPS	17 A		17 A		17 A							21 A		23	STAGE RIGHT FLOOR POCKET	3/4"	#12	#12	20 1	1				3F	60 3	360	1	20 #12	12 #1:	2 3/	4" STAGE
													(*DIV	ERSII	FIEDIC	ADS	CALC	UI ATF	D PER THE NATIONAL ELECTRIC C	ODE)	25	CONTROL PROCESSOR				20 1	1	0	720					1	20 #12	12 #1:	2 3/	4" CONTROL
NOTES/ACCESSO	ODIES:												(5.1			7100	07120	02/112	PANEL TOTALS	7002.)	27	SPARE				20 1	1			0	0			1	20	-	. -	-
	RE 20A. SINGLE-PO	I E BREAK	ERS I	ΙΔΙΙ	LIMLIS	SED 9	SPACE	S							Т	ΤΔΙ	CON	NECTE	D LOAD: 6000 VA		29	CONTROL BOOTH RECEPTACLES	3/4"	#10	#10	20 1	1				72	20 10	1000	1	20 #12	2 #1	2 3/	4"
1.1 NOVIDE OF A	INE 2011, OHTOLE I O	LL DIVL/ (IV	_1 (0 11	1/1	. 01100	JLD (01 7101	_0.											D LOAD: 6000 VA					CONNE	ECTED F	PHASE	E LOAD	4254	1 VA	3534 V	A !	5014 V	/A				CAL	CULATED PANE
															- "				G LOAD: N/A				*	PHASE	DIVER	SIFIE	D LOAD	505	5 VA	4199 V	A !	5958 V	/A				CAL	JULATED PAND
																		OLLIN	O LOAD. IN/A				*	PHASE	DIVER	SIFIED	O AMPS	43	Α	35 A		51 A						63 A

E: MLO **A)**: 225 A **A):** 225 A **A):** 10000 LOAD DESCRIPTION ONT OF HOUSE LIGHTING STAGE LIGHTING #1 STAGE LIGHTING #1 STAGE LIGHTING #1 STAGE LIGHTING #2 STAGE LIGHTING #2 STAGE LIGHTING #2 AGE LEFT FLOOR POCKET TROL BOOTH RECEPTACLES SPARE DMX SPLITTER ANEL AMPS: (*DIVERSIFIED LOADS CALCULATED PER THE NATIONAL ELECTRIC CODE. NOTES/ACCESSORIES: PANEL TOTALS 1. PANEL FURNISHED BY THEATRICAL LIGHTING VENDOR, INSTALLED BY E/C. TOTAL CONNECTED LOAD: 12802 VA TOTAL DIVERSIFIED LOAD: 15213 VA CONTROLLING LOAD: N/A

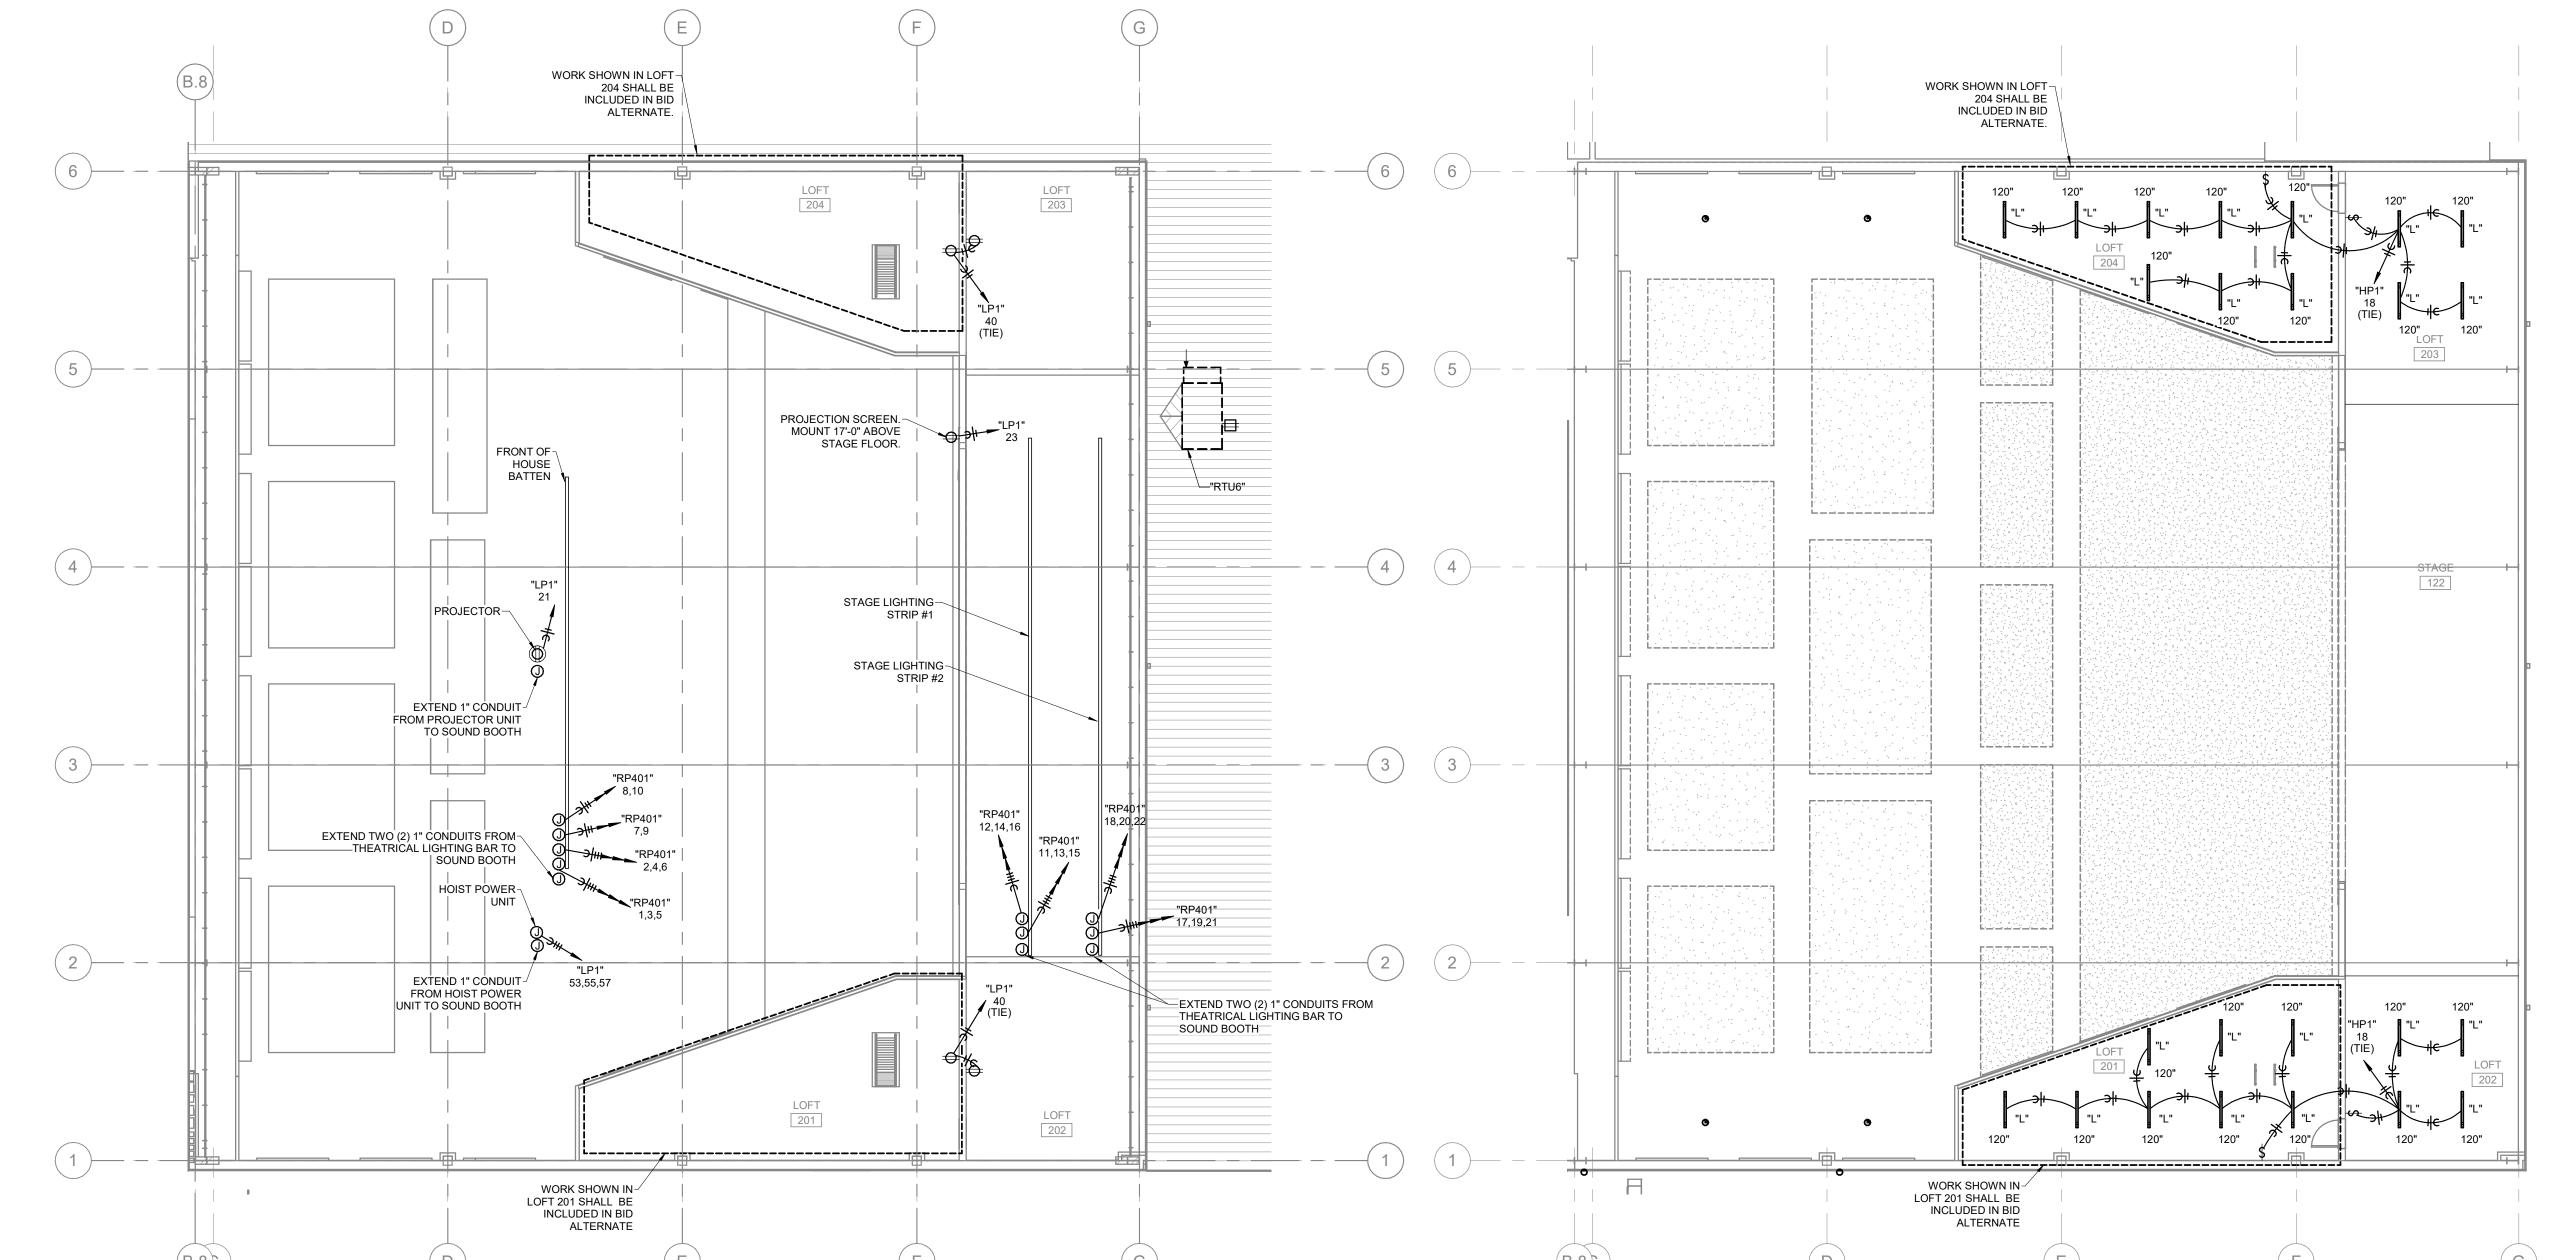

THIS WORK IS PROTECTED UNDER U.S. COPYRIGHT LAW AND THE ARCHITECTURAL WORKS COPYRIGHT PROTECTION ACT OF 1980. FAILURE TO COMPENSATE PARAGON ARCHITECT AGREEMENT (CONTRACT), SHALL BE CONSTITUTES OF THESE DOCUMENTS AFTER FAILURE TO COMPENSATE PARAGON ARCHITECT AGREEMENT (CONTRACT), SHALL BE CONSTITUTES A BREACH OF CONTRACT, SHALL BE CONSTITUTED AND THE LOSS OF FRENCH ON THE LOSS OF FRENCH ON THE LOSS OF FRENCH ON THE LOSS OF THE CONTRACT, SHALL BE CONSTITUTED AND THE LOSS OF THE CONTRACT AND THE LOSS OF THE LOSS OF

2 MEZZANINE POWER PLAN
E1-2 SCALE: 3/32" = 1'-0"

NORTH

MEZZANINE LIGHTING PLAN

SCALE: 3/32" = 1'-0"



637 COLLEGE STREET SPRINGFIELD, MO 65806

PH: 417.885.0002 www.paragonarchitecture.com

JENNIFER A. LUCE E-2001018772

REVISION SCHEDULE

ARTS PERFORMING HS

PROJECT ENGINEER: JAL DRAWN BY: CHECKED BY:

PROJECT NUMBER: 21-620

DATE: 05-17-2023

MEZZANINE ELECTRICAL **PLANS**

SHEET NUMBER:

E1-2

THIS WORK IS PROTECTED UNDER U.S. COPYRIGHT LAW AND THE ARCHITECTURAL WORKS COPYRIGHT PROTECTION ACT OF 1990. FAILURE TO COMPENSATE PARAGON ARCHITECTURAL WORKS OF THE COST OF CONSTRUCTION MINIMUM IF CONTRACT IS IMPLIED CONTRACT, SHALL BE CONSIDERED SUBSTANTIAL NON-PERFORMANCE AND CONSTRUCTION MINIMUM IF CONTRACT ON FILE COST OF COLLECTION, INCLUDING ATTORNEY'S FEES.

GENERAL NOTES:

REFER TO SHEET E1-1 FOR GENERAL NOTES.

PLAN HEX NOTES:

- 1 POWER SUPPLY FOR RETRACTABLE BLEACHERS. MAKE ALL REQUIRED CONNECTIONS. COORDINATE WITH EQUIPMENT VENDOR.
- 2 ADA DOOR OPENER. MAKE ALL REQUIRED CONNECTIONS.
 INTERFACE WITH ACCESS CONTROL SYSTEM SO THAT OPENER
 WON'T OPERATE UNLESS SYSTEM RELEASES DOOR ACCESS.
- 3 POWER CONNECTION FOR OVERHEAD COILED DOOR. VERIFY ALL REQUIREMENTS WITH VENDOR IN FIELD. MAKE ALL REQUIRED CONNECTIONS.
- 4 DOOR CONTROL STATION. VERIFY ALL REQUIREMENTS WITH VENDOR IN FIELD. MAKE ALL REQUIRED CONNECTIONS.
- 5 SUSPEND BOTTOM OF TRANSFORMER "TF3" 10 FEET ABOVE FINISH FLOOR
- 6 PROVIDE RELAY. RELAY SHALL TURN FAN ON WHEN LIGHTS ARE TURNED ON AND SHALL TURN FAN OFF WHEN OCCUPANCY SENSOR TURNS LIGHTS OFF.




MISSOURI STATE CERTIFICATE OF AUTHORITY NUMBER A-2016000415
637 COLLEGE STREET
SPRINGFIELD, MO 65806

PH: 417.885.0002 www.paragonarchitecture.com



STATE OF MISSOURI CERTIFICATE OF AUTHORITY:

2014035826 FOR ENGINEERING

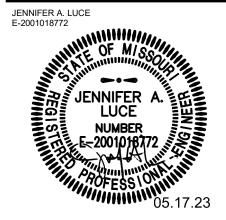

COPYRIGHT 2023 ©
THESE PRINTS ARE THE PROPERTY OF PARAGON
ARCHITECTURE, LLC AND SHALL BE USED ONLY FOR THE
PROJECT REFERENCE BELOW

REVISION SCHEDULE

SVILLE HS: PERFORMING ARTS

PROJECT ENGINEER: JAL
DRAWN BY: AGB
CHECKED BY: JAL


PROJECT NUMBER: 21-620

DATE: 05-17-2023

POWER PLAN

SHEET NUMBER:

E2-1

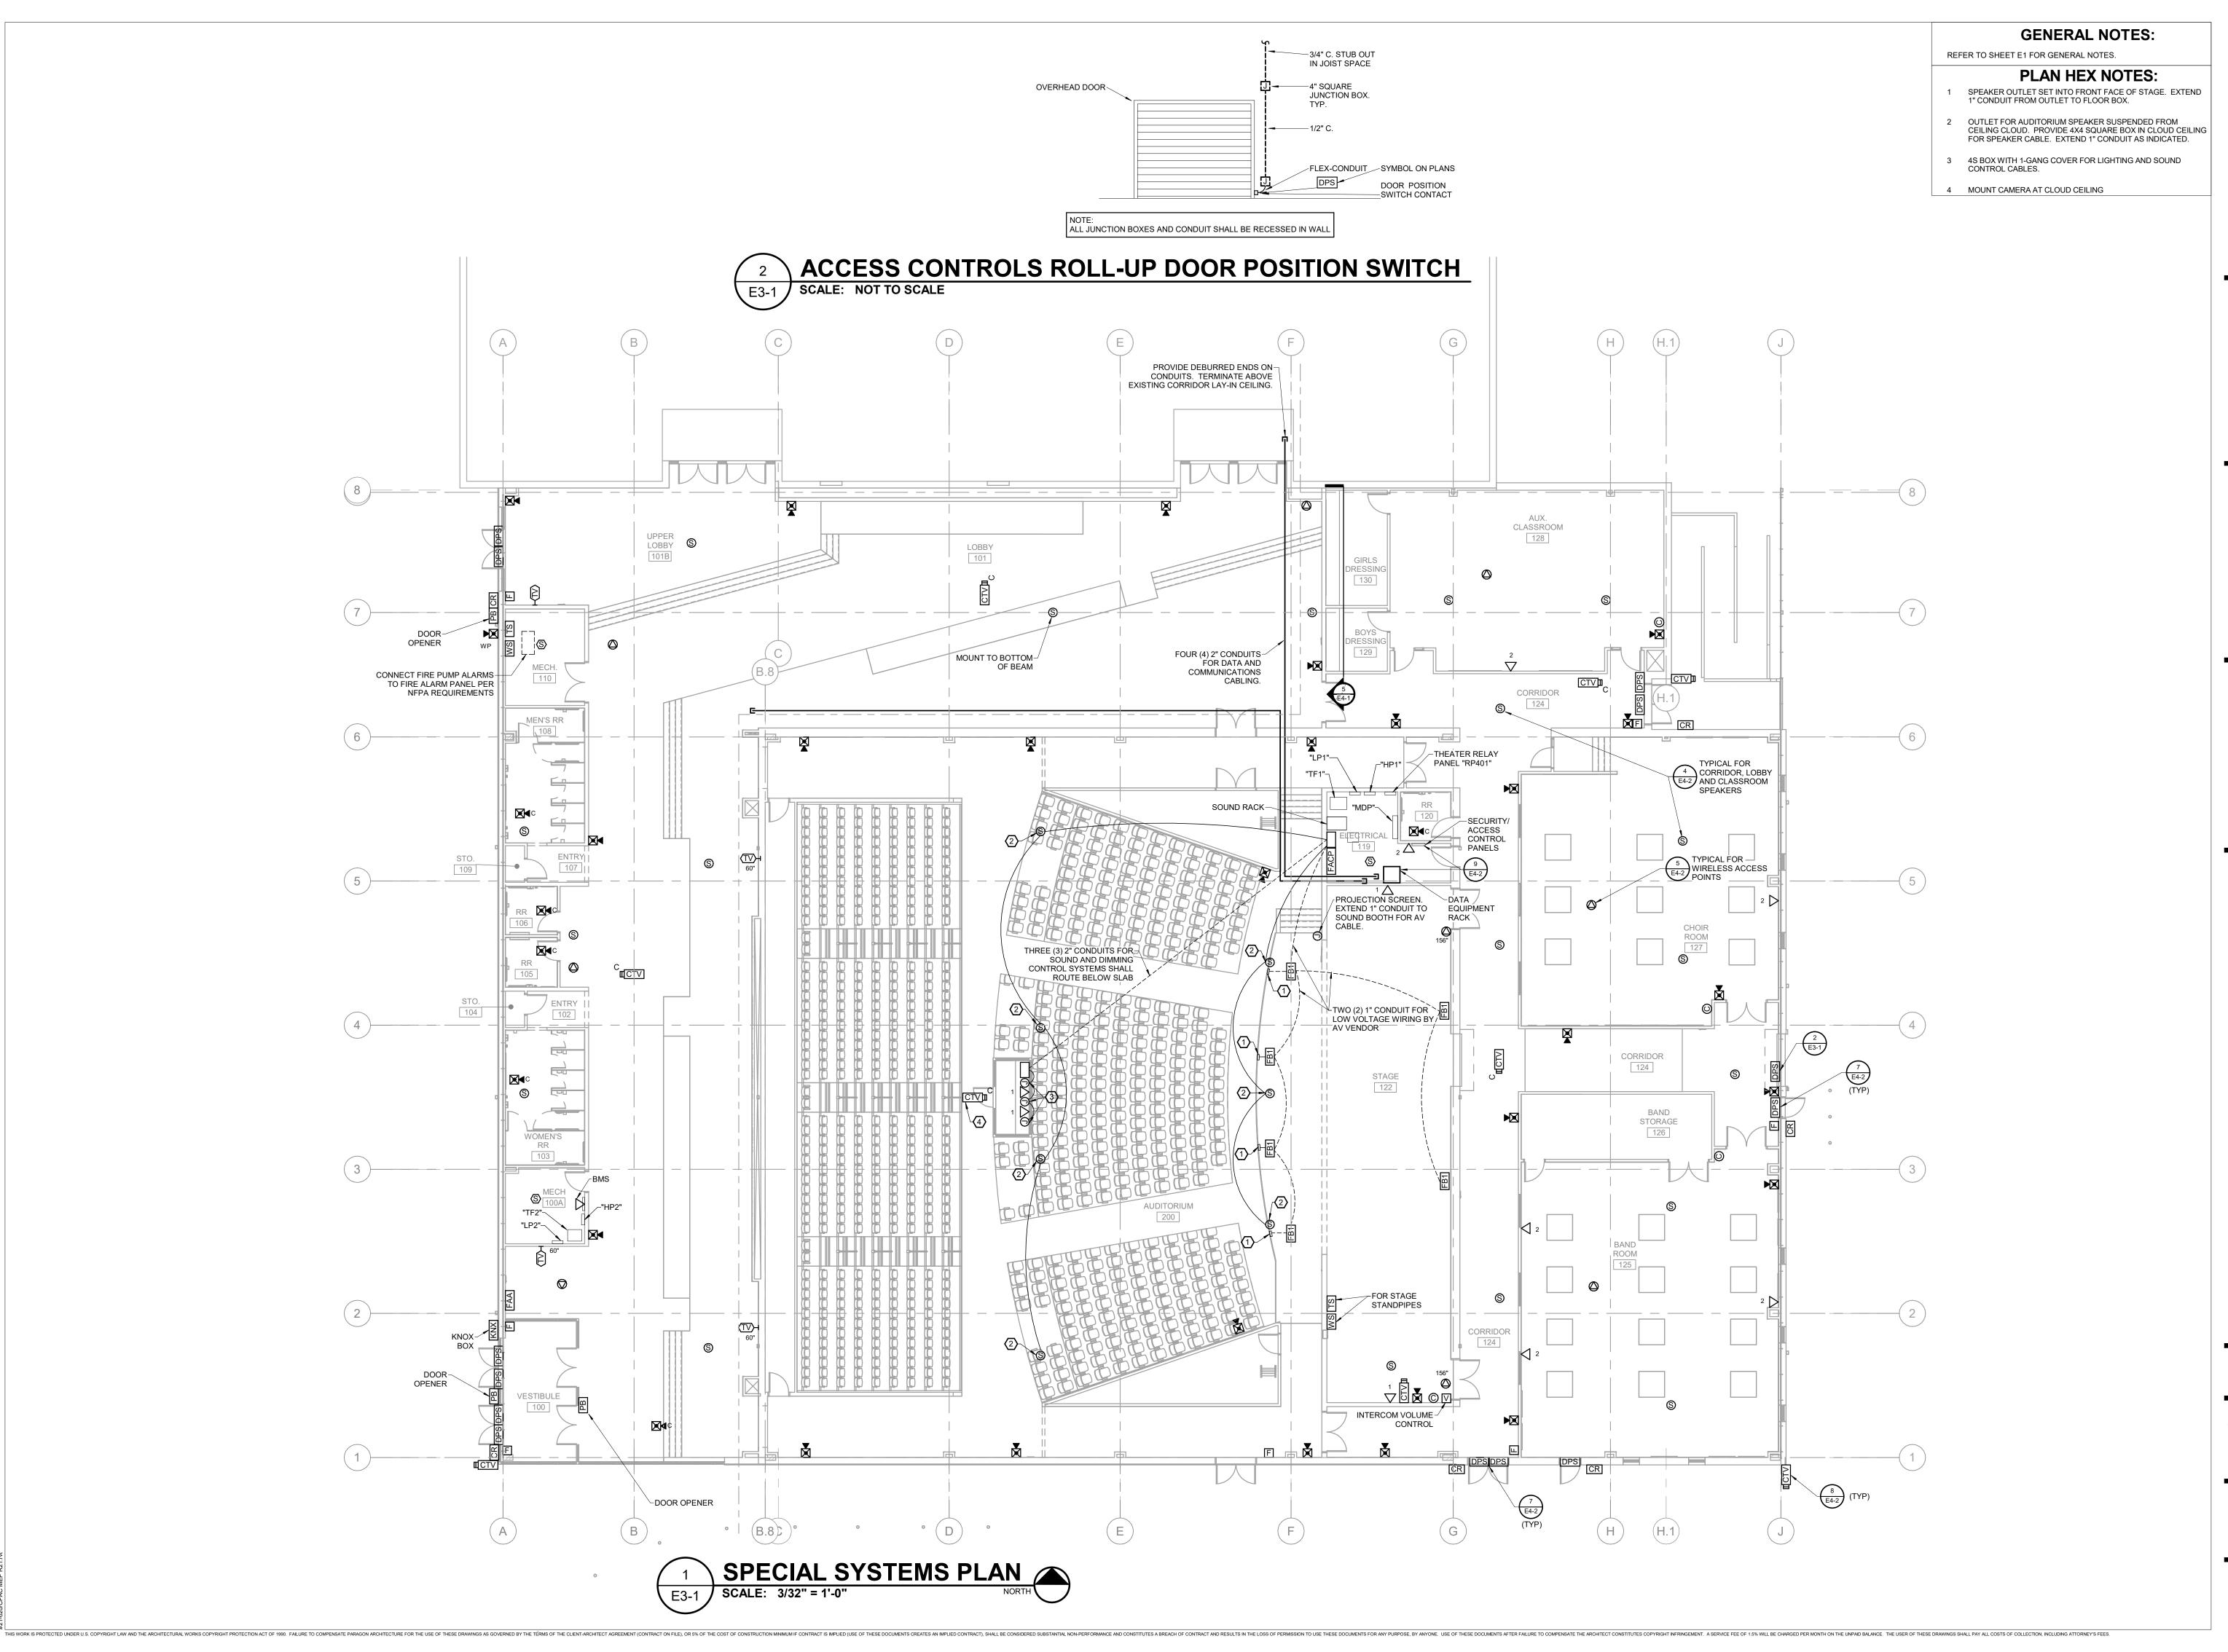

MISSOURI STATE CERTIFICATE OF AUTHORITY NUMBER A-2016000 637 COLLEGE STREET

SPRINGFIELD, MO 65806

PH: 417.885.0002 www.paragonarchitecture.com


V_r+_{roo}

engineering consultants
3333 E. Battlefield Rd | Suite 1000

3333 E. Battlefield Rd | Suite 1000 Springfield, MO 65804 417.881.0020 | www.rtmec.com STATE OF MISSOURI CERTIFICATE OF AUTHORITY: 2014035826

FOR ENGINEERING

JENNIFER A. LUCE E-2001018772

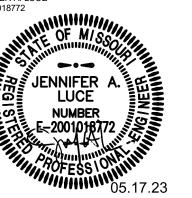

COPYRIGHT 2023 ©
THESE PRINTS ARE THE PROPERTY OF PARAGON
ARCHITECTURE, LLC AND SHALL BE USED ONLY FOR THE
PROJECT REFERENCE BELOW

REVISION SCHEDULE

VILLE HS: PERFORMING ARTS

PROJECT ENGINEER: JAL
DRAWN BY: AGB
CHECKED BY: JAL


PROJECT NUMBER: 21-620


DATE: 05-17-2023

SPECIAL SYSTEMS PLAN

SHEET NUMBER:

E3-1

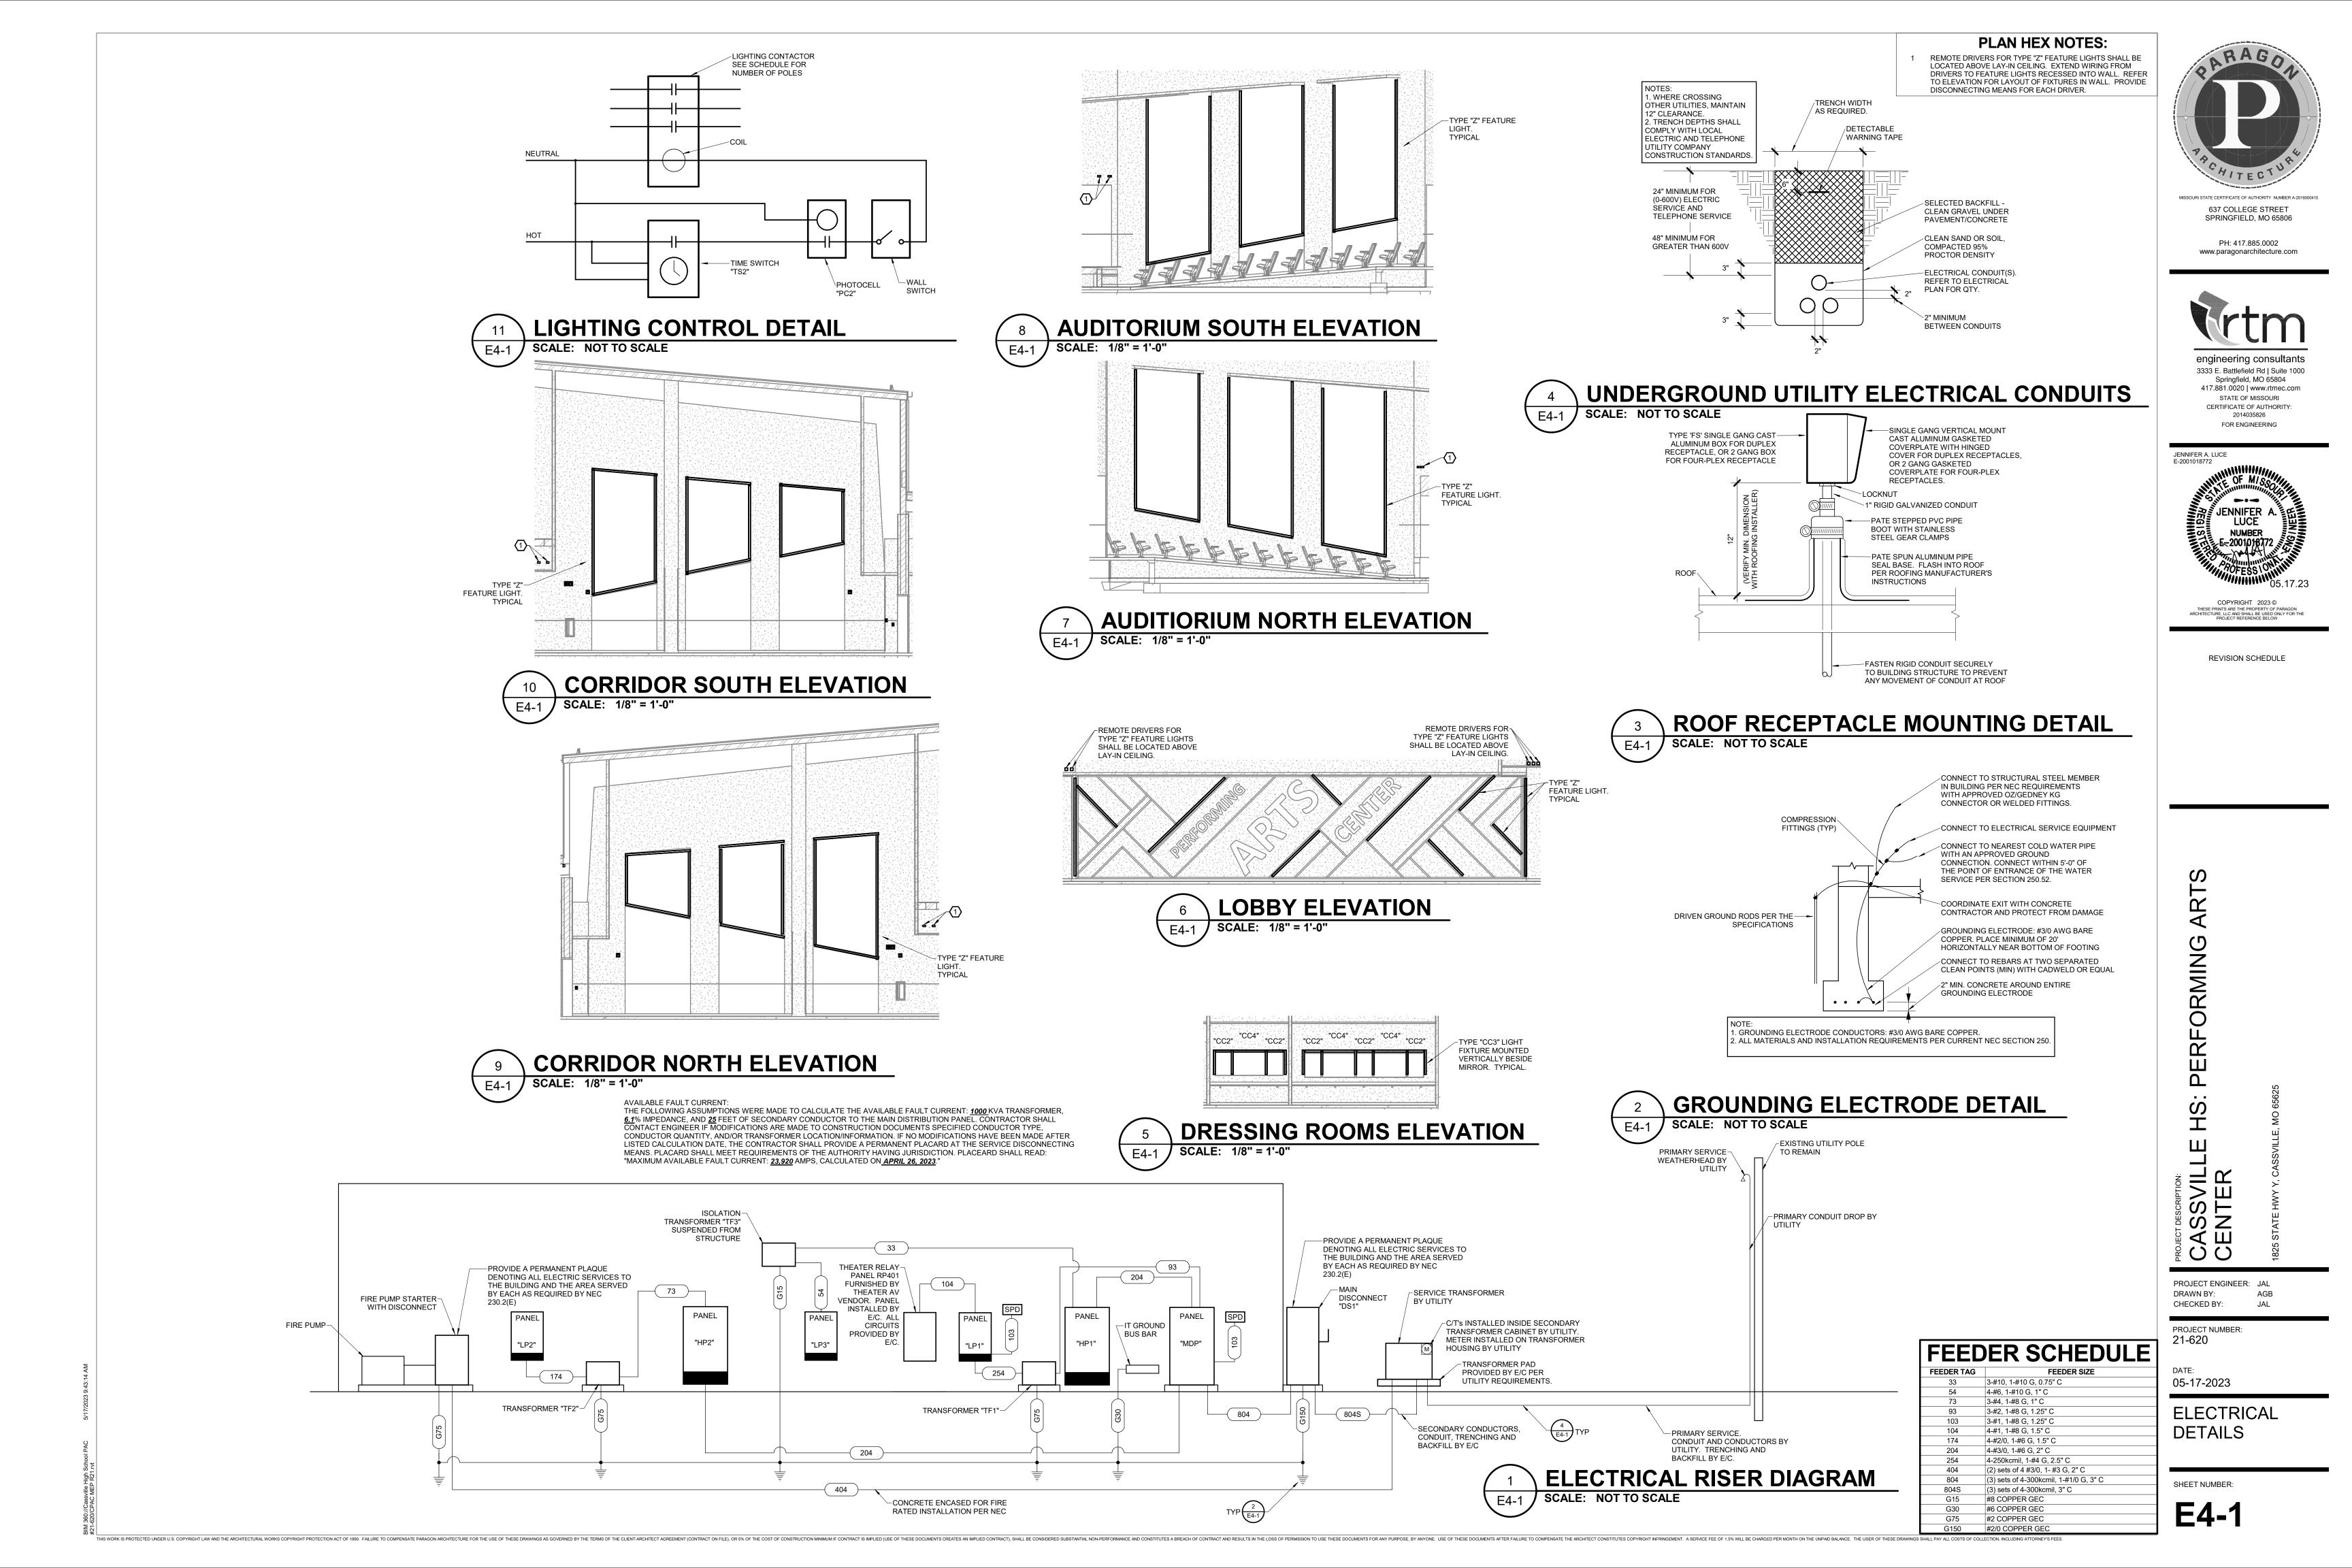

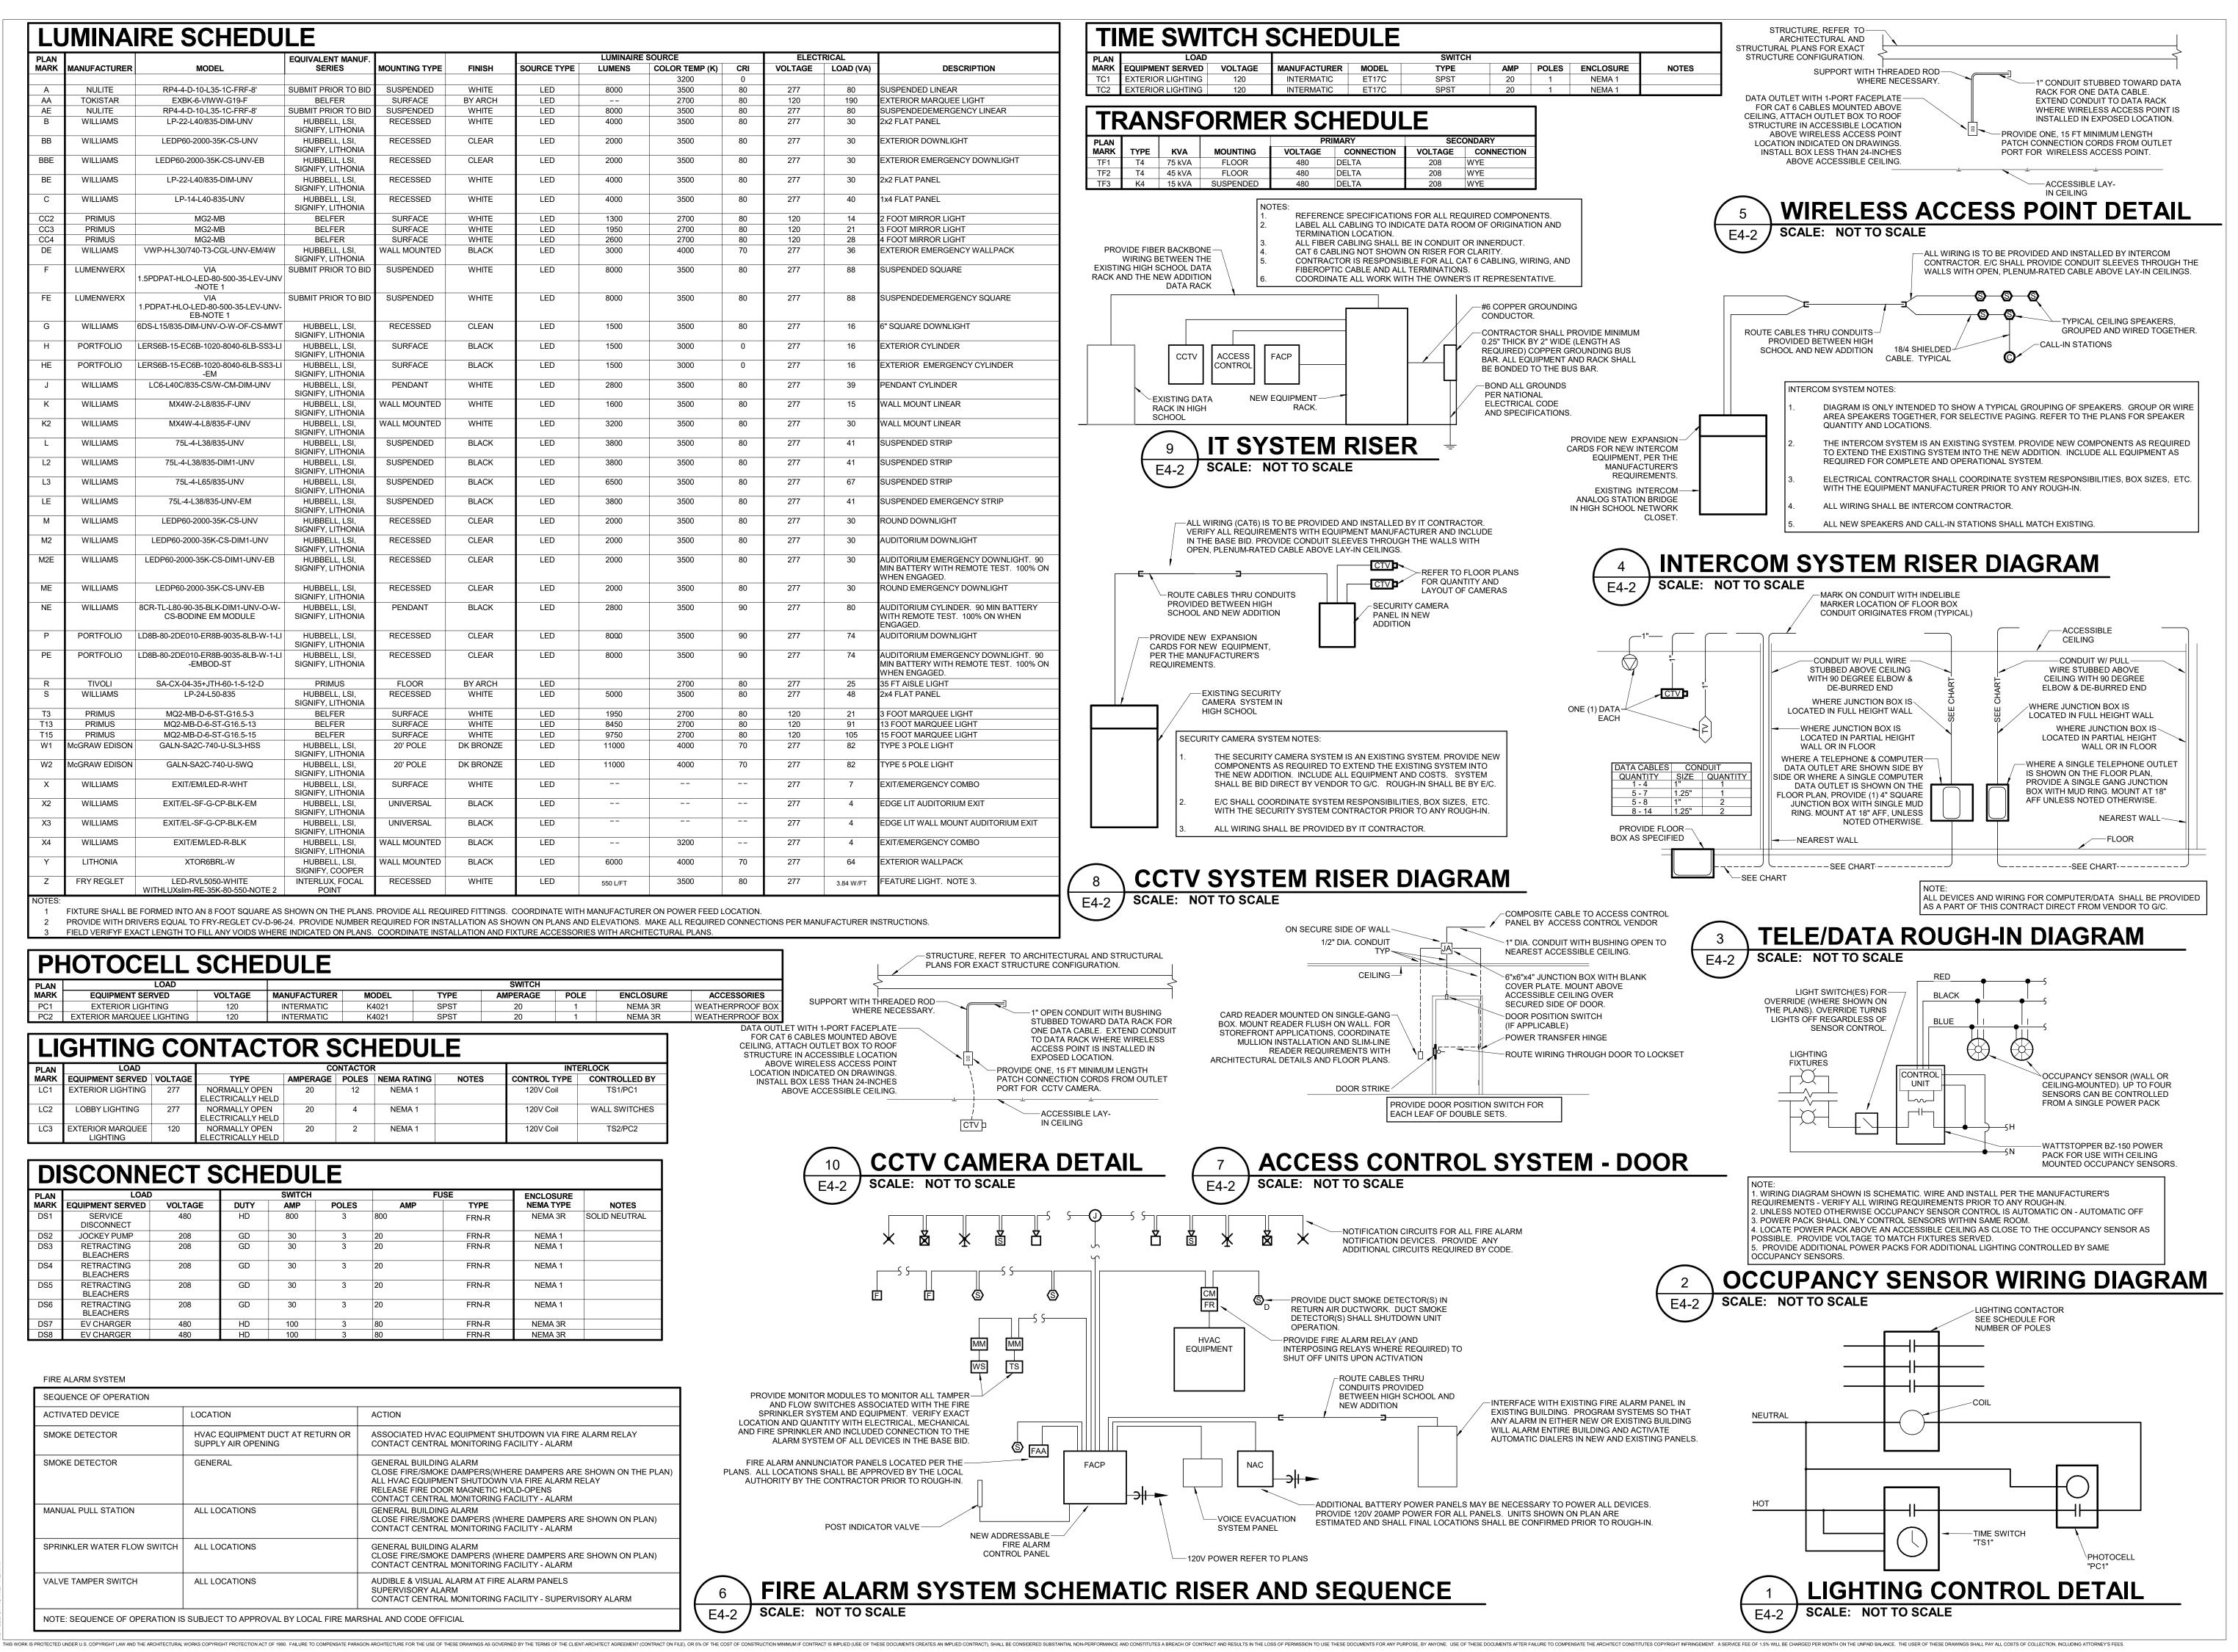

RAGONITECTURA

NISSOURI STATE CERTIFICATE OF AUTHORITY NUMBER A-201 637 COLLEGE STREET SPRINGFIELD, MO 65806

> PH: 417.885.0002 www.paragonarchitecture.com



CERTIFICATE OF AUTHORITY

2014035826

FOR ENGINEERING

ENNIFER A. LUCE



COPYRIGHT 2023 ©

THESE PRINTS ARE THE PROPERTY OF PARAGON ARCHITECTURE, LLC AND SHALL BE USED ONLY FOR THE PROJECT REFERENCE BELOW

REVISION SCHEDULE

ASSVILLE HS: PERFORMING ARTS

PROJECT ENGINEER: JAL DRAWN BY: AGB CHECKED BY: JAL

PROJECT NUMBER: 21-620

DATE:

05-17-2023

ELECTRICAL DETAILS & SCHEDULES

SHEET NUMBER:

E4-2

Р	ANELBOARD NOTES
-GENERAL NOT	
-GENERAL NOT	PROVIDE 20 AMP 1-POLE SPARE BREAKERS FOR ALL UNUSED POLES
•	UNLESS NOTED OTHERWISE.
2	
3	
CIRCUIT BREAK	KER ACCESSORY ABBREVIATION
AC	AUXILIARY CONTACTS
AF	ARC-FAULT INTERRUPTING
AT	ALARM TRIP
EPD	EQUIPMENT PROTECTION DEVICE
EX	EXISTING CIRCUIT BREAKER
GF	GROUND FAULT CIRCUIT INTERRUPTING BREAKER
HACR	HACR RATING
HLF	HANDLE LOCK-OFF
HLN	HANDLE LOCK-ON
SR	SWITCH RATING
ST	SHUNT TRIP BREAKER
PANELBOARD A	ACCESSORY ABBREVIATION
CH	CONCEALED HINGE
CL	COMPRESSION LUGS
CW	COLUMN WIDTH PANEL
DD	HINGED DOOR WITHIN A DOOR
EGB	EXTENDED GUTTER BOTTOM
EGL	EXTENDED GUTTER LEFT
EGR	EXTENDED GUTTER RIGHT
EGT	EXTENDED GUTTER TOP
FL	FLUSH LOCK(S)
FTL	FEED-THRU LUGS
GB	EQUIPMENT GROUND BAR
GBI	GROUND BAR INSULATOR
NBK	NEUTRAL BOND KIT
SER	SERVICE ENTRANCE RATING
SFB	SUB-FEED CIRCUIT BREAKER
SFL	SUB-FEED LUGS
SGB	SECOND GROUND BAR KIT
SPD	SURGE PROTECTION DEVICE
TRN	200% RATED NEUTRAL BAR

	PANEL NAME: "LP1"			FED I	BY: '	ELECT "TF1" SURFA		119		М	ENC ANUFA	OLTAG LOSUR CTURE EL TYP	E: NEM	ИА 1		ı, 4W		ľ	BUS RA	AIN TYPE: MCB ATING (A): 400 A ATING (A): 250 A ATING (A): 10000	
кт	LOAD DESCRIPTION	С	w	G	СВ	PTY	PE	A	A	ı	3	(С	TYPE	P	СВ	G	W	С	LOAD DESCRIPTION	СКТ
1	"EF4"	3/4"	#12	#12	20	1	6	60	300						1	20	#12	#12	3/4"	FIRE ALARM PANEL	2
3	"EF5" & "EF6"	3/4"	#12	#12	20	1				120	360				1	20	#12	#12	3/4"	DATA EQUIPMENT RECEPTACLE	4
5	DRESSING ROOM RECEPT	3/4"	#12	#12	20	1						180	364		1	20	#12	#12	3/4"	DRESSING RM MIRROR LIGHTING	6
7	BLEACHER AISLE LIGHTING	3/4"	#12	#12	20	1	5	00	1260						1	20	#10	#8	3/4"	ROOFTOP RECEPTACLES	8
9	BAND RECEPTACLES	3/4"	#10	#10	20	1				720	1130				1	20	#12	#12	3/4"	OVERHEAD DOOR	10
11	CLASSROOM RECEPTACLES	3/4"	#12	#12	20	1						720	1500		2	20	#12	#12	3/4"	"ECH2"	12
13	LOBBY RECEPTACLE	3/4"	#12	#12	20	1	1	80	1500												14
15	OVERHEAD DOOR	3/4"	#12	#12	20	1				1130	1200				1	20	#12	#12	3/4"	ACCESS CONTROL PANEL	16
17	"EWH1"	3/4"	#12	#12	20	2						1508	1508		2	20	#12	#12	3/4"	"EWH2"	18
19							. 15	508	1508					-	T						20
21	PROJECTOR	3/4"	#10	#10	20	1				1200	1440				1	20	#12	#12	3/4"	STAGE RECEPTACLES	22
23	PROJECTOR SCREEN	3/4"	#12	#12	20	1						180	180		1	20	#12	#12	3/4"	LOBBY RECEPTACLE	24
25	THEATER RELAY PANEL RP401	1-1/4"	#1	#8	100	3	42	254	180						1	20	#12	#12	3/4"	LOBBY RECEPTACLE	26
27										3534	180				1	20	#12	#12	3/4"	LOBBY RECEPTACLE	28
29												5014	180		1	20	#12	#12	3/4"	LOBBY RECEPTACLE	30
31	DRESSING ROOM RECEPT	3/4"	#12	#12	20	1	1	80	180						1	20	#12	#12	3/4"	DRESSING ROOM RECEPT	32
33	LOBBY RECEPTACLE	3/4"	#12	#12	20	1				180	180				1	20	#12	#12	3/4"	DRESSING ROOM RECEPT	34
35	DRESSING ROOM RECEPT	3/4"	#12	#12	20	1						180	720		1	20	#12	#12	3/4"	STAGE FLOOR BOXES	36
37	CORRIDOR RECEPTACLES	3/4"	#10	#10	20	1	7.	20	900						1	20	#10	#10	3/4"	BAND RECEPTACLES	38
39	DRESSING ROOM RECEPT	3/4"	#12	#12	20	1				180	720				1	20	#12	#12	3/4"	MEZZANINE RECEPTACLES	40
41	STAGE RECEPTACLES	3/4"	#10	#10	20	1						900	1080		1	20	#10	#10	3/4"	CORRIDOR RECEPTACLES	42
43	CHOIR RECEPTACLES	3/4"	#10	#10	20	1	10	080	0						1	20				SPARE	44
45	LOBBY RECEPTACLES	3/4"	#10	#10		1			-	900	1080				1		#12	#12	3/4"	CLASSROOM RECEPTACLES	46
47	SURGE PROTECTION DEVICE	1"	#3	#8	100	3						10	960		3	20	#12	#12	3/4"	RETRACTABLE BLEACHERS	48
49	<u></u>					<u> </u>	. 1	10	960											<u></u>	50
51	<u></u>					<u> </u>				10	960										52
53	HOIST POWER UNIT	3/4"	#12	#12	15	3						1200	0	-	1	20				SPARE	54
55							. 12	200	0						1	20				SPARE	56
57										1200	0				1	20				SPARE	58
59	SPARE				20	1 -						0	0		1	20				SPARE	60
61	SPARE				20	1 -		0	0						1	20				SPARE	62
63	SPARE				20	1 -				0	0				1	20				SPARE	64
65	SPARE				20	1 -						0	0		1	20				SPARE	66
67	SPARE				20	1 -		0	0						1	20				SPARE	68
69	SPARE				20	1 -				0	0				1	20				SPARE	70
71	SPARE				20	1 -						0	0		1	20				SPARE	72
73	SPARE				20	1 -		0	0						1	20				SPARE	74
75	SPARE				20	1 -				0	0				1	20				SPARE	76
77	SPARE				20	1 -						0	0	-	1	20				SPARE	78
79	SPARE				20	1 -		0	0					-	1	20				SPARE	80
81	SPARE				20	1 -				0	0				1	20				SPARE	82
83	SPARE				20	1 -						0	0	-	1	20				SPARE	84
			CONNEC	TED				1648	0 VA	1642	24 VA	-	4 VA		Ė				1	· · · ·	1 .
			PHASE [1 VA		4 VA		3 VA	-				C	ALCUL	ATED PANEL AMPS:	
														-						474 A	
		*F	PHASE [JIVER	SIFI	⊏U AM	75	139	9 A	13	9 A	139	9 A							174 A	
													(*	DIVER	RSIF	IED L	.OAD	S CALC	JLATE	PER THE NATIONAL ELECTRIC C	CODE.)
10TES	/ACCESSORIES:																			PANEL TOTALS	
	VIDE SPARE 20A, SINGLE-POLE																			D LOAD: 49288 VA	

	PANEL NAME:		1.00	CATIO	SNI I	\ 1 E (≎⊔ 400	٨			V		E. 120	/2001/	2D	h 1\1	,		RA A	AIN TYPE: MCB	
							CH 100	А				OLTAG			32	n, 4vv					
	"LP2"			FED I								LOSUR								ATING (A): 225 A	
			MO	UNTI	NG: S	SUF	RFACE			M	ANUFA			JARE I	D					ATING (A): 150 A	
											PAN	EL TYP	E: NQ					MIN.	AIC RA	ATING (A): 10000	
скт	LOAD DESCRIPTION	С	w	G	СВ	Р	TYPE		A	I	В	(С	TYPE	ĒΡ	СВ	G	W	С	LOAD DESCRIPTION	CK
1	HEATER "EBH1"	3/4"	#12	#12	20	1		1152	1152						1	20	#12	#12	3/4"	HEATER "EBH2"	2
3	WATER HEATER "WH1"	3/4"	#12	#12	20	1				600	480				1	20	#12	#12	3/4"	ADA DOOR OPENER	4
5	CIRC PUMP "P1"	3/4"	#12	#12	20	1						60	1260		1	20	#12	#12	3/4"	RESTROOM RECEPTACLES	6
7	LOBBY RECEPTACLES	3/4"	#12	#12	20	1		1580	740					GF	1	20	#12	#12	3/4"	WATER COOLERS	8
9	"EF2" & "EF3"	3/4"	#12	#12	20	1				120	1510				1	20	#12	#12	3/4"	LOBBY RECEPTS	10
11	ADA DOOR OPENER	3/4"	#12	#12	20	1						240	1500		2	20	#10	#10	3/4"	HEATER "ECH1"	12
13	"EF1"	3/4"	#12	#12	20	1		864	1500												14
15	ROOFTOP RECEPTACLES	3/4"	#12	#12	20	1				360	259				1	20	#12	#12	3/4"	AUDITORIUM MARQUEE LIGHTING	16
17	EXTERIOR MARQUEE LIGHTING	3/4"	#12	#12	20	1						380	360		1	20	#12	#12	3/4"	MECHANICAL RECEPTACLES	18
19	JOCKETY PUMP	3/4"	#12	#12	20	3		430	1200						1	20	#12	#12	3/4"	BMS PANEL	20
21										430	0				1	20				SPARE	22
23												430	0		1	20				SPARE	24
25	SPARE				20	1		0	0						1	20				SPARE	26
27	SPARE				20	1				0	0				1	20				SPARE	28
29	SPARE				20	1						0	0		1	20				SPARE	30
31	SPARE				20	1		0	0						1	20				SPARE	32
33	SPARE				20	1				0	0				1	20				SPARE	34
35	SPARE				20	1						0	0		1	20				SPARE	36
37	SPARE				20	1		0	0						1	20				SPARE	38
39	SPARE				20	1				0	0				1	20				SPARE	40
41	SPARE				20	1						0	0		1	20				SPARE	42
		(CONNEC					861	8 VA	375	9 VA	4230	0 VA						ALCU!	ATED DANIEL AMPS:	
		*F	PHASE D	OIVER	RSIFI	ED	LOAD	957	9 VA	417	8 VA	4702	2 VA		ı				ALCUL	ATED PANEL AMPS:	
		*F	PHASE D	IVER	SIFI	ED	AMPS	80) A	35	5 A	40) A							101 A	
		<u>•</u>										10		<u> </u>			0.15	0.041.6		PER THE NATIONAL ELECTRIC C	<u> </u>

CONTROLLING LOAD: HEATING

THIS WORK IS PROTECTED UNDER U.S. COPYRIGHT LAW AND THE ARCHITECTURAL WORKS COPYRIGHT PROTECTION ACT OF 15.9 WILL BE CONSTRUCTION MINIMUM IF CONTRACT, SHALL BE CONSTRUCTED BY THESE DOCUMENTS AFTER FAILURE TO COMPENSATE PARAGON ARCHITECTURAL WORKS COPYRIGHT INFRINGEMENT. A SERVICE FEE OF THESE DOCUMENTS AFTER FAILURE TO COMPENSATE PARAGON ARCHITECT AGREEMENT (CONTRACT, SHALL BE CONSTRUCTION MINIMUM IF CONTRACT, SHALL BE CONSTRUCTED SUBSTANTIAL NON-PERFORMANCE. THE USE OF THESE DOCUMENTS AFTER FAILURE TO COMPENSATE PARAGON ARCHITECT AGREEMENT (CONTRACT, SHALL BE CONSTRUCTED SUBSTANTIAL NON-PERFORMANCE. THE USE OF THESE DOCUMENTS AFTER FAILURE TO COMPENSATE PARAGON ARCHITECT AGREEMENT (CONTRACT, SHALL BE CONSTRUCTED SUBSTANTIAL NON-PERFORMANCE. THE USE OF THESE DOCUMENTS AFTER FAILURE TO COMPENSATE PARAGON ARCHITECT AGREEMENT (CONTRACT). SHALL BE CONSTRUCTED SUBSTANTIAL NON-PERFORMANCE AND ACCURATE TO COMPENSATE PARAGON ARCHITECT AGREEMENT (CONTRACT). SHALL BE CONSTRUCTED SUBSTANTIAL NON-PERFORMANCE AND ACCURATE TO COMPENSATE PARAGON ARCHITECT AGREEMENT (CONTRACT). SHALL BE CONTRACT AND ACCURATE TO COMPENSATE PARAGON ARCHITECT AGREEMENT (CONTRACT). SHALL BE CONTRACT AND ACCURATE TO COMPENSATE PARAGON ARCHITECT AGREEMENT (CONTRACT). SHALL BE CONTRACT AND ACCURATE TO COMPENSATE PARAGON ARCHITECT AGREEMENT (CONTRACT). SHALL BE CONTRACT AND ACCURATE TO COMPENSATE PARAGON ARCHITECT AGREEMENT (CONTRACT). SHALL BE CONTRACT AND ACCURATE TO COMPENSATE PARAGON ARCHITECT AGREEMENT (CONTRACT). SHALL BE CONTRACT AND ACCURATE TO COMPENSATE PARAGON ARCHITECT AGREEMENT (CONTRACT). SHALL BE CONTRACT AND ACCURATE TO COMPENSATE PARAGON ARCHITECT AGREEMENT (CONTRACT). SHALL BE CONTRACT AND ACCURATE TO COMPENSATE PARAGON ARCHITECT AGREEMENT (CONTRACT). SHALL BE CONTRACT AND ACCURATE TO COMPENSATE PARAGON ARCHITECT ACCURATE TO COMPENSATE PARAGON ARCHITECT ACCURATE TO COMPENSATE PARAGON ARCHITECT ACCURATE TO CONTRACT AND ACCURATE TO COMPENSATE PARAGON ARCHITECT ACCURATE TO CONTRACT AND ACCURATE TO CONTRACT AND ACCURATE TO CONTRACT AND A

AUDITORIUM FRONT LIGHTING 3/4" #12 #12 20 1		ATING (A): 225 A ATING (A): 225 A ATING (A): 25000	BUS RA			, 4W		/A 1		LOSURI	ENC ANUFA	M		AL 119	ECTRIC)P" RFACE	"ME	ED BY	F		PANEL NAME: "HP1"	
3 AUDITORIUM CORRIDOR LIGHTING 3 4" 4" 4" 2" 4" 2" 4" 5" 5" 5" 5" 5" 5" 5	N C				G	СВ	Р	TYPE				E	4	-	TYPE	3 P	G	w	С	LOAD DESCRIPTION	СКТ
3 AUDITORIUM CORRIDOR LIGHTING 3 IA*	ΓING	AUDITORIUM AISI E LIGHTING	3/4"	#12	#12	20	1						500	322) 1	±12 :	#12	3/4"	EXTERIOR WALL PACK LIGHTING	1
AUDITORIUM CORRIDOR LIGHTING 3/4" #12 #12 20 1							1				500	365		<u> </u>		_	_				
AUDITORIUM FRONT LIGHTING 3/4" #12 #12 20 1		AUDITORIUM BLEACHER LIGHTING					1		592	398						_					
9 AUDITORIUM STORAGE LIGHTING 9 AUDITORIUM STORAGE LIGHTING 11 EXTERIOR WALLPACK LIGHTING 13 CORRIDOR LIGHTING 14 CORRIDOR LIGHTING 15 CORRIDOR LIGHTING 16 CORRIDOR LIGHTING 17 CORRIDOR LIGHTING 18		AUDITORIUM CENTER LIGHTING	3/4"	#12			1						814	592					3/4"	AUDITORIUM FRONT LIGHTING	
The composition of the composi		AUDITORIUM FEATURE LIGHTING					1				1332	697									9
CORRIDOR LIGHTING 3/4" #12 #12 #12 20 1 1623 2005 1433 1521 1430 1521 1430 1430 1521 1430 1521 1430 1521 1430 1521 1430 1521 1430 1521 15		PARKING LOT LIGHTING	3/4"	#12	#12		1		820	714									3/4"	EXTERIOR WALLPACK LIGHTING	-
CLASSROOM LIGHTING 3/4" #12 #12 20 1 I I I I I I I I I		CHOIR & BAND LIGHTING	3/4"	#12	#12	20	1						2005	1623) 1	‡ 12 :	#12	3/4"	CORRIDOR LIGHTING	13
19 SPARE 20 1 0 200	HTING	AUDITORIUM FEATURE LIGHTING	3/4"	#12	#12	20	1				1521	1433) 1	<i>‡</i> 12 2	#12	3/4"	AUDITORIUM FEATURE LIGHTING	15
21 SPARE	3	MEZZANINE LIGHTING	3/4"	#12	#12	20	1		984	878) 1	<i>‡</i> 12 :	#12	3/4"	CLASSROOM LIGHTING	17
AUDITORIUM FEATURE LIGHTING 3/4" #12 #12 20 1		TF3	3/4"	#10	#10	25	3						2000	0) 1	:			SPARE	19
25 SPARE											2000	0) 1	:			SPARE	21
27 SPARE 20 1									2000	1521) 1	‡ 12 :	#12	3/4"	AUDITORIUM FEATURE LIGHTING	23
29 SPARE 20 1 0 0 1 20 SPARE 31 SPARE 20 1 0 0 1 20 SPARE 33 SPARE 20 1 0 0 1 20 SPARE 35 SPARE 20 1 0 0 1 20 SPARE 37 SPARE 20 1 0 0 1 20 SPARE 39 SPARE 20 1 0 0 1 20 SPARE 41 SPARE 20 1 0 0 <td< td=""><td></td><td>SPARE</td><td></td><td></td><td></td><td>20</td><td>1</td><td></td><td></td><td></td><td></td><td></td><td>0</td><td>0</td><td></td><td>) 1</td><td> 2</td><td></td><td></td><td>SPARE</td><td>25</td></td<>		SPARE				20	1						0	0) 1	2			SPARE	25
SPARE		SPARE				20	1				0	0) 1	2			SPARE	27
SPARE 20 1 0 0 0 1 20 SPARE 35 SPARE 20 1 0 0 0 1 20 SPARE 37 SPARE 20 1 0 0 0 1 20 SPARE 39 SPARE 20 1 0 0 0 1 20 SPARE 41 SPARE 20 1 0 0 0 0 1 20 SPARE SPARE SPARE SPARE SPARE SPARE SPARE		SPARE				20	1		0	0) 1	2			SPARE	29
SPARE 20 1 0 0 0 1 20 SPARE 37 SPARE 20 1 0 0 0 0 1 20 SPARE 39 SPARE 20 1 0 0 0 0 1 20 SPARE 41 SPARE 20 1 0 0 0 0 0 1 20 SPARE SPARE SPARE SPAR		SPARE				20	1						0	0) 1	:			SPARE	31
SPARE 20 1 0 0 0 0 0 0 0 0		SPARE				20	1				0	0) 1	:			SPARE	33
39 SPARE 20 1 0 0 0 1 20 SPARE 41 SPARE 20 1 0 0 0 1 20 SPARE CONNECTED PHASE LOAD 7856 VA 7848 VA 7907 VA *PHASE DIVERSIFIED LOAD 9321 VA 9312 VA 9382 VA *CALCULATED PANEL AMPS:	;	SPARE				20	1		0	0) 1	:			SPARE	35
41 SPARE 20 1 20 1 0 0 0 1 20 SPARE CONNECTED PHASE LOAD 7856 VA 7848 VA 7907 VA *PHASE DIVERSIFIED LOAD 9321 VA 9312 VA 9382 VA *CALCULATED PANEL AMPS:	;	SPARE				20	1						0	0) 1	:			SPARE	37
CONNECTED PHASE LOAD 7856 VA 7848 VA 7907 VA *PHASE DIVERSIFIED LOAD 9321 VA 9312 VA 9382 VA CALCULATED PANEL AMPS:		SPARE		-		20	1				0	0) 1	2			SPARE	39
*PHASE DIVERSIFIED LOAD 9321 VA 9312 VA 9382 VA CALCULATED PANEL AMPS:		SPARE				20	1		0	0) 1	2			SPARE	41
*PHASE DIVERSIFIED LOAD 9321 VA 9312 VA 9382 VA		I ATED DANEL AMDS:	CVI CI II						7 VA	7907	3 VA	7848	6 VA	7856	LOAD	ASE	ED P	ONNECT	(
*PHASE DIVERSIFIED AMPS 34 A 34 A 34 A 42 A		LAILU FANEL AWF3.	CALCUL	,					2 VA	9382	2 VA	9312	1 VA	932	LOAD	FIED	/ERS	HASE DI	*F		
		42 A]	1 A	34	Α	34	ŀΑ	34	AMPS	FIED	/ERS	HASE DI	*F		
(*DIVERSIFIED LOADS CALCULATED PER THE NATIONAL ELECT	CTRIC COD	D PER THE NATIONAL ELECTRIC	ULATE	S CALC	OAD:	ED L	SIFI	DIVER	(*			1	-						,		,

	PANEL NAME: "HP2"		LO	CATI FED			CH 100 P"	Α				OLTAG LOSUR			3Ph	ı, 4W	1			N TYPE: MLO NG (A): 225 A	
			МО	UNTI	NG:	SUF	RFACE			M		CTURE EL TYP		JARE [)	Г	1			NG (A): 225 A NG (A): 25000	
скт	LOAD DESCRIPTION	С	w	G	СВ	Р	TYPE	1	A	ı	В	(TYPE	Р	СВ	G	W	С	LOAD DESCRIPTION	CH
1	TF2	1"	#4	#8	70	3		8618	8480						3	50	#10	#8	3/4"	RTU7	2
3							-			3759	8480										4
5							-					4230	8480								(
7	RESTROOM & STORAGE LIGHTING	3/4"	#12	#12	20	1		1078	6928						3	40	#10	#8	3/4"	RTU8	
9	LOBBY LIGHTING	3/4"	#10	#10	20	1				3576	6928										1
11	LOBBY LIGHTING	3/4"	#12	#12	20	1						2688	6928								1
13	LOBBY FEATURE LIGHTING	3/4"	#12	#12	20	1		556	0						1	20				SPARE	1
15	SPARE				20	1				0	0				1	20				SPARE	1
17	SPARE				20	1	-					0	0		1	20				SPARE	1
19	SPARE				20	1		0	0						1	20				SPARE	2
21	SPARE				20	1				0	0				1	20				SPARE	2
23	SPARE				20	1						0	0		1	20				SPARE	2
25	SPARE				20	1		0	0						1	20				SPARE	2
27	SPARE				20	1				0	0				1	20				SPARE	2
29	SPARE				20	1						0	0		1	20				SPARE	3
31	SPARE				20	1		0	0						1	20				SPARE	3
33	SPARE				20	1				0	0				1	20				SPARE	3
35	SPARE				20	1						0	0		1	20				SPARE	3
37	SPARE				20	1		0	0						1	20				SPARE	3
39	SPARE				20	1				0	0				1	20				SPARE	4
41	SPARE				20	1						0	0		1	20				SPARE	4
			CONNE						60 VA		3 VA	2232						(CALCUL AT	TED PANEL AMPS:	
		*1	PHASE	DIVE	RSIFI	ED	LOAD	2704	AV 84	2397	'4 VA	2353	4 VA					•		/	
		*	PHASE	DIVEF	RSIFI	ED .	AMPS	98	3 A	87	' A	85	Α							122 A	
													(*	DIVER	SIF	IED I	OAD	SCALC		PER THE NATIONAL ELECTRIC	CODE
I .	S/ACCESSORIES:																			ANEL TOTALS	
1. PRC	OVIDE SPARE 20A, SINGLE-POLE	BREAK	ERS IN	ALL U	NUS	ED :	SPACE	ES.									TOTA	L CON	NECTED L	.OAD: 70730 VA	
2. CH,	, FL, GB,																TOTA	AL DIVE	RSIFIED L	. OAD : 74556 VA	
ĺ																		CONTE	OLLINGI	OAD: HEATING	

CIRCUIT BREAKER PANELBOARD SCHEDULE

	PANEL NAME: "MDP"	FED BY:	: ELECTRICAL : NEMA 1				BUS RAT MCB RAT MIN. AIC RAT	S TYPE: MLO ING (A): 800 A FING(A): 800 A ING (A): 42000 / TYPE: SQUAF	RE D / I-LINE	
СКТ	LOAD DESCRIPTION	TYPE	С	W	G	Р	СВ	Α	В	С
1	HP1		2"	#3/0	#4	3	200 A	7856 VA	7848 VA	7907 VA
2	HP2		2"	#3/0	#4	3	200 A	25660 VA	22743 VA	22326 VA
3	TF1		1-1/4"	#2	#6	3	110 A	16480 VA	16424 VA	16384 VA
4	RTU1		1-1/4"	#1	#8	3	90 A	18069 VA	18069 VA	18069 VA
5	RTU2		1-1/4"	#1	#8	3	90 A	19371 VA	19371 VA	19371 VA
6	EV CHARGER		1"	#3	#8	3	80 A	16667 VA	16667 VA	16667 VA
7	EV CHARGER		1"	#3	#8	3	80 A	16667 VA	16667 VA	16667 VA
8	SURGE PROTECTION DEVICE		1"	#3	#8	3	100 A	10 VA	10 VA	10 VA
9	RTU3		3/4"	#8	#10	3	35 A	6041 VA	6041 VA	6041 VA
10	RTU4		3/4"	#8	#10	3	35 A	6041 VA	6041 VA	6041 VA
11	RTU5		3/4"	#8	#10	3	35 A	6041 VA	6041 VA	6041 VA
12	RTU6		3/4"	#8	#10	3	35 A	6097 VA	6097 VA	6097 VA
13	SPACE					1				
14	SPACE					1				
15	SPACE					1				
OTES	S/ACCESSORIES:				CONN	ECTED PH	IASE LOAD:	145001 VA	142020 VA	141622 VA
2. GB,	SER, SPD				PHAS	E DIVERSI	FIED LOAD:	155507 VA	152311 VA	151883 VA
					PHAS	E DIVERSI	FIED AMPS:	562 A	550 A	550 A
					CALCU	ILATED PA	NEL AMPS:		702 A	
						CONTROL	LING LOAD:		HEATING	



637 COLLEGE STREET SPRINGFIELD, MO 65806

PH: 417.885.0002 www.paragonarchitecture.com

3333 E. Battlefield Rd | Suite 1000 Springfield, MO 65804 417.881.0020 | www.rtmec.com STATE OF MISSOURI CERTIFICATE OF AUTHORITY:

2014035826 FOR ENGINEERING

TOTAL DIVERSIFIED LOAD: 28015 VA CONTROLLING LOAD: N/A



COPYRIGHT 2023 ©
THESE PRINTS ARE THE PROPERTY OF PARAGON
ARCHITECTURE, LLC AND SHALL BE USED ONLY FOR THE
PROJECT REFERENCE BELOW

REVISION SCHEDULE

CASSVILLE HS: PERFORMING CENTER

PROJECT ENGINEER: JAL DRAWN BY: CHECKED BY:

PROJECT NUMBER: 21-620

DATE: 05-17-2023

ELECTRICAL SCHEDULES

SHEET NUMBER: